




Strong Schools, Stronger Communities

MPS GLENSIDE FOR MUSKEGON PUBLIC SCHOOLS

1213 W Hackley Ave, Muskegon, MI 49441
ISSUED FOR: CONSTRUCTION DOCUMENTS

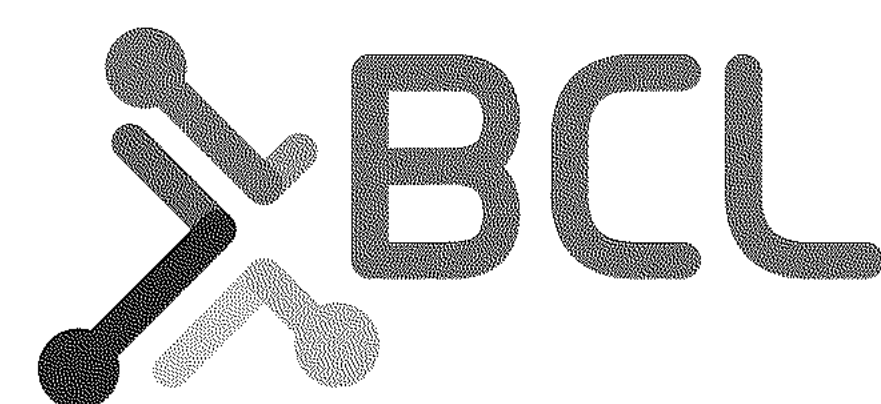

MPS GLENSIDE
MUSKEGON PUBLIC SCHOOLS
1213 W Hackley Ave, Muskegon, MI 49441

REVISIONS

SYM DATE ISSUED FOR

ISSUE DATE

03.08.2024

SHEET NAME

COVER SHEET

SHEET NUMBER

G001

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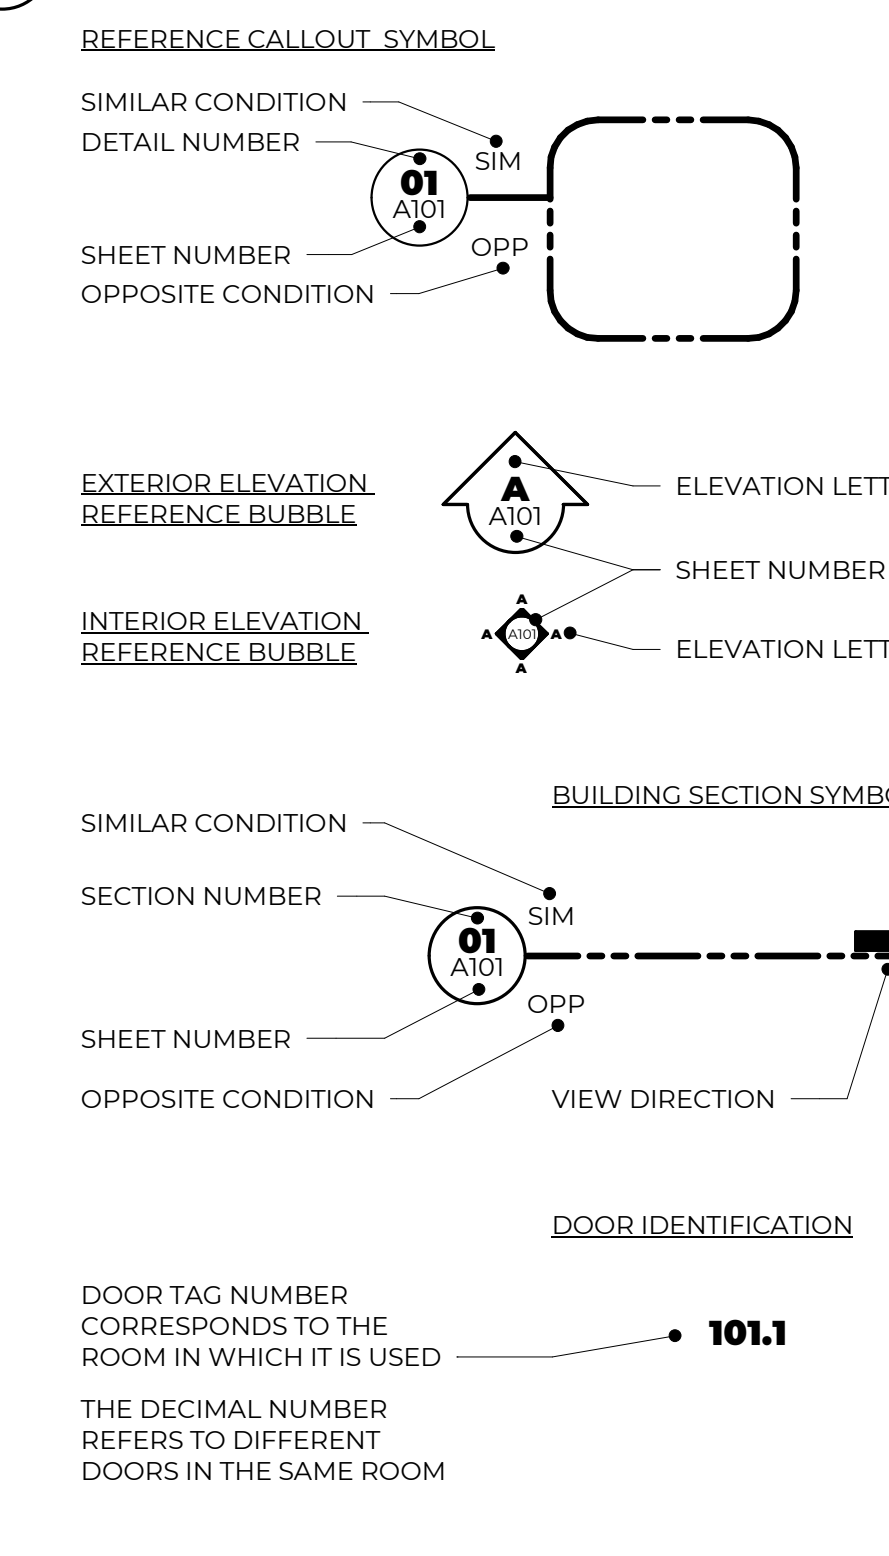
REVISIONS

SYM DATE ISSUED FOR

ISSUE DATE 03.08.2024
SHEET NAME INDEX, NOTES, MOUNTING HEIGHTS, PART, TYPES AND ACCESSIBILITY REQS.

SHEET NUMBER
G002

LC ND TYPICAL SYMBOLS & REFERENCES



SHEET LIST

| SHEET # | SHEET NAME |
|-----------------------|---|
| GENERAL | |
| G001 | COVER SHEET |
| G002 | INDEX, NOTES, MOUNTING HEIGHTS, PART, TYPES AND ACCESSIBILITY REQS. |
| G101 | FIRST AND SECOND FLOOR CODE COMPLIANCE PLANS |
| CIVIL | |
| C 101 | SITE PLAN |
| STRUCTURAL | |
| S001 | STRUCTURAL NOTES |
| S10A | FOUNDATION PLAN - UNIT A |
| S30A | ROOF FRAMING PLAN - UNIT A |
| S30B | ROOF FRAMING PLAN - UNIT B |
| DEMOLITION | |
| D10A | FIRST FLOOR DEMOLITION PLAN - UNIT A |
| D10B | DEMOLITION PLANS - UNIT B |
| D103 | ROOF DEMOLITION PLAN |
| D201A | FIRST FLOOR REFLECTED CEILING DEMOLITION PLAN - UNIT A |
| D201B | 1ST AND 2ND FLOOR REFLECTED CEILING DEMOLITION PLAN - UNIT B |
| ARCHITECTURAL | |
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| A10A | FIRST FLOOR PLAN - UNIT A |
| A10B | FIRST AND SECOND FLOOR PLANS - UNIT B |
| A103 | ROOF PLAN |
| A105 | BUILDING WINDOW PLAN - ALTERNATE 01 & ALTERNATE 02 |
| A106 | STOREFRONT WINDOW FRAME ELEVATIONS |
| A201A | FIRST FLOOR REFLECTED CEILING PLAN - UNIT A |
| A201B | 1ST AND 2ND FLOOR REFLECTED CEILING PLAN - UNIT B |
| A301 | BUILDING ELEVATIONS - BASE BID |
| A302 | BUILDING ELEVATIONS - ALT. 01 |
| A303 | INTERIOR PERSPECTIVES |
| A421 | DETAILS |
| A601 | DOOR SCHEDULES & DOOR PERSPECTIVES |
| INTERIORS | |
| I001 | MATERIAL SELECTION SCHEDULE |
| I01A | FIRST FLOOR FINISH PLAN |
| I01B | SECOND FLOOR FINISH PLAN |
| PLUMBING DEMOLITION | |
| D501 | FOUNDATION PLUMBING DEMOLITION PLAN - UNIT A |
| D502 | FIRST FLOOR PLUMBING DEMOLITION PLAN - UNIT A |
| D503 | FIRST FLOOR PLUMBING DEMOLITION PLAN - UNIT B |
| PLUMBING | |
| P001 | GENERAL NOTES, LEGEND, SCHEDULES, AND DETAILS |
| P101 | FOUNDATION PLUMBING PLAN - UNIT A |
| P102 | FIRST FLOOR PLUMBING PLAN - UNIT A |
| P103 | FIRST AND SECOND FLOOR PLUMBING PLAN - UNIT B |
| P104 | ROOF PLUMBING PLAN |
| MECHANICAL DEMOLITION | |
| D601 | FIRST FLOOR MECHANICAL DEMOLITION PLAN - UNIT A |
| D602 | MECHANICAL DEMOLITION PLANS - UNIT B |
| MECHANICAL | |
| M001 | GENERAL NOTES AND LEGEND |
| M101 | FIRST FLOOR MECHANICAL PLAN - UNIT A |
| M102 | MECHANICAL PLANS - UNIT B |
| M103 | ROOF MECHANICAL PLAN - UNIT A |
| M104 | ROOF MECHANICAL PLAN - UNIT B |
| M201 | ENLARGED PLANS AND SECTIONS |
| M301 | SCHEMATICS |
| M401 | CONTROLS |
| M402 | CONTROLS |
| M403 | CONTROLS |
| M404 | CONTROLS |
| M405 | CONTROLS |
| M501 | SCHEDULES |
| M502 | SCHEDULES |
| M601 | DETAILS |
| M602 | DETAILS |
| ELECTRICAL DEMOLITION | |
| D701A | FIRST FLOOR ELECTRICAL DEMOLITION PLAN - UNIT A |
| D701B | FIRST FLOOR ELECTRICAL DEMOLITION PLAN - UNIT B |
| D702 | BASEMENT AND SECOND FLOOR ELECTRICAL DEMOLITION PLAN |
| ELECTRICAL | |
| E001 | LEGENDS AND GENERAL NOTES |
| E002 | SCHEDULES |
| E010 | ELECTRICAL SITE PLAN |
| E101A | FIRST FLOOR LIGHTING PLAN - UNIT A |
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| E201A | FIRST FLOOR POWER AND SYSTEMS PLAN - UNIT A |
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| E301 | ROOF PLAN |
| E401 | EXISTING ONE LINE DIAGRAM |
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| E501 | ELECTRICAL DETAILS |
| E601 | PANELBOARD SCHEDULES |
| TECHNOLOGY | |
| TD101 | TECHNOLOGY DEMOLITION FIRST FLOOR PLAN - UNIT A |
| TD102 | TECHNOLOGY DEMOLITION FIRST AND SECOND FLOOR PLAN - UNIT B |
| TECHNOLOGY | |
| T-001 | TECHNOLOGY LEGENDS |
| T-002 | TECHNOLOGY NOTES |
| T-010 | TECHNOLOGY SITE PLAN |
| T-101 | TECHNOLOGY AND SECURITY FIRST FLOOR PLAN - UNIT A |
| T-102 | TECHNOLOGY AND SECURITY FIRST AND SECOND FLOOR PLAN - UNIT B |
| T-401 | TECHNOLOGY ROOMS AND ELEVATIONS |
| T-501 | TECHNOLOGY DETAILS |
| T-502 | SECURITY DETAILS |
| T-503 | TECHNOLOGY DETAILS |
| T-601 | TECHNOLOGY SECURITY SCHEDULES |
| T-701 | TECHNOLOGY SECURITY ONE LINE DIAGRAMS |
| T-702 | TECHNOLOGY SECURITY ONE LINE DIAGRAMS |


NO TE GENERAL ARCHITECTURAL NOTES

- THE OWNER RESERVES THE RIGHT TO REMOVE ANY ITEM FROM THE PROJECT PRIOR TO COMMENCEMENT OF CONTRACTED DEMOLITION WORK.
- ALL EXISTING CONDITIONS SHOULD BE FIELD VERIFIED BEFORE WORK BEGINS.
- DIMENSIONS GIVEN ARE ACTUAL AND ARE TO THE FACE OF MASONRY UNITS OR TO THE FACE OF STUD FRAMING, UNLESS NOTED OTHERWISE.
- DETAILS SHOWN ILLUSTRATE DESIGN INTENT, NOT ALL POSSIBLE CONDITIONS. FOR CONDITIONS NOT SHOWN, USE DETAILS CLOSEST TO CONDITION IN QUESTION.
- EXTEND ALL INTERIOR WALL PARTITIONS FROM FLOOR TO STRUCTURE/DECK ABOVE UNLESS NOTED OR DETAILED OTHERWISE.
- WITHIN BUILDING INTERIOR PROVIDE BULLNOSE BLOCK IN CMU WALL ASSEMBLIES AT ALL EXPOSED OUTSIDE CORNERS, INCLUDING WINDOW AND DOOR JAMBS, UNLESS NOTED OR DETAILED OTHERWISE. PROVIDE SQUARE OUTSIDE CORNERS AT ALL LOCATIONS FINISHED WITH WALL TILE, REFER TO FINISH PLANS (I-SHEETS) FOR LOCATIONS.
- TOOTH-IN MASONRY AT NEW OPENINGS IN EXISTING WALLS.
- TOOTH-IN NEW MASONRY INFILL INTO EXISTING OPENINGS AT ALL BULLNOSE BLOCK LOCATIONS.
- STUD WALLS SPANNING OVER 12'-0" IN HEIGHT SHALL BE A MINIMUM OF 20 GAUGE.
- STUD WALL SUPPORTING WALL CABINETS SHALL BE A MINIMUM OF 20 GAUGE.
- DOORS ARE TO BE 4" FROM CORNER OF ROOM, UNLESS NOTED OR DIMENSIONED OTHERWISE.
- FIRESTOP ALL INTERCONNECTIONS BETWEEN VERTICAL AND HORIZONTAL SPACES AND CONCEALED WALL SPACES AT CEILING, FLOOR AND ROOF LEVELS.
- FIRESEAL ALL PENETRATIONS, SUCH AS PIPES, DUCTS, CONDUITS, ETC. THROUGH FIRE AND/OR SMOKE RATED ASSEMBLIES.
- PAINT ALL ELECTRICAL PANEL COVERS AND ACCESS PANELS TO MATCH ADJACENT FINISHES. USING OIL-BASED PAINT, NOT LATEX WALL PAINT.
- PROVIDE WOOD BLOCKING IN WALLS THAT REQUIRE WALL MOUNTED EQUIPMENT OR ACCESSORIES. COORDINATE WITH EQUIPMENT OR ACCESSORY MANUFACTURER.
- PROVIDE ALL ASSOCIATED CURBS FOR ROOF TOP EQUIPMENT AND MECHANICAL ROOF TOP UNITS. LARGE VOIDS BELOW THE AIR HANDLING UNITS SHALL BE FILLED WITH INSULATION AS SPECIFIED FOR NOISE CONTROL.
- ALL EXISTING ROOF TOP PENETRATIONS BEING REMOVED REQUIRE ROOF PATCHING TO MATCH EXISTING ADJACENT.
- ALL TOILET ROOM ACCESSORIES INCLUDING ALL REQUIRED GRAB BARS, SOAP DISPENSERS, MIRRORS, PAPER TOWEL DISPENSERS, SANITARY NAPKIN DISPOSALS, TOILET PAPER DISPENSERS, AND BABY CHANGING TABLES ARE TO BE CONTRACTOR FURNISHED AND CONTRACTOR INSTALLED UNLESS NOTED OTHERWISE.


NO TE GENERAL PARTITION NOTES

- NOT ALL WALL TYPES MAY BE USED ON PROJECT.
- REFER TO CODE COMPLIANCE PLANS FOR LOCATIONS OF SMOKE AND FIRE-RATED PARTITIONS.
- ALL PARTITIONS EXTEND TO BOTTOM OF STRUCTURE, UNLESS NOTED OTHERWISE.
- LINE OF STRUCTURE/DECK AS SHOWN AT THE HEAD CONDITION OF EACH PARTITION TYPE IS DIAGRAMMATIC ONLY AND DOES NOT INDICATE EXACT CONSTRUCTION CONDITIONS. TERMINATE RATED PARTITIONS AT UNDERSIDE OF STRUCTURAL DECK TO MAINTAIN RATING. PROVIDE APPROPRIATE FRAMING AND GYPSUM BOARD TO OFFSET AROUND STRUCTURE OR OTHER OBSTRUCTIONS, SUCH AS PIPING OR DUCTWORK.
- PARTITIONS MAY TERMINATE AT STRUCTURAL MEMBERS WITH A RATING GREATER THAN OR EQUAL THE PARTITION, PROVIDED THAT RATING IS CONTINUOUS TO STRUCTURAL DECK ABOVE.
- NON-RATED PARTITIONS THAT EXTEND TO STRUCTURE SHALL TERMINATE AT UNDERSIDE OF STRUCTURAL DECK TO MAINTAIN A CONTINUOUS PLANE OF GYPSUM BOARD AS A NOISE, SMOKE OR OTHER TYPE OF BARRIER.
- ALL PARTITIONS EXTENDING TO STRUCTURE ABOVE SHALL TERMINATE WITH DEFLECTION TRACK - SEE TYPICAL DETAILS ON THIS SHEET.
- ALL GYPSUM BOARD PARTITIONS NOT EXTENDING TO THE STRUCTURE MUST BE BRACED.
- UL DESIGN NUMBERS REFER TO THE FIRE RESISTANCE DIRECTORY; UNDERWRITERS LABORATORY, LATEST EDITION.
- MISCELLANEOUS NON-RATED CHASES TO BE 5/8" GYPSUM BOARD ON 3 5/8" METAL STUD FRAMING AT 16" O.C., UNLESS NOTED OTHERWISE.
- MISCELLANEOUS FURRING AROUND COLUMNS TO BE 5/8" GYPSUM BOARD ON 1 1/2" STUDS, UNLESS NOTED OTHERWISE.
- FIRE-RATED PARTITIONS TO HAVE FIRE-STOPPING SEALANTS AT HEAD, SILL JUNCTURE WITH DISSIMILAR MATERIALS, ETC. AND AROUND ALL PENETRATIONS AND OPENINGS.
- CONSTRUCT ALL PARTITIONS WITH SOUND ATTENUATION BATTS WITH THE FOLLOWING SOUND BATT THICKNESS: 2 1/2" OR LESS METAL STUD - 1 1/2" THICKNESS, 3 5/8" OR LARGER METAL STUD - 3" THICKNESS. UNLESS NOTED OTHERWISE.


WALL TYPE - SX METAL STUD WALL

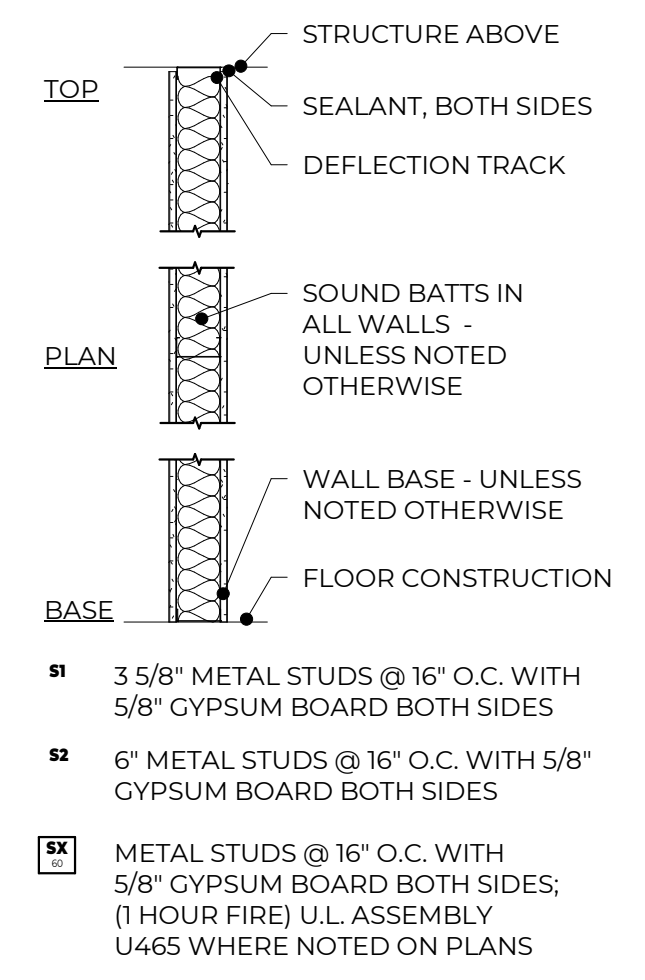




WALL TYPE - SX.5 METAL STUD WALL GYPSUM BOARD ONE SIDE

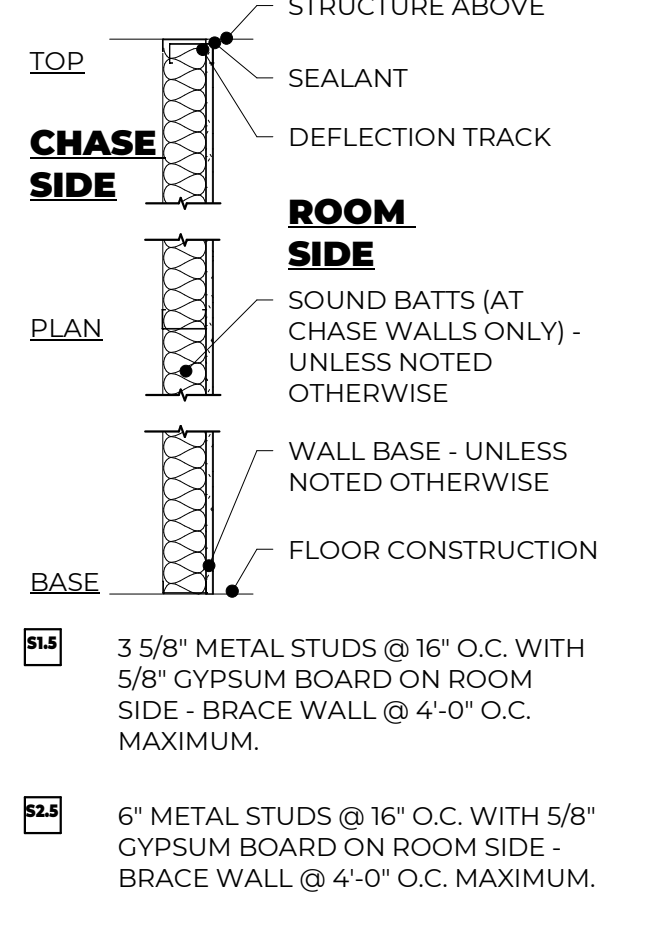

WALL TYPE - MX CMU WALL U.L. ASSEMBLY - U905 (1 HOUR AND 2 HOUR)

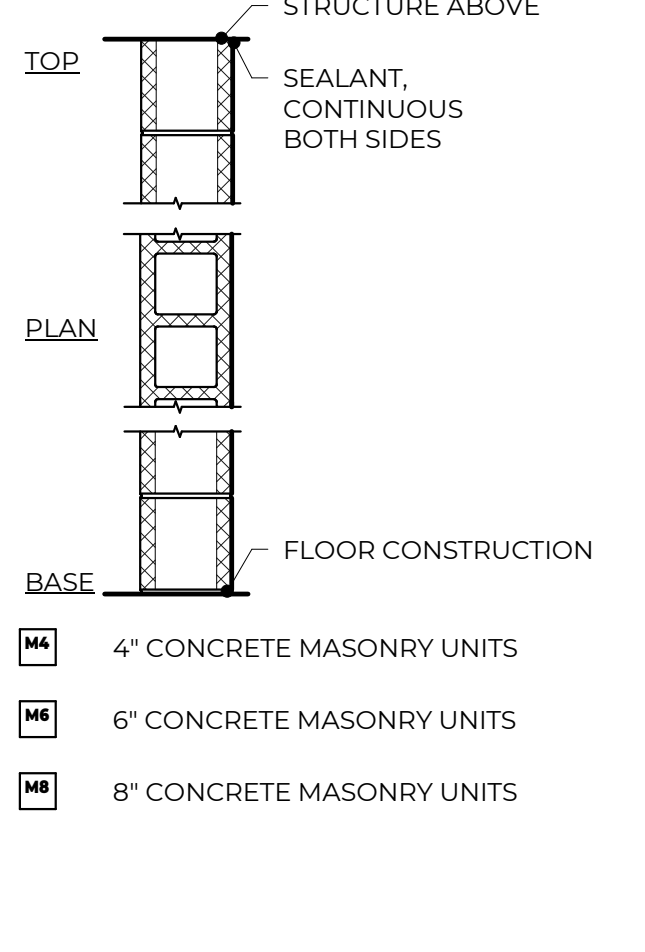

LC ND ACCESSIBLE BUILDING CLEARANCES

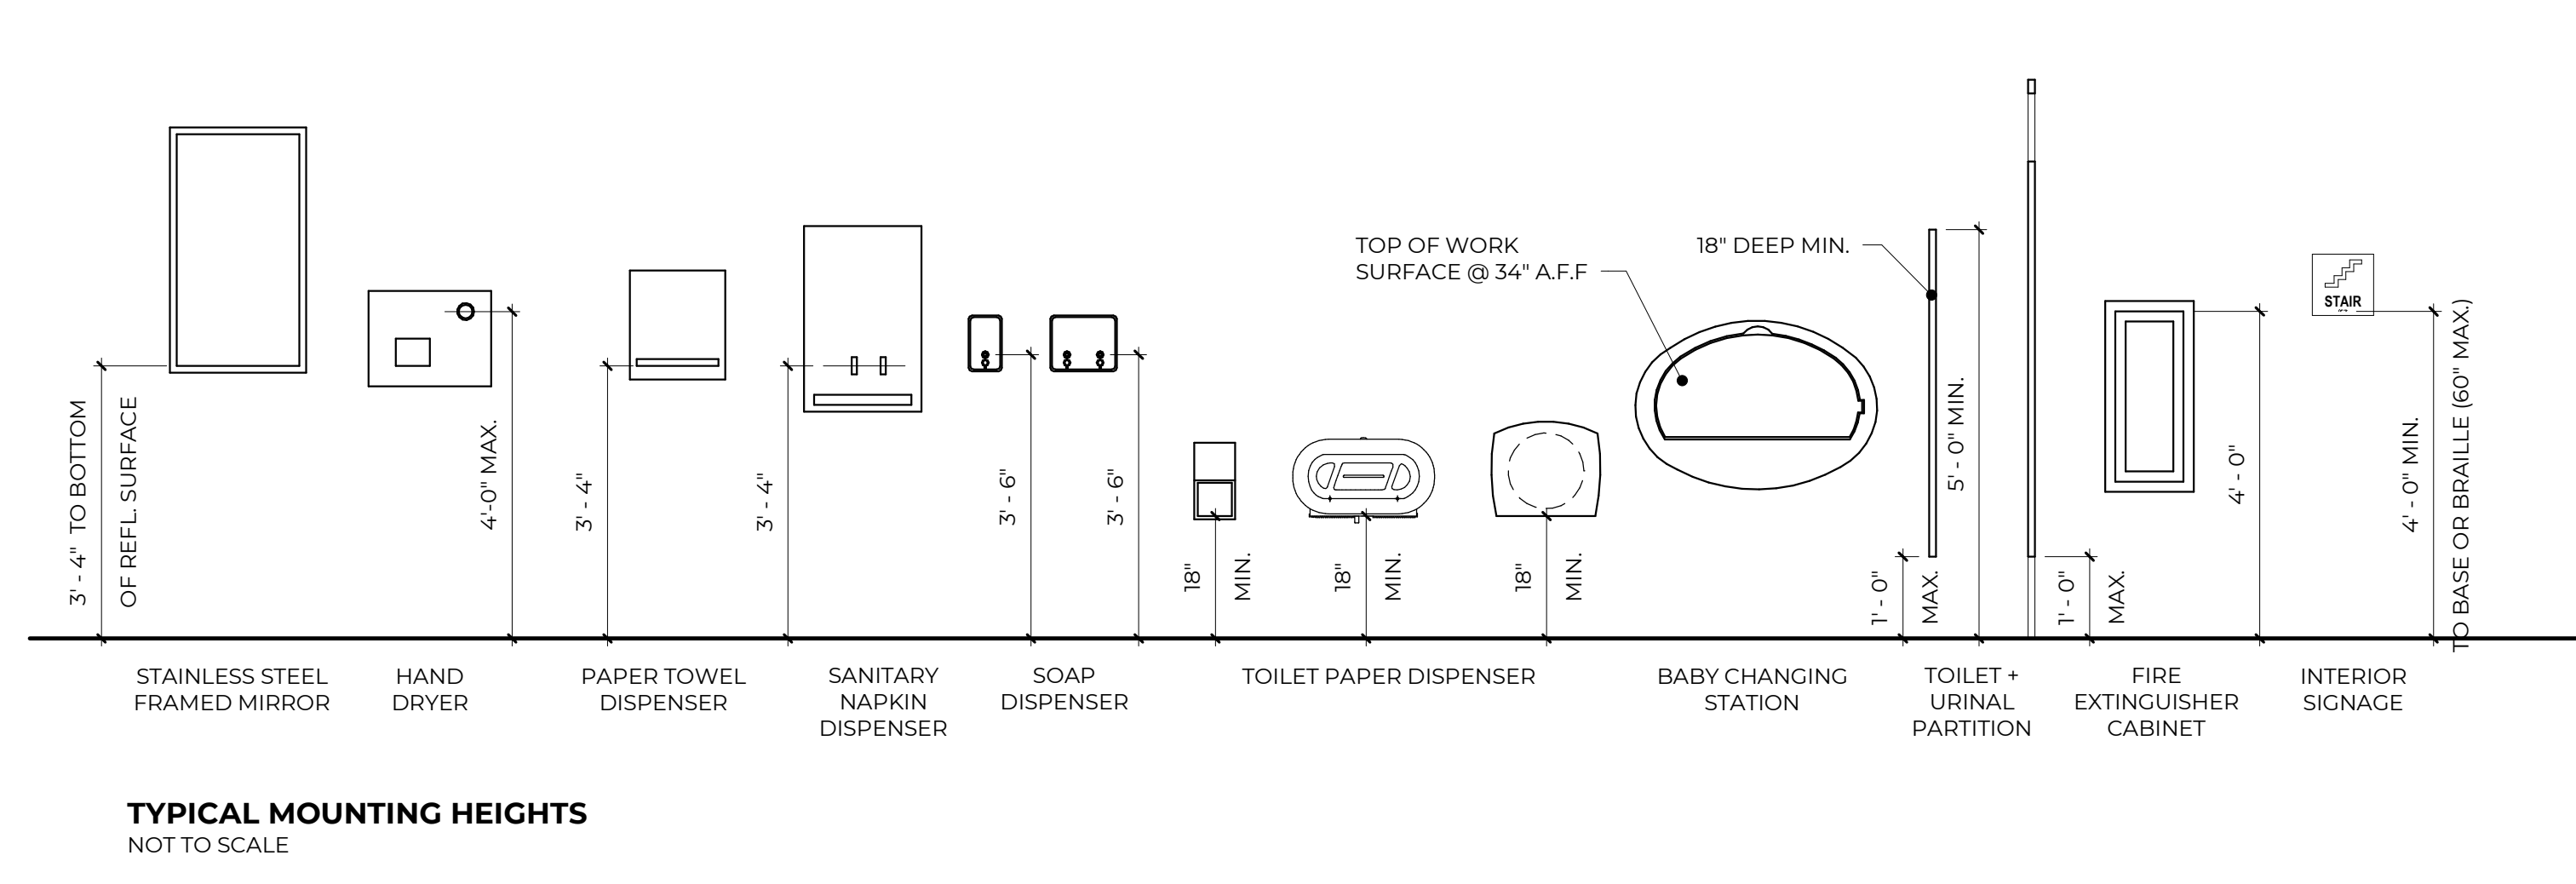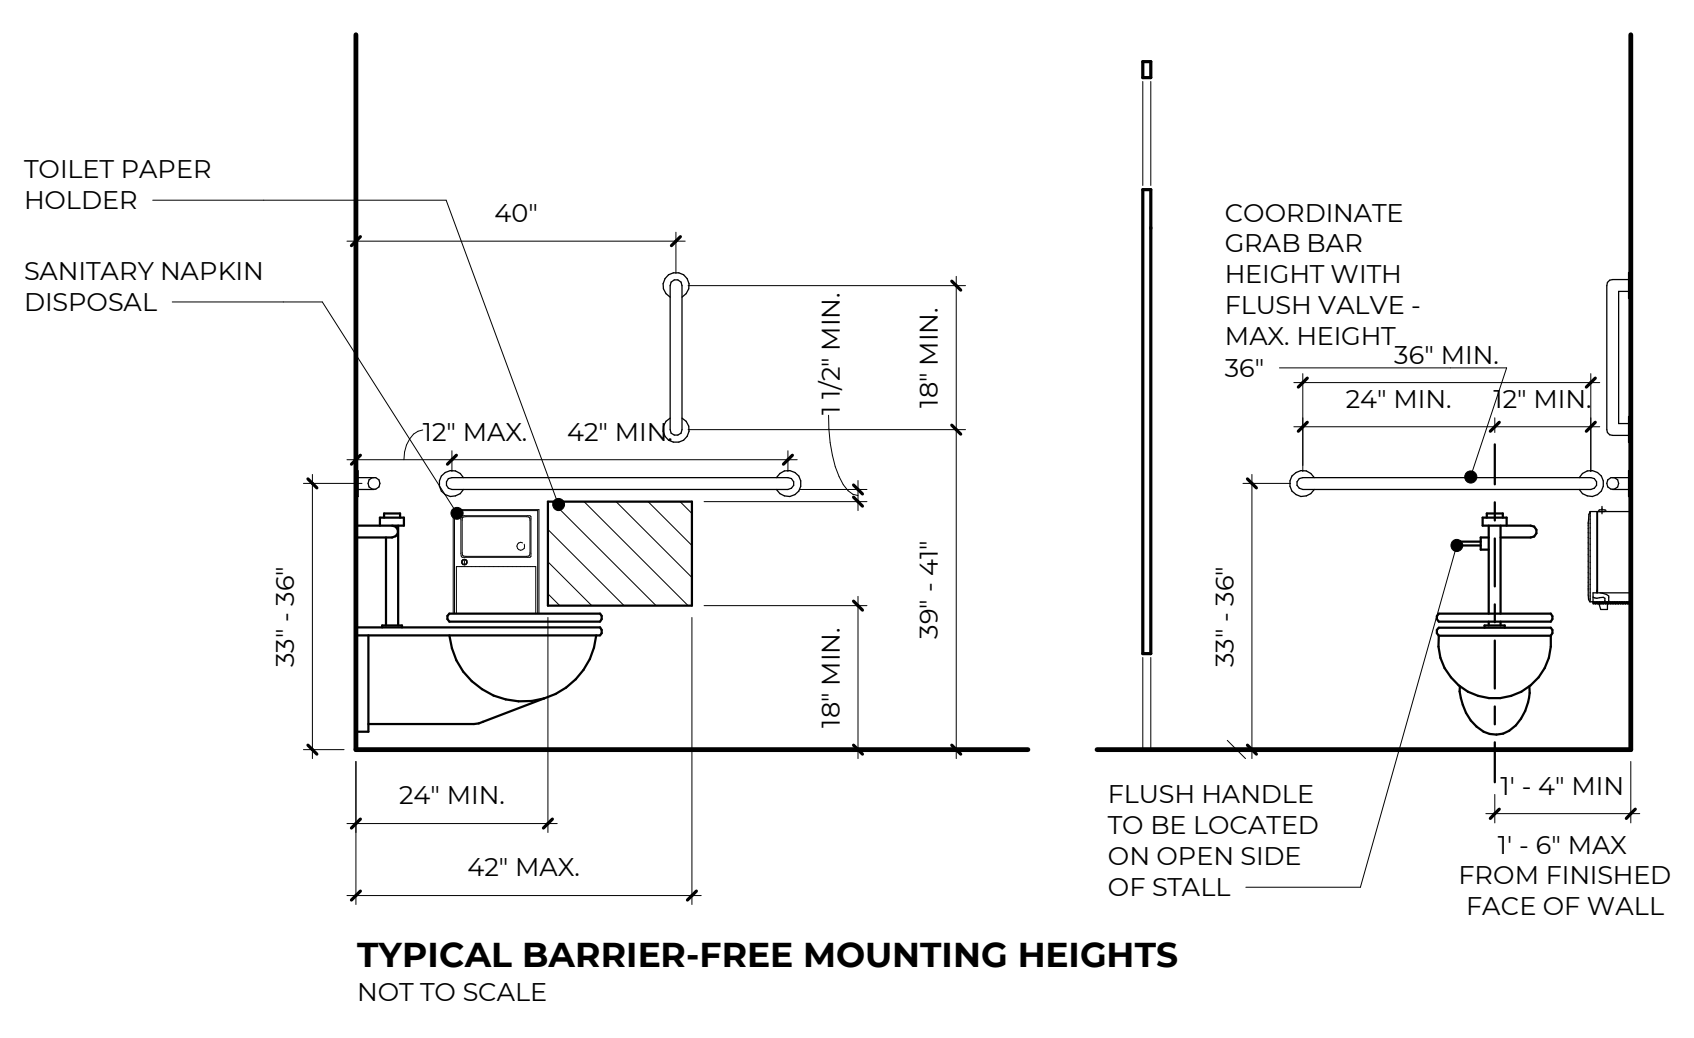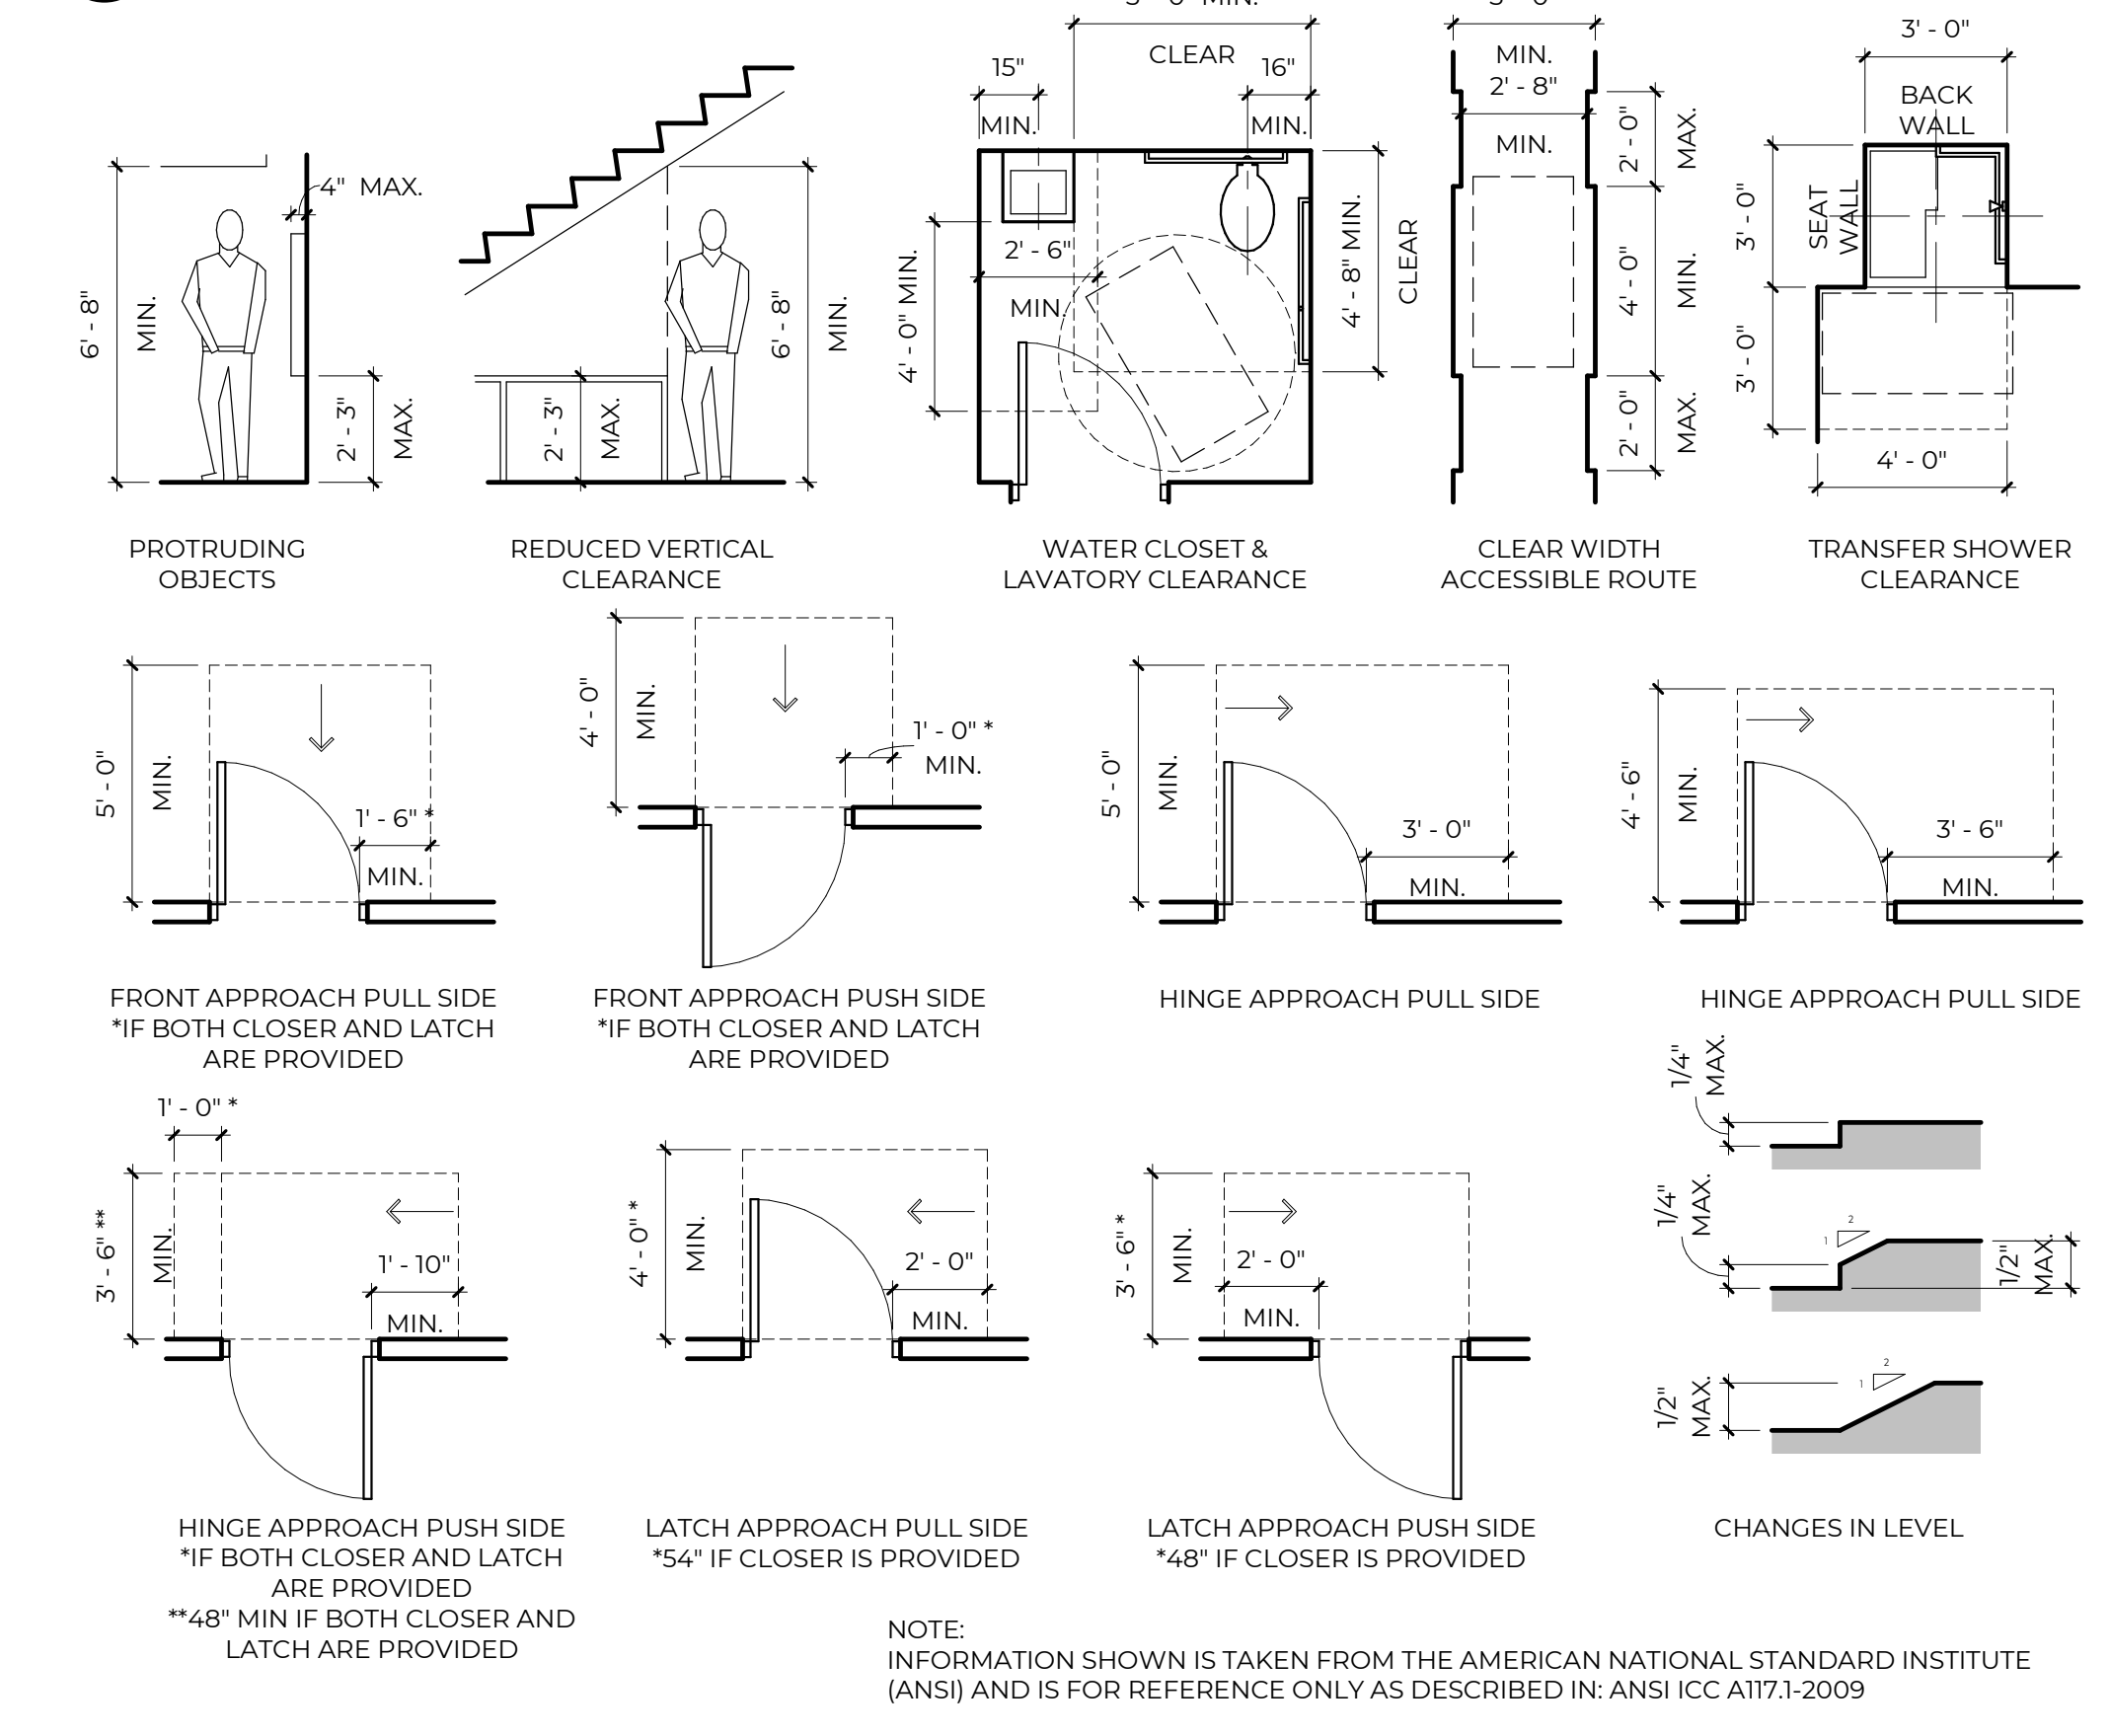

FOR REFERENCE ONLY

CODE SUMMARY

Site Address: 1213 W Hackley Ave. Muskegon, MI 49441

Project Description: The scope of this project involves an office renovation and the renovation of an existing media center into STEAM Lab. Scope will also include ceiling tile demolition throughout the entire school, replacement of some interior finishes and exterior storefront windows.

Local Jurisdiction: City of Muskegon, Michigan

Applicable Building Code: 2015 Michigan Building Code (MBC)
2015 Michigan Mechanical Code (MMC)
2015 Michigan Rehabilitation Code (MRC)
2018 Michigan Plumbing Code (MPC)
2015 Michigan Energy Code (MEC)
Accessibility Code/ANSI/ICC 117.1-2009
NFPA 101 Life Safety Code 2012

Use Group Occupancy: **E - Educational**

Construction Type: **IIB**

Automatic Sprinkler System: Not Suppressed

Allowable Building Area: 14,500 sf

Building Floor Area: 39,916 sf E-Use
The building is an existing non-compliant school - no separation of fire areas is required.

Allowable Building Height: 55'-0"


Allowable Number of Stories: 2 stories

Maximum Common Egress: 75'-0" w/o sprinkler system per MBC Path of 1006.2.1

Maximum Exit Access Distance: 200'-0" w/o sprinkler system per MBC Travel Table 1017.2

Every classroom or other educational use room 250 SF or greater shall have an outside window for emergency rescue unless permitted by the exceptions listed in LSC 15.2.11.1.2.


CODE COMPLIANCE LEGEND

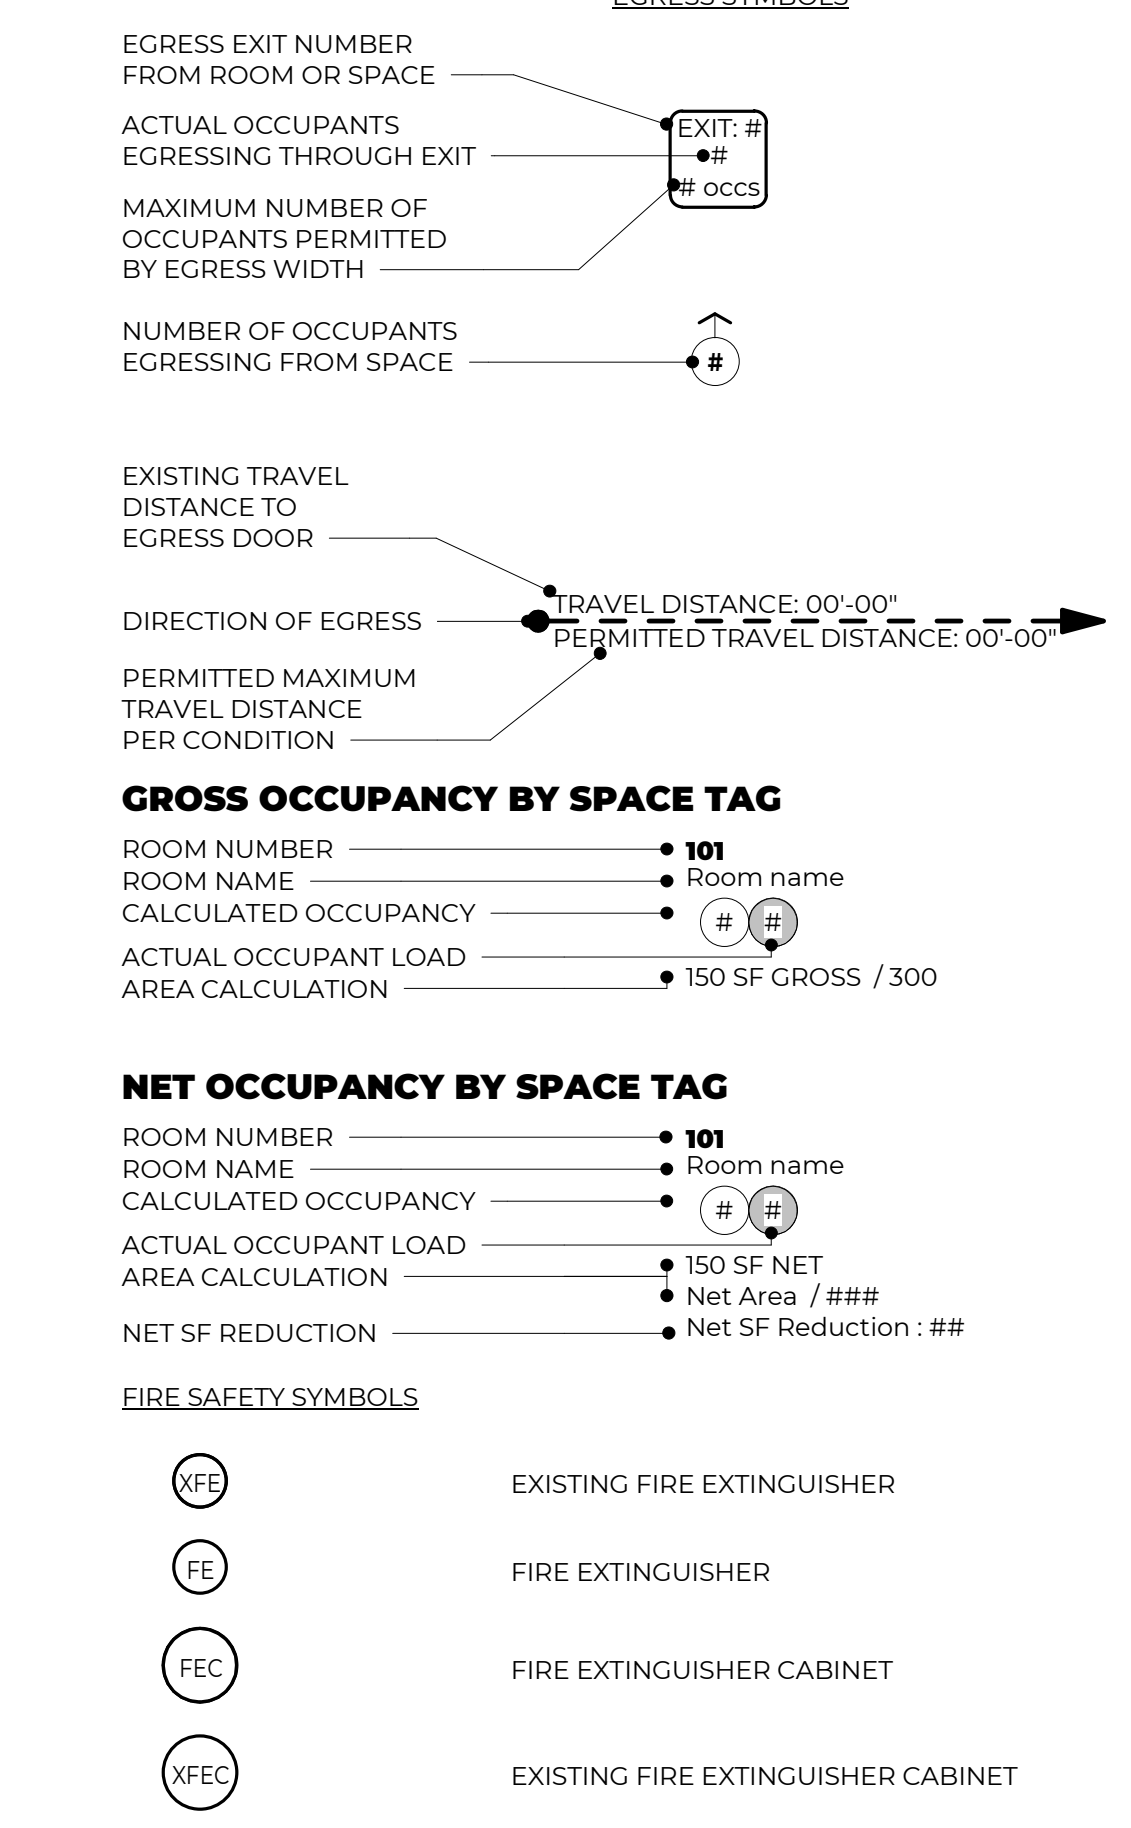


FIRE-RATING KEY

| PARTITION SYMBOL | PARTITION RATING | RATING PRIORITY |
|------------------|-------------------|-----------------|
| --- | 3 HOUR | 01 |
| - - - | 2 HOUR FIRE/SMOKE | 02 |
| - . - . - | 2 HOUR | 03 |
| - . . - . | 1 HOUR FIRE/SMOKE | 04 |
| - . - - - | 1 HOUR | 05 |
| - - - - - | SMOKE RESISTANT | 06 |

- LIGHTER LINES SHOWN ABOVE INDICATE EXISTING FIRE RATED WALLS.
- ALL PENETRATIONS THROUGH A FIRE OR SMOKE RATED PARTITION SHOULD BE SEALED WITH AN APPROVED U.L. RATED PRODUCT.
- THE TOPS OF ALL FIRE RATED PARTITIONS SHALL BE SEALED TO THE CONTINUOUS STRUCTURE ABOVE WITH A U.L. RATED SYSTEM OR ASSEMBLY.
- WOOD BLOCKING IN FIRE-RATED PARTITIONS SHALL BE OF NON-COMBUSTIBLE TREATED WOOD.
- REFER TO SPECIFICATION FOR U.L. RATING INFORMATION.
- FIRE-RATED WALLS ENDING INTO AN ACOUSTICAL DECK MUST HAVE THE FLUTES FILLED REFER TO TOP-OF-WALL DETAIL AT ACOUSTIC DECK SHOWN ON THIS SHEET.
 - FOR MASONRY WALLS THE MASON SHALL FILL VOIDS AND FIRE SPRAY WITH U.L LISTED MATERIAL.
 - FOR STUD WALLS USE FIRE SAFING AND FIRE CAULK.

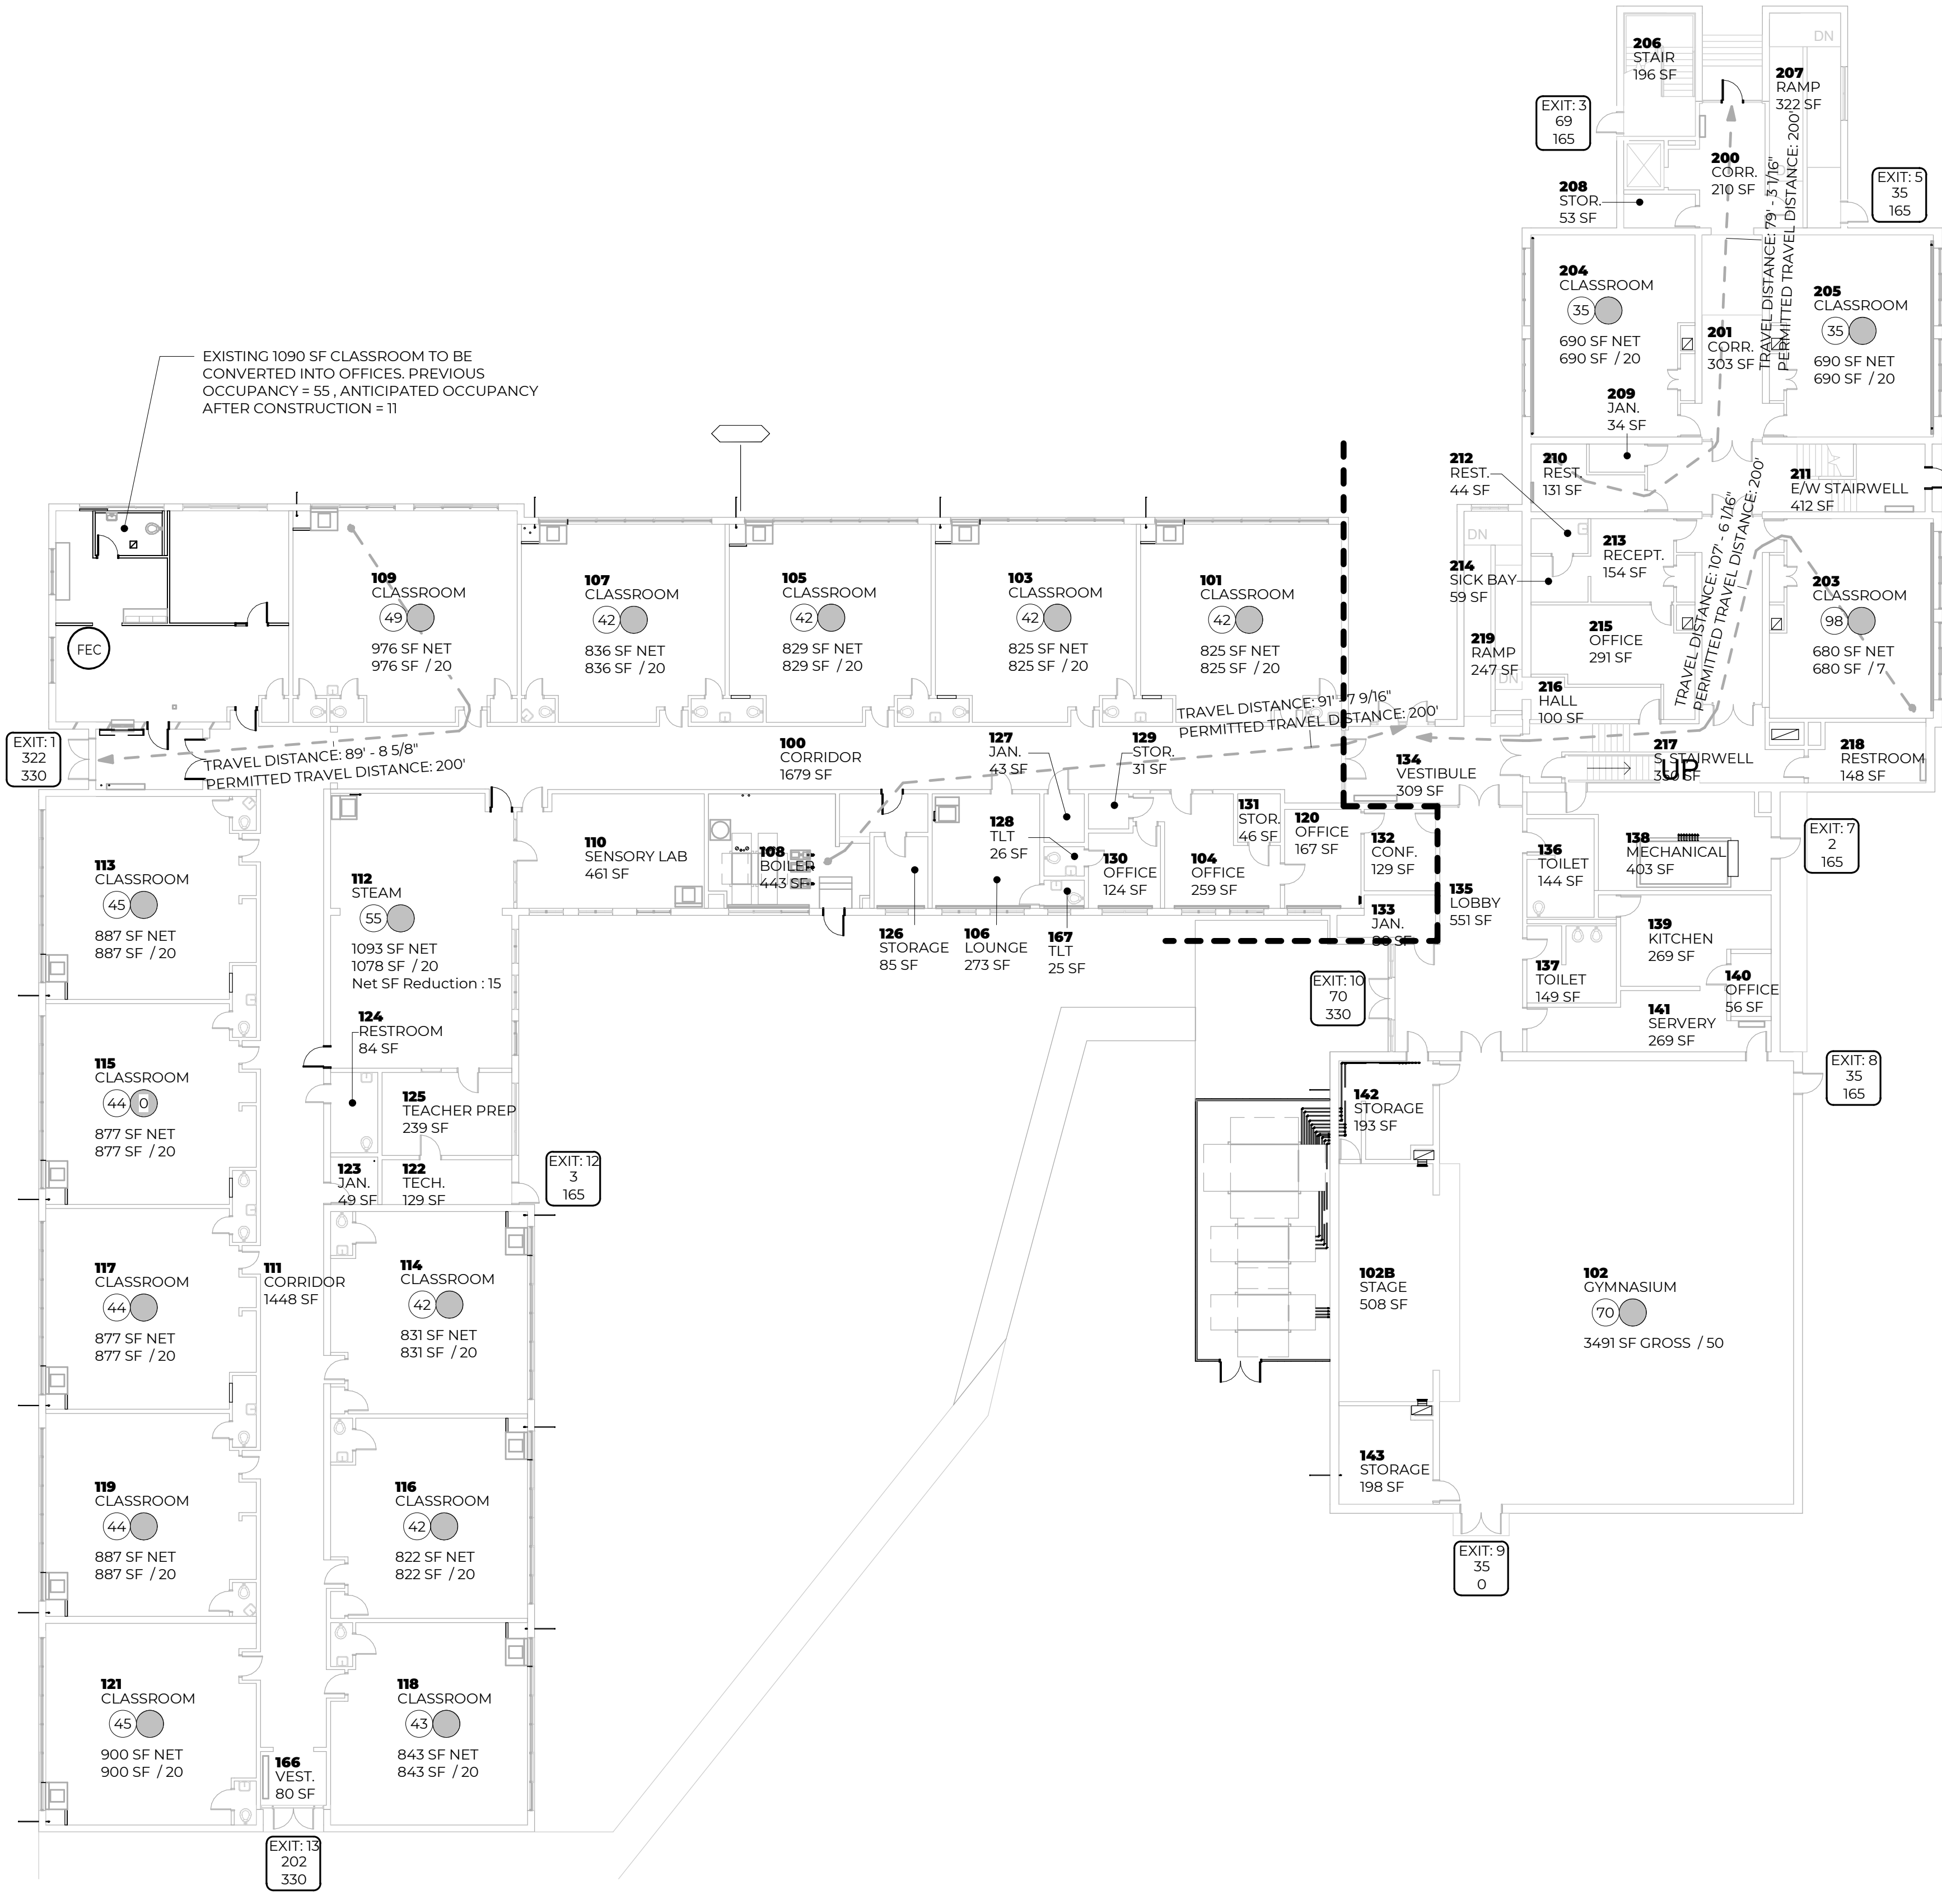

NR TH FIRST FLOOR CODE COMPLIANCE PLAN
1/16" = 1'-0"

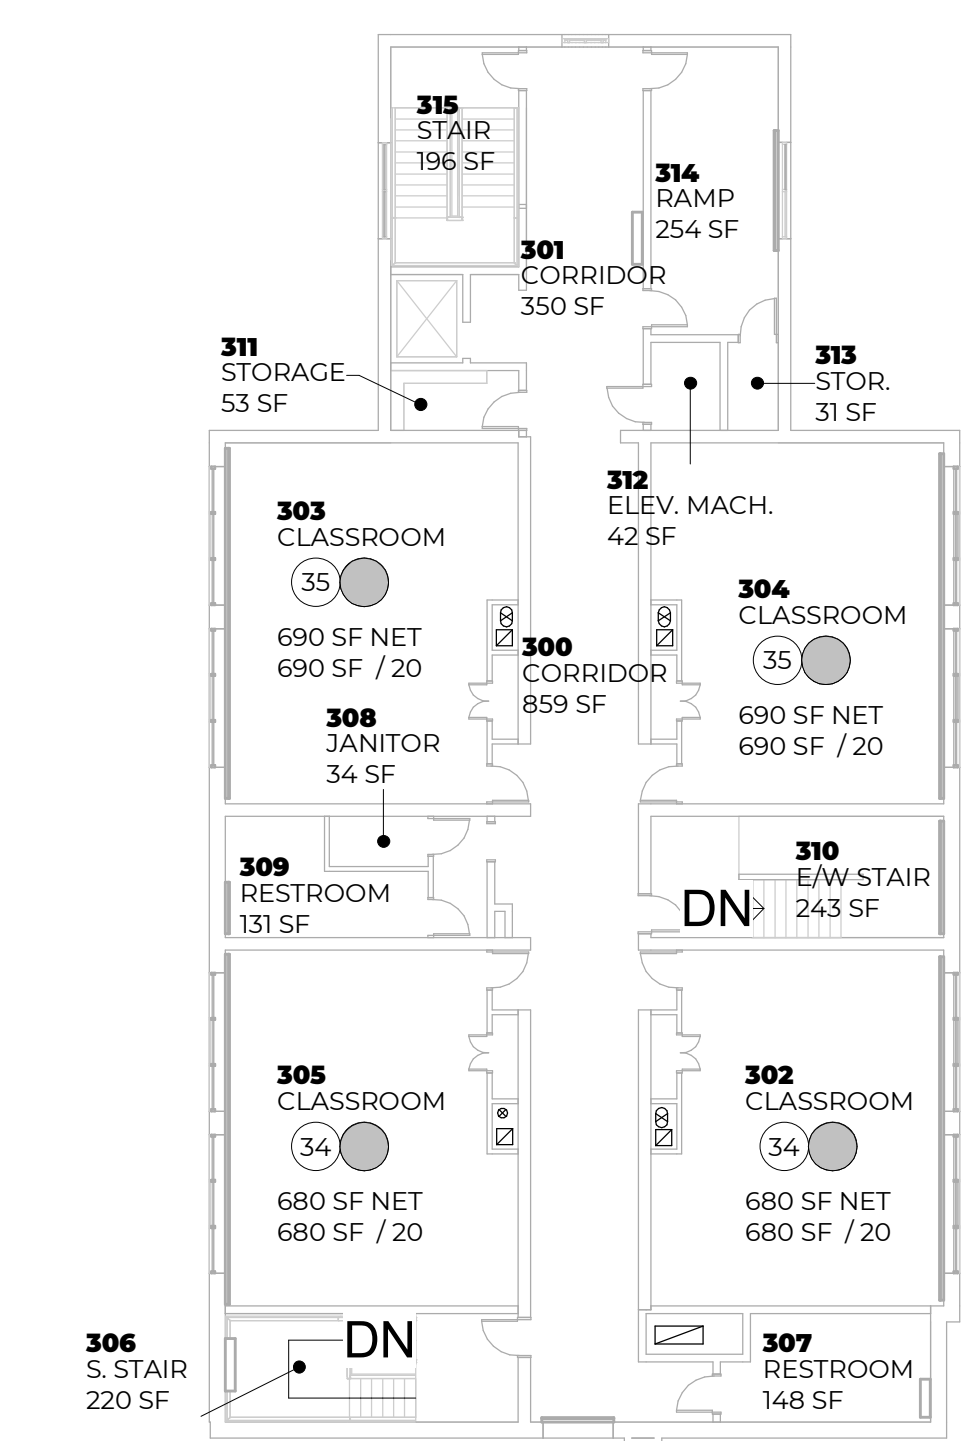

NR TH SECOND FLOOR CODE COMPLIANCE PLAN
1/16" = 1'-0"

REVISIONS

| SYM | DATE | ISSUED FOR |
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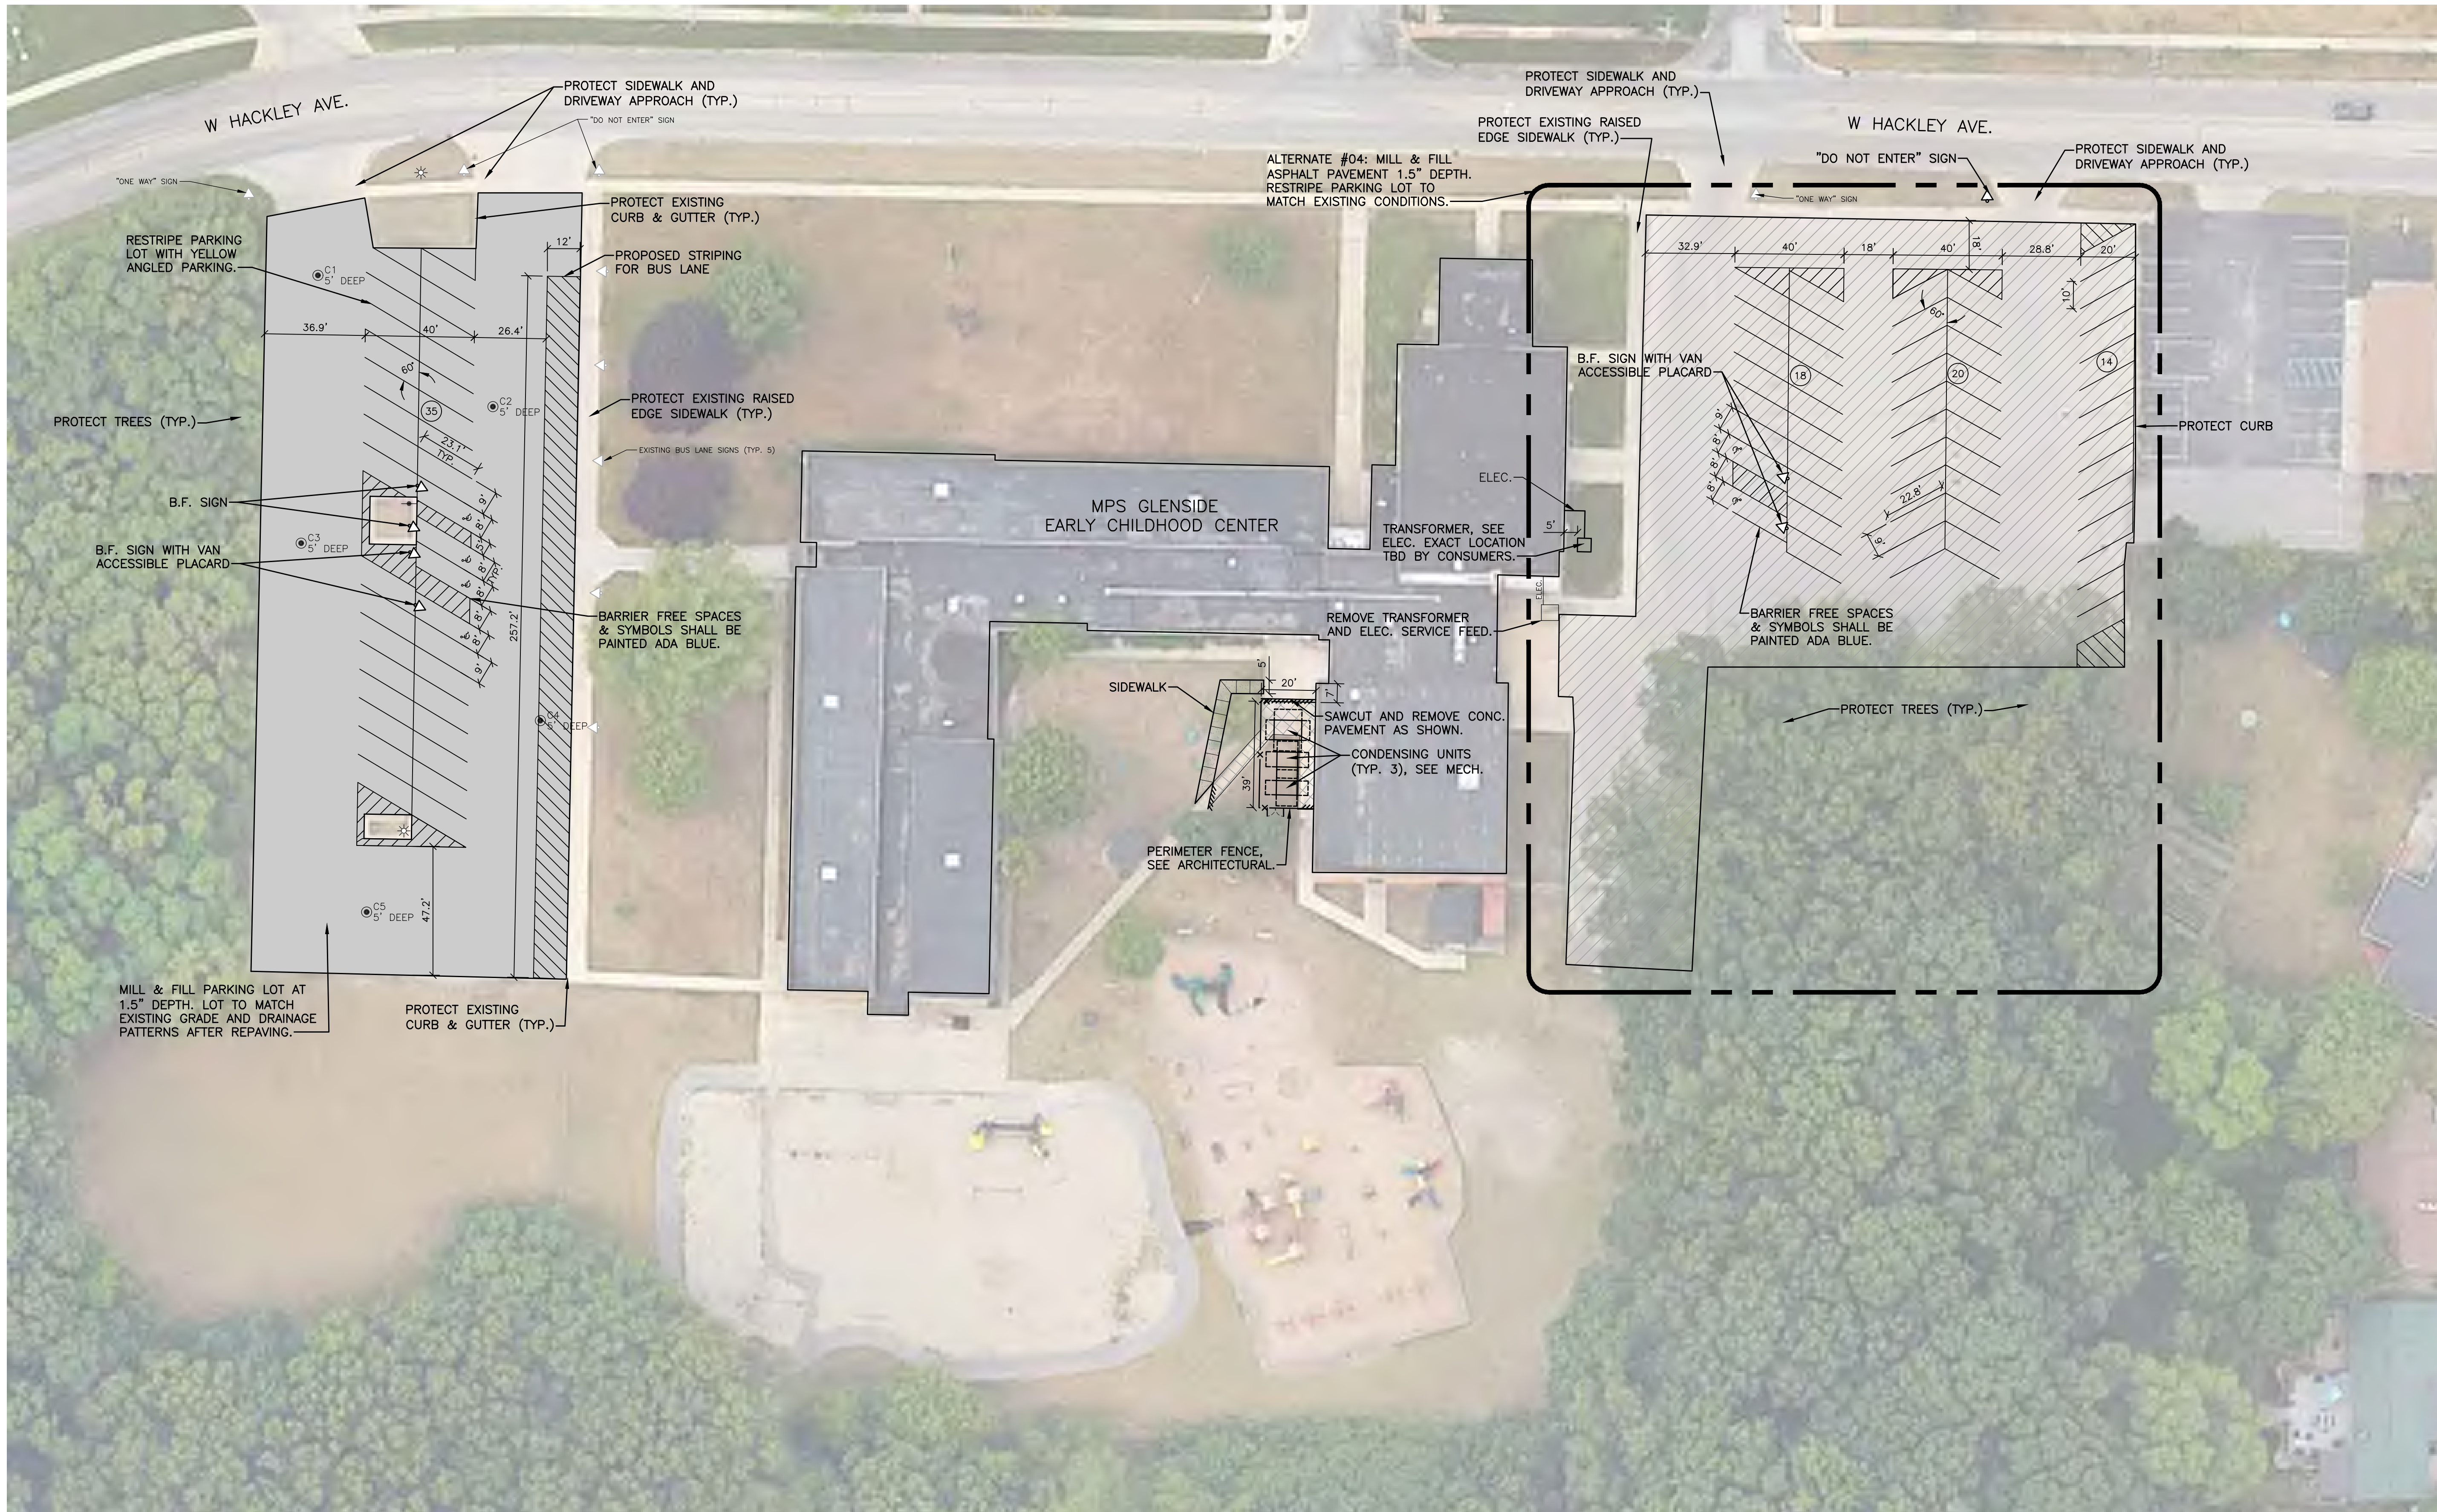
ISSUE DATE
03.08.2024

SHEET NAME
FIRST AND SECOND FLOOR CODE COMPLIANCE PLANS

SHEET NUMBER
G101

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MPS GLENSIDE
MUSKEGON PUBLIC SCHOOLS
1213 W Hackley Ave, Muskegon, MI 49441



SYMBOL LEGEND

- MILL & FILL ASPHALT PAVEMENT 1.5" DEPTH
- CRACK SEAL & FILL ASPHALT PAVEMENT
- 4" THICK CONCRETE SIDEWALK
- REMOVE CONCRETE PAVEMENT FULL DEPTH
- PARKING SPACE COUNT
- PAVEMENT CORES




NOTES

1. DRAWING INFORMATION IS COMPILED FROM GIS & AERIAL IMAGERY. FIELD VERIFY CRITICAL ELEVATIONS & TIE IN POINTS ON SITE.
2. DIMENSIONS ARE TO BACK OF CURB, OUTSIDE FACE OF BUILDING, AND EDGE OF PAVEMENT UNLESS NOTED OTHERWISE.
3. KEEP THE APPROVED AND/OR MOST CURRENT SET OF PROJECT DRAWINGS ON SITE AT ALL TIMES. CONTRACTOR TO CONFIRM THEY ARE IN POSSESSION OF THE MOST CURRENT DRAWING FILES.
4. PROTECT EXISTING VALVE BOXES, CASTINGS, AND EXISTING GROUND STRUCTURES.
5. RESTORE ALL DISTURBED SOIL TO MATCH EXISTING CONDITIONS.
6. RESULTS OF PAVEMENT CORES ARE TO BE DETERMINED AT TIME OF BIDS.
7. REFER TO ARCHITECTURAL FOR ENCLOSURE MATERIAL AND SPECIFICATIONS.

PARKING QUANTITIES

PROVIDED PARKING:

| | |
|----|-------------------------|
| 81 | ON-SITE STANDARD SPACES |
| 6 | BARRIER FREE SPACES |
| 87 | TOTAL SPACES |

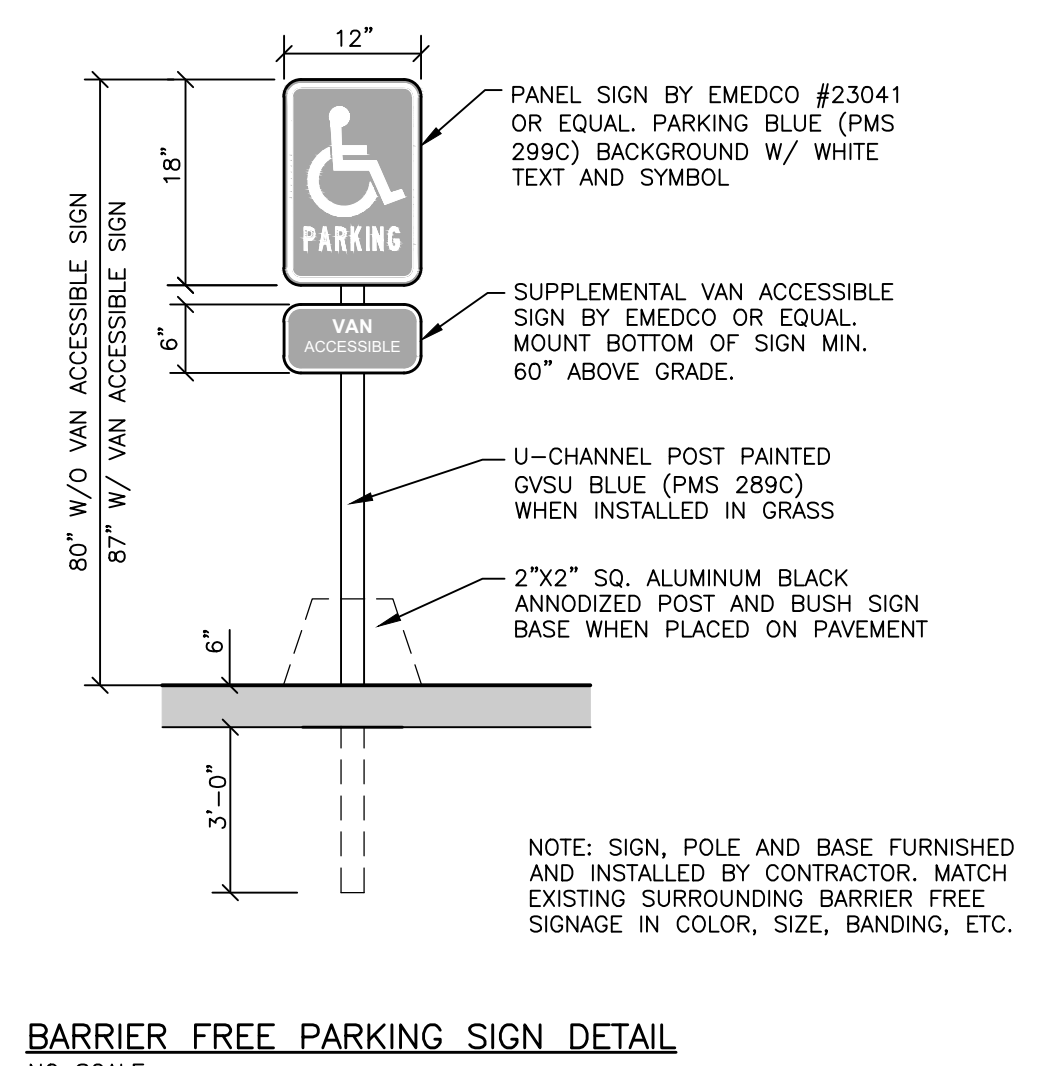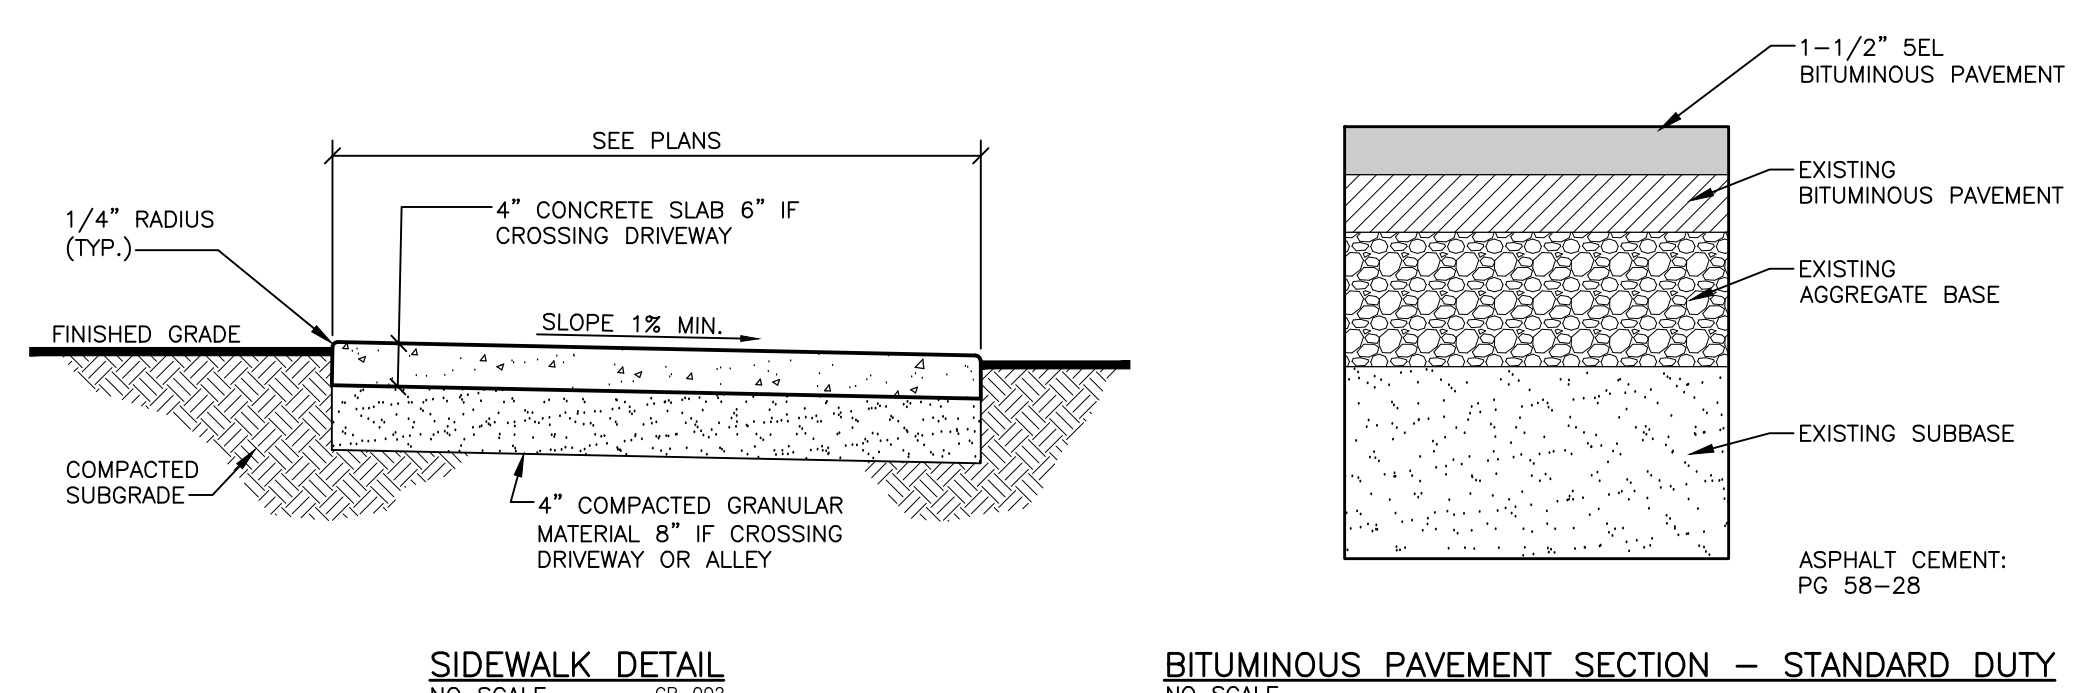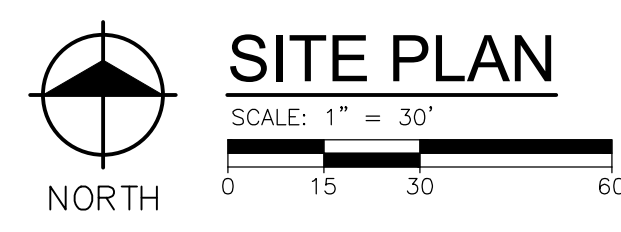

PLOT INFO: Z:\2022\221423\DWG_LAYOUT\SITE PLAN DATE: 3/8/2024 TIME: 4:55:55 PM USER: BVEINE

MPS GLENSIDE
MUSKEGON PUBLIC SCHOOLS
1213 W Hackley Ave, Muskegon, MI 49441

REVISIONS


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| | 3/7/2024 | |

ISSUE DATE
3/7/2024

SHEET NAME
SITE PLAN

SHEET NUMBER
C101

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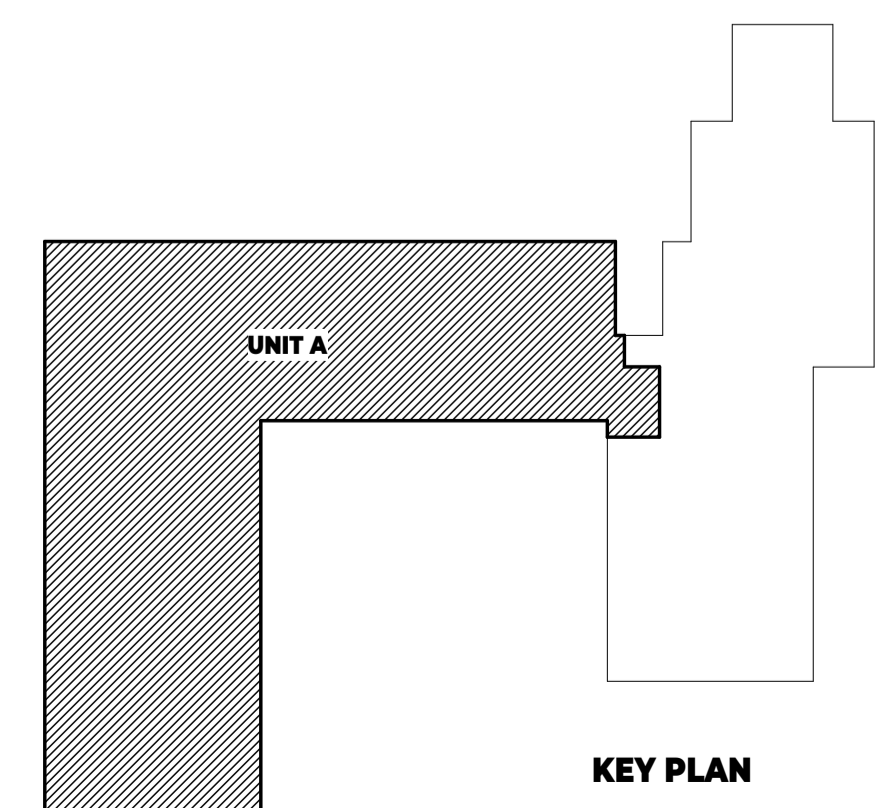
NOTE DEMOLITION GENERAL NOTES

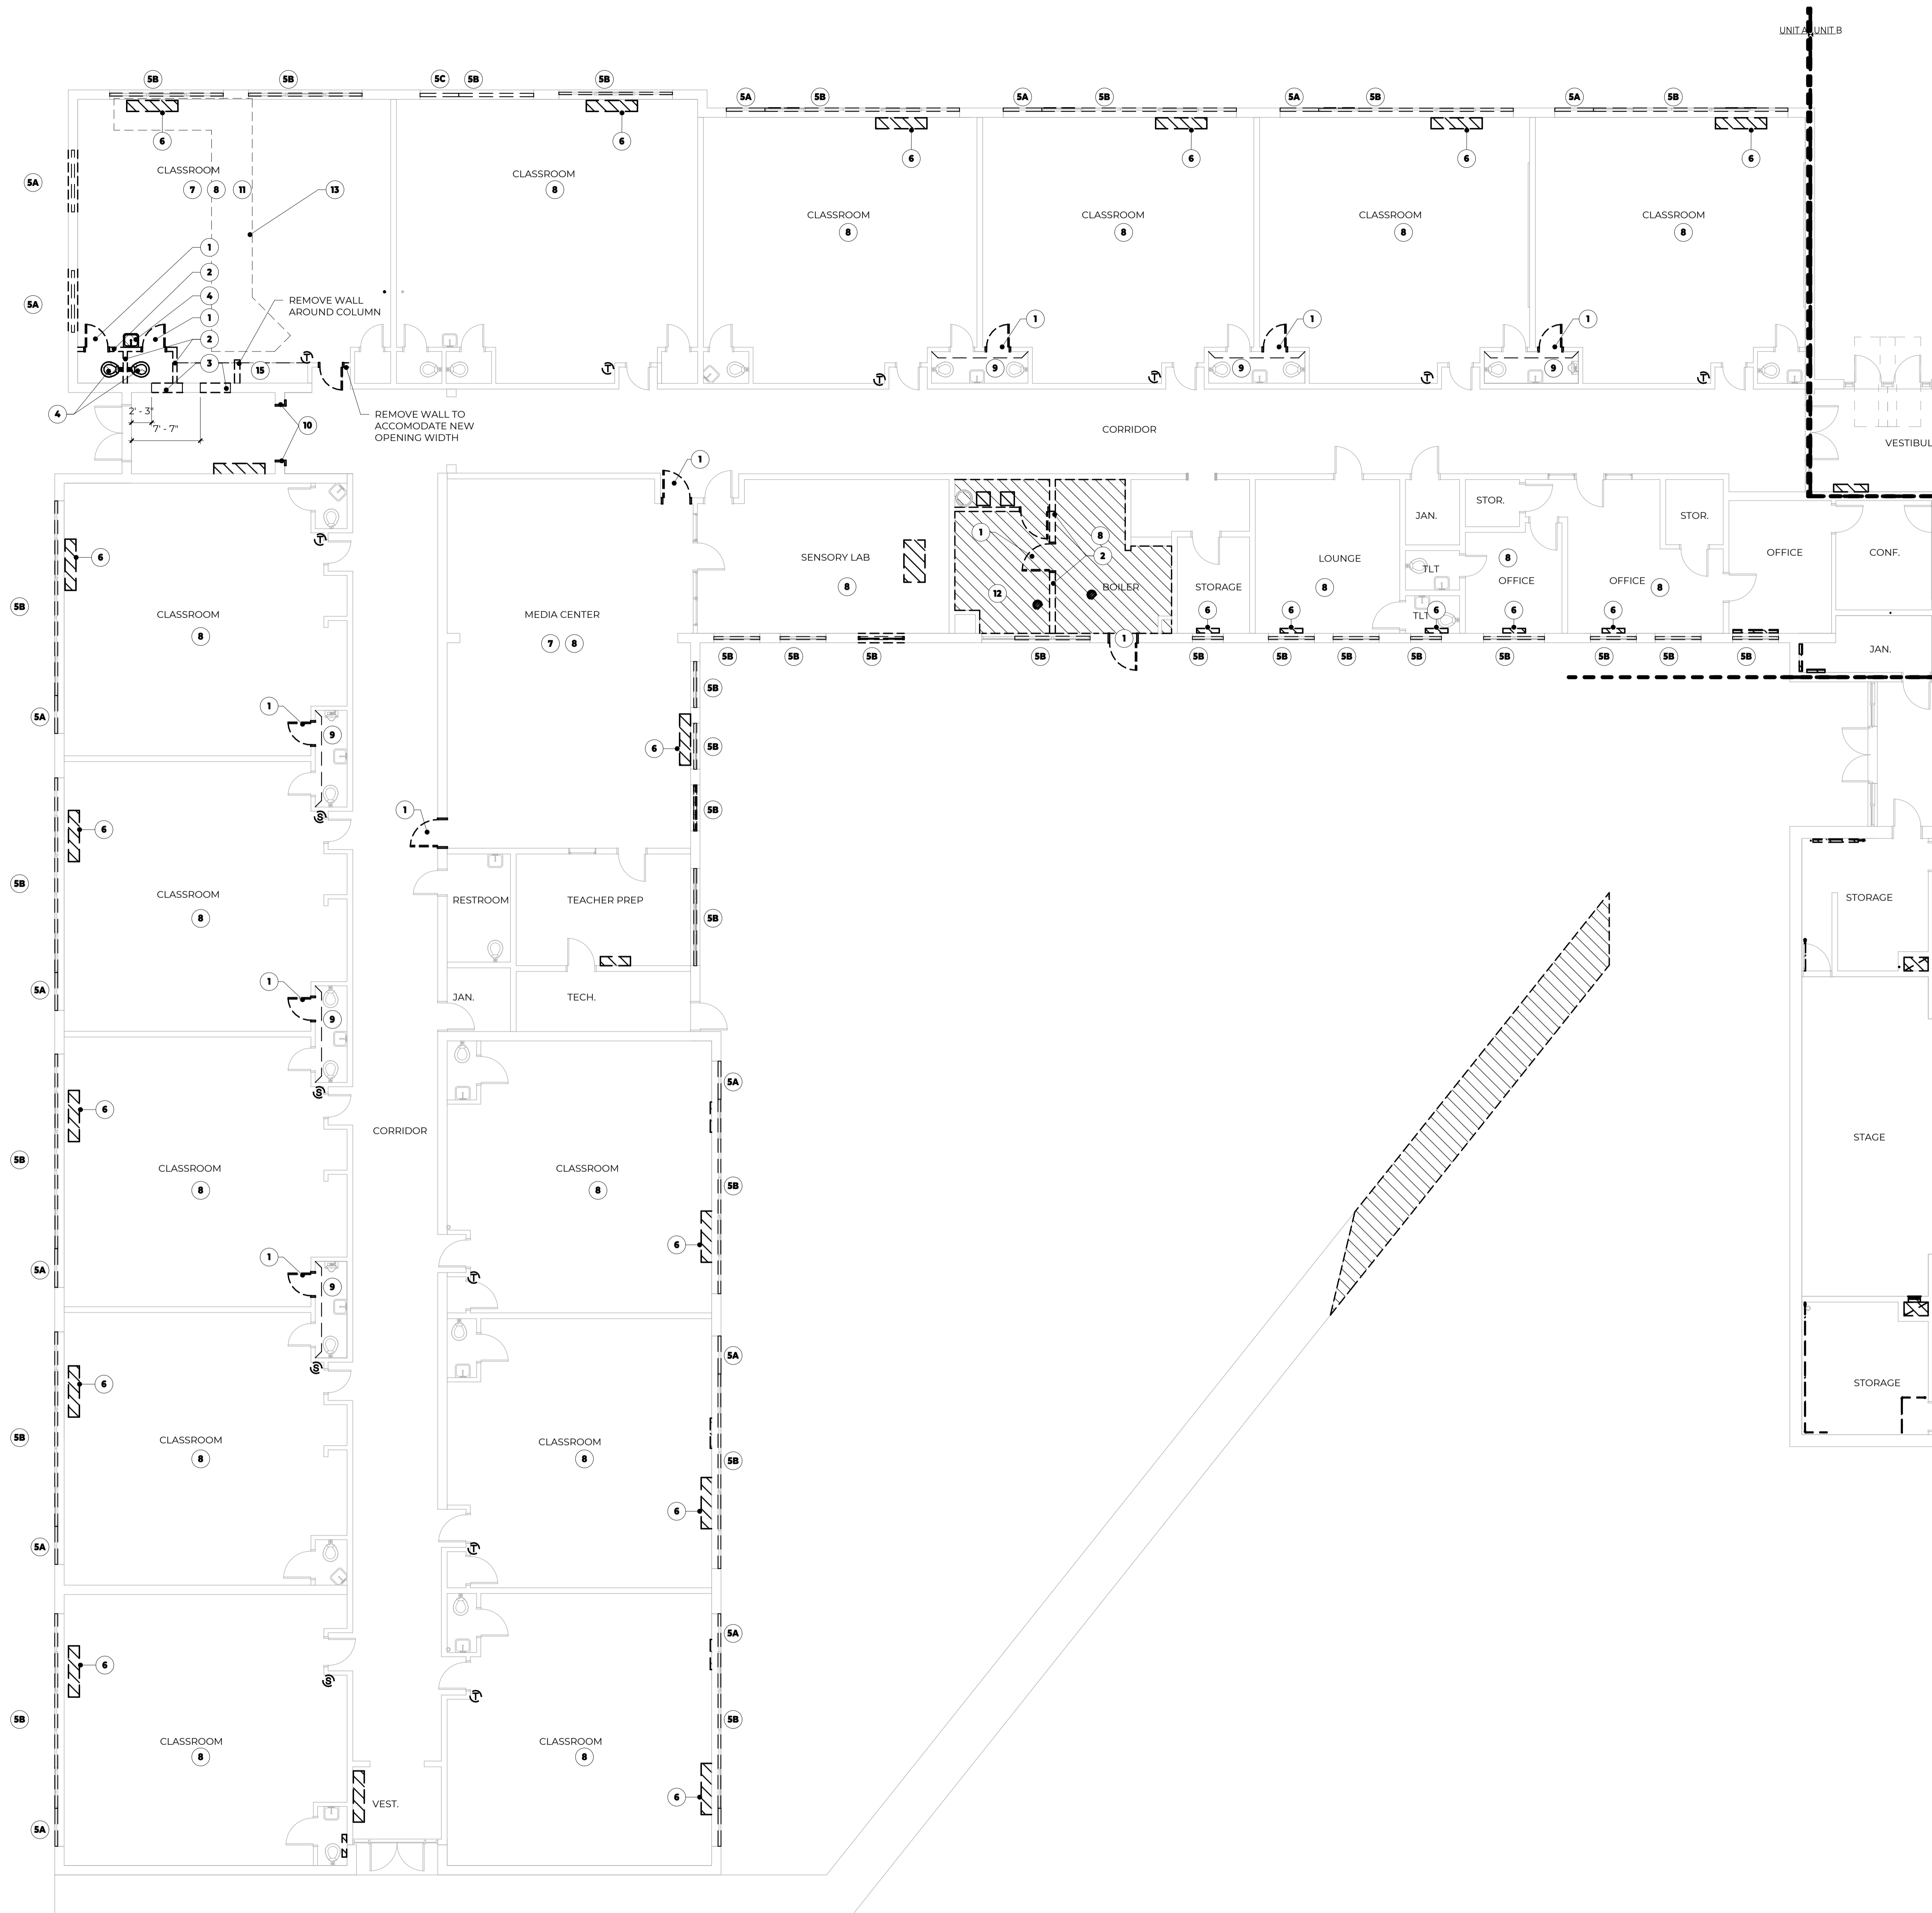1. CONTRACTORS ARE REQUIRED TO INSPECT/REVIEW THE EXISTING BUILDING PRIOR TO RELATED DEMOLITION WORK. UNLESS NOTED OTHERWISE, REMOVAL OF ANY WALL, FLOOR OR CEILING INCLUDES ALL GENERAL MECHANICAL AND ELECTRICAL ITEMS WHICH ARE A PART OF, OR ATTACHED TO IT.
2. CONTRACTOR SHALL VERIFY ALL EXISTING JOB SITE CONDITIONS AND DIMENSIONS AND BE RESPONSIBLE FOR THE SAME. ADVISE ARCHITECT OF ANY AND ALL DISCREPANCIES.
3. PATCH FLOORS, WALLS AND CEILINGS DAMAGED DURING CONSTRUCTION AND DEMOLITION AS REQUIRED. FINISH TO MATCH EXISTING.
4. ACCOMMODATE NEW CONSTRUCTION IF NOT INDICATED.
5. PROTECT ALL EXISTING FINISHES THROUGHOUT PROJECT.
6. REFER TO DEMOLITION ELEVATIONS, SECTIONS AND DETAILS FOR ADDITIONAL INFORMATION.
7. REFER TO STRUCTURAL, MECHANICAL, PLUMBING AND ELECTRICAL PLANS FOR ADDITIONAL DEMOLITION NOTES.
8. SALVAGE ALL UNISTRUIT AND PROTECT FOR RE-USE IN NEW CONSTRUCTION, IF REQUIRED.
9. AT LOCATIONS OF REMOVED WALLS, ALL ASSOCIATED ITEMS ATTACHED TO THE WALL ARE TO BE REMOVED. SUCH AS: DOORS, WINDOWS, FRAMES, MARKERBOARDS, TACKBOARDS, TACK STRIPS, ETC.

NOTE DEMOLITION KEYED NOTES

1. REMOVE EXISTING DOOR, FRAME, HARDWARE, AND ANY WOOD TRIM.
2. REMOVE EXISTING WALL AND ANY ITEMS ATTACHED.
3. REMOVE PORTION OF EXISTING WALL FOR NEW OPENING - COORDINATE WITH NEW WORK. CONSERVE BRICK FOR TOOTHING IN OF DOORS AROUND OPENINGS.
4. REMOVE EXISTING PLUMBING FIXTURES. CAP LINES AS REQUIRED. COORDINATE WITH NEW WORK.
- 5A. BASE BID - REMOVE PORTION OF EXISTING CLADDING INFILL EXISTING ROUGH OPENING TO REMAIN. COORDINATE WITH NEW WORK.
- 5B. ALTERNATE 01 - REMOVE EXISTING WINDOW, METAL STUD, AND CLADDING INFILL EXISTING ROUGH OPENING TO REMAIN. COORDINATE WITH NEW WORK OF ALTERNATE #01.
- 5C. ALTERNATE 02 - REMOVE EXISTING WINDOW, METAL STUD, AND CLADDING INFILL EXISTING ROUGH OPENING TO REMAIN. COORDINATE WITH NEW WORK OF ALTERNATE #02.
6. REMOVE EXISTING HORIZONTAL UNIT VENTILATOR. COORDINATE WITH MECHANICAL DRAWINGS AND PREP FOR NEW WORK.
7. SCRAPE PAINT AND PREP FOR NEW.
8. REMOVE CEILING AND GRID.
9. REFER TO INTERIOR DRAWINGS FOR SCOPE OF REMOVAL AND REPLACEMENT AT CLASSROOM RESTROOMS.
10. REMOVE WOOD PANELING - PATCH AND REPAIR WALL AS NEEDED.
11. REMOVE FLOORING. PREP FOR NEW.
12. REMOVE FLOORING AND BASE. PREP FOR NEW.
13. SAWCUT FLOOR FOR INSTALLATION OF BURRIED PLUMBING.
14. REMOVE RETURN LOUVER.
15. DEMO EXISTING CASEWORK. PATCH AND REPAIR FOR NEW WORK. BULKHEAD TO REMAIN.

NR TH FIRST FLOOR DEMOLITION PLAN - UNIT A
1/8" = 1'-0"



KEY PLAN

MPS GLENSIDE
MUSKEGON PUBLIC SCHOOLS
1213 W Hackley Ave, Muskegon, MI 49441


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SYM DATE ISSUED FOR


ISSUE DATE
03.08.2024

SHEET NAME
FIRST FLOOR DEMOLITION PLAN - UNIT A


SHEET NUMBER
D101A

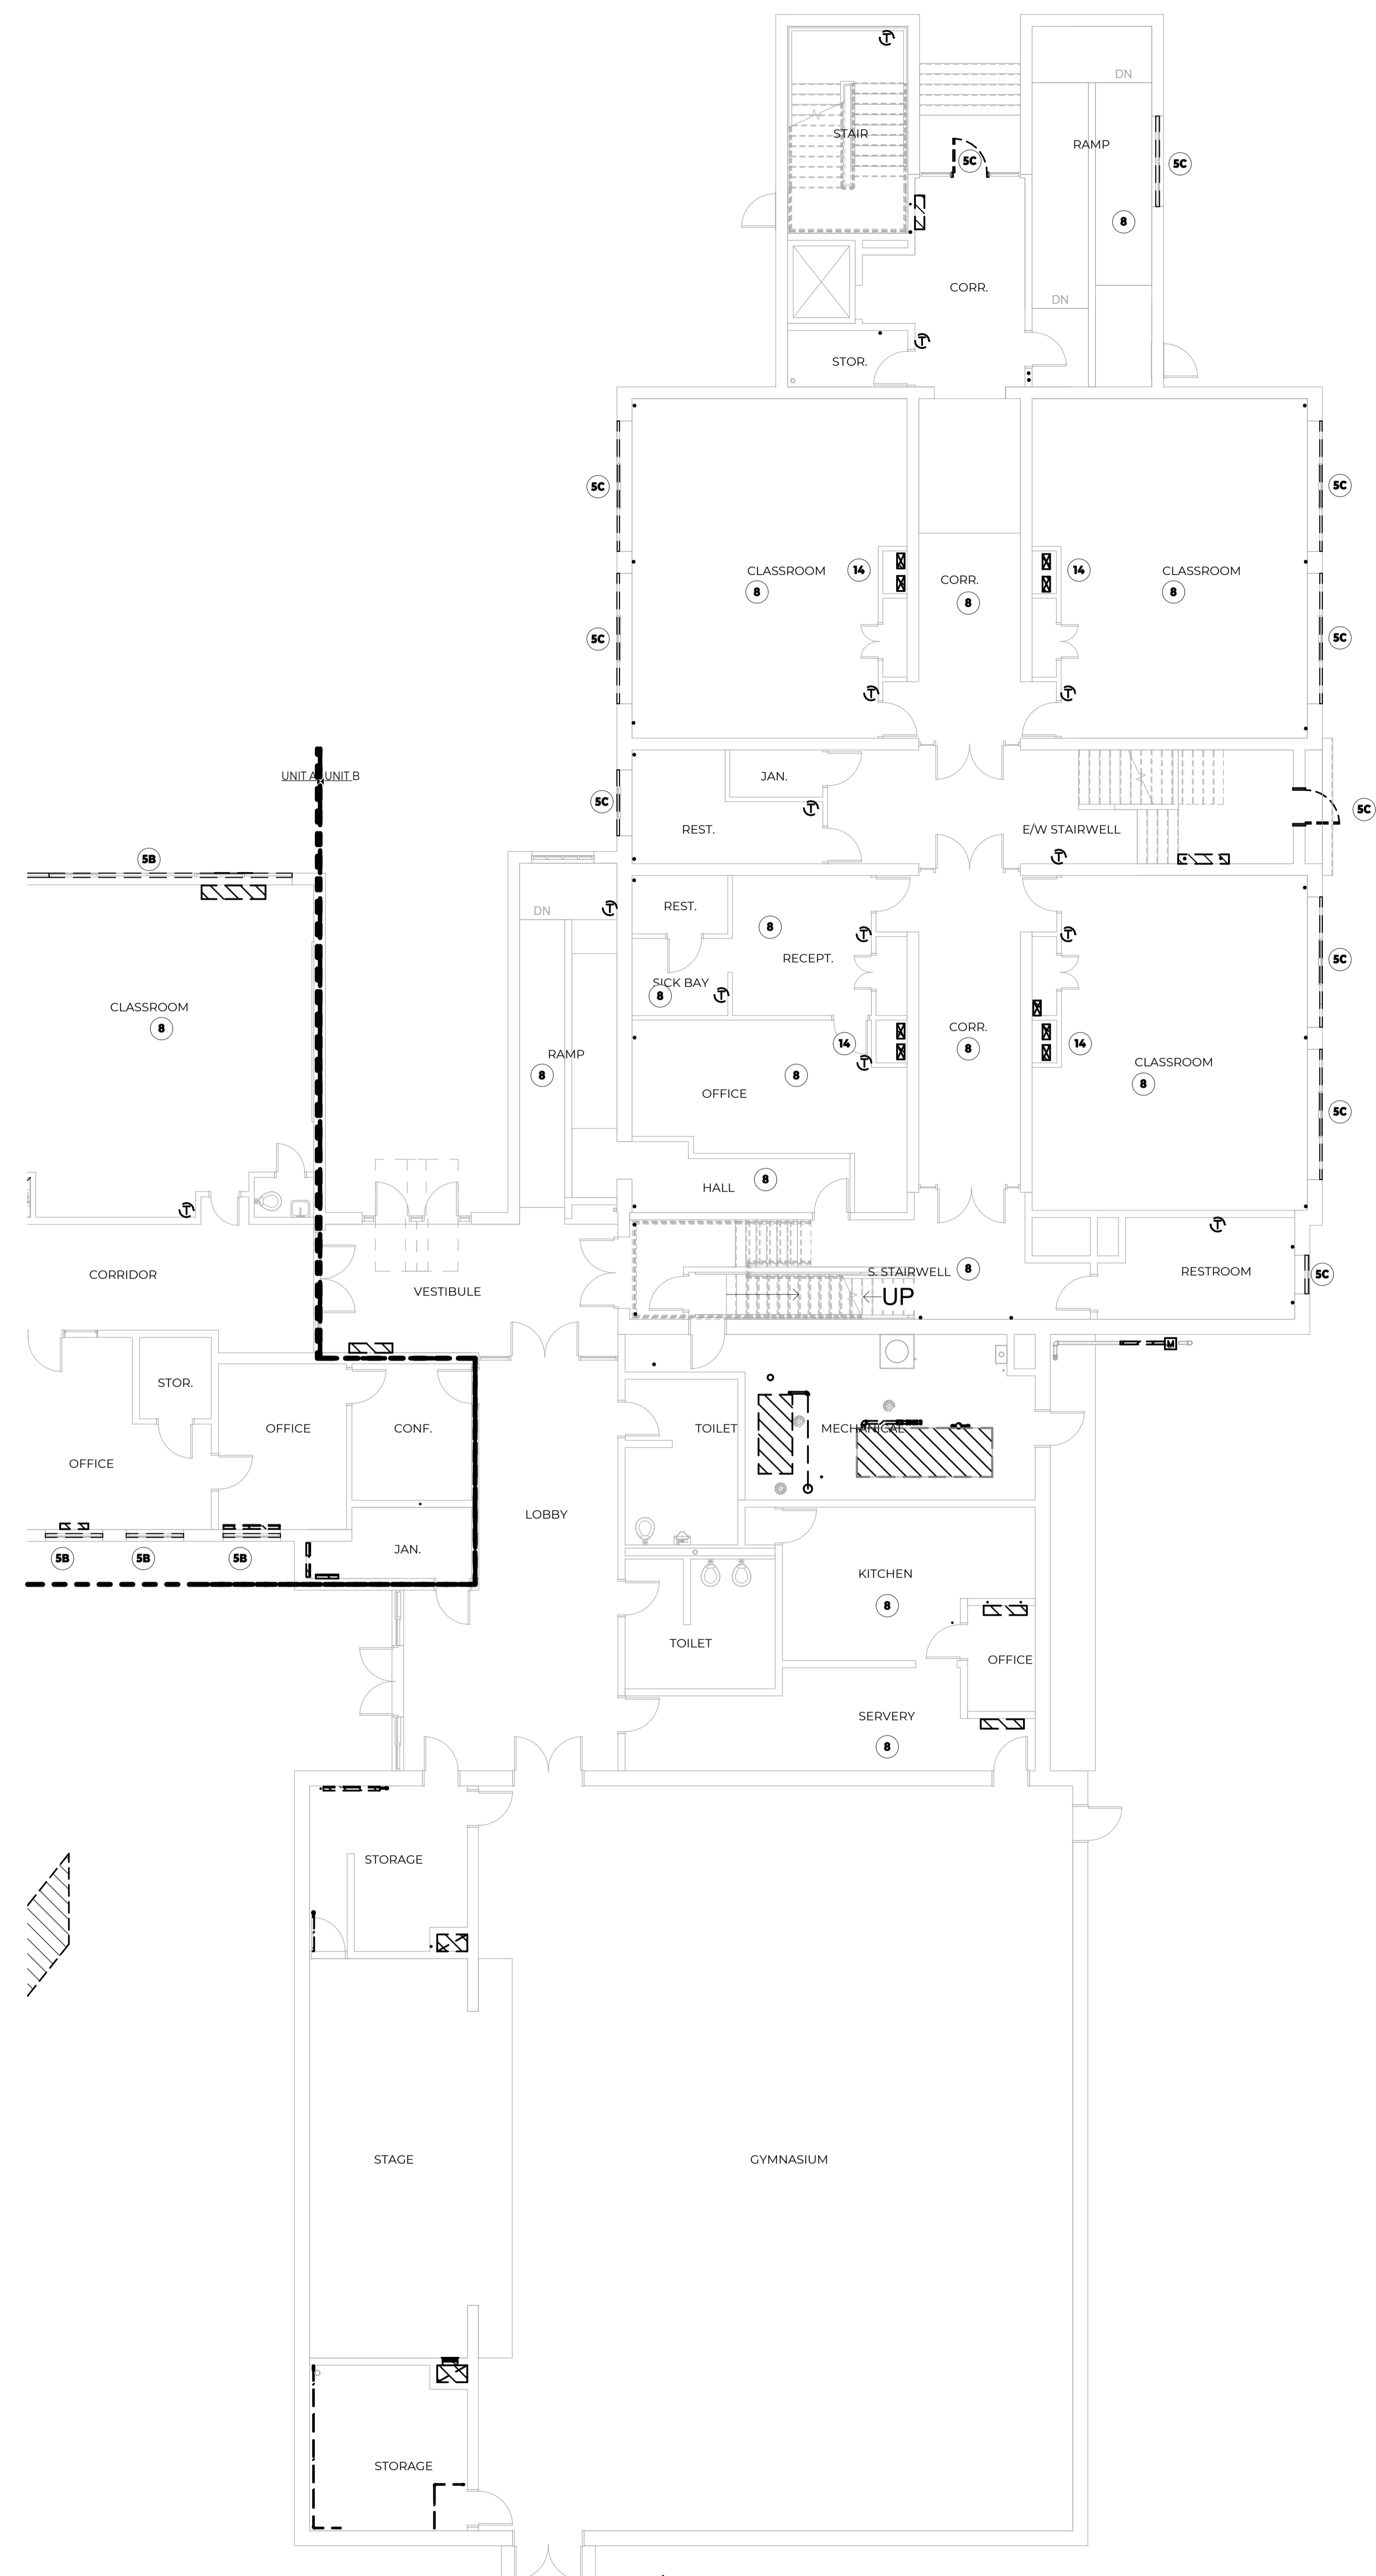

NR TH FIRST FLOOR DEMOLITION PLAN - UNIT B
1/8" = 1'-0"

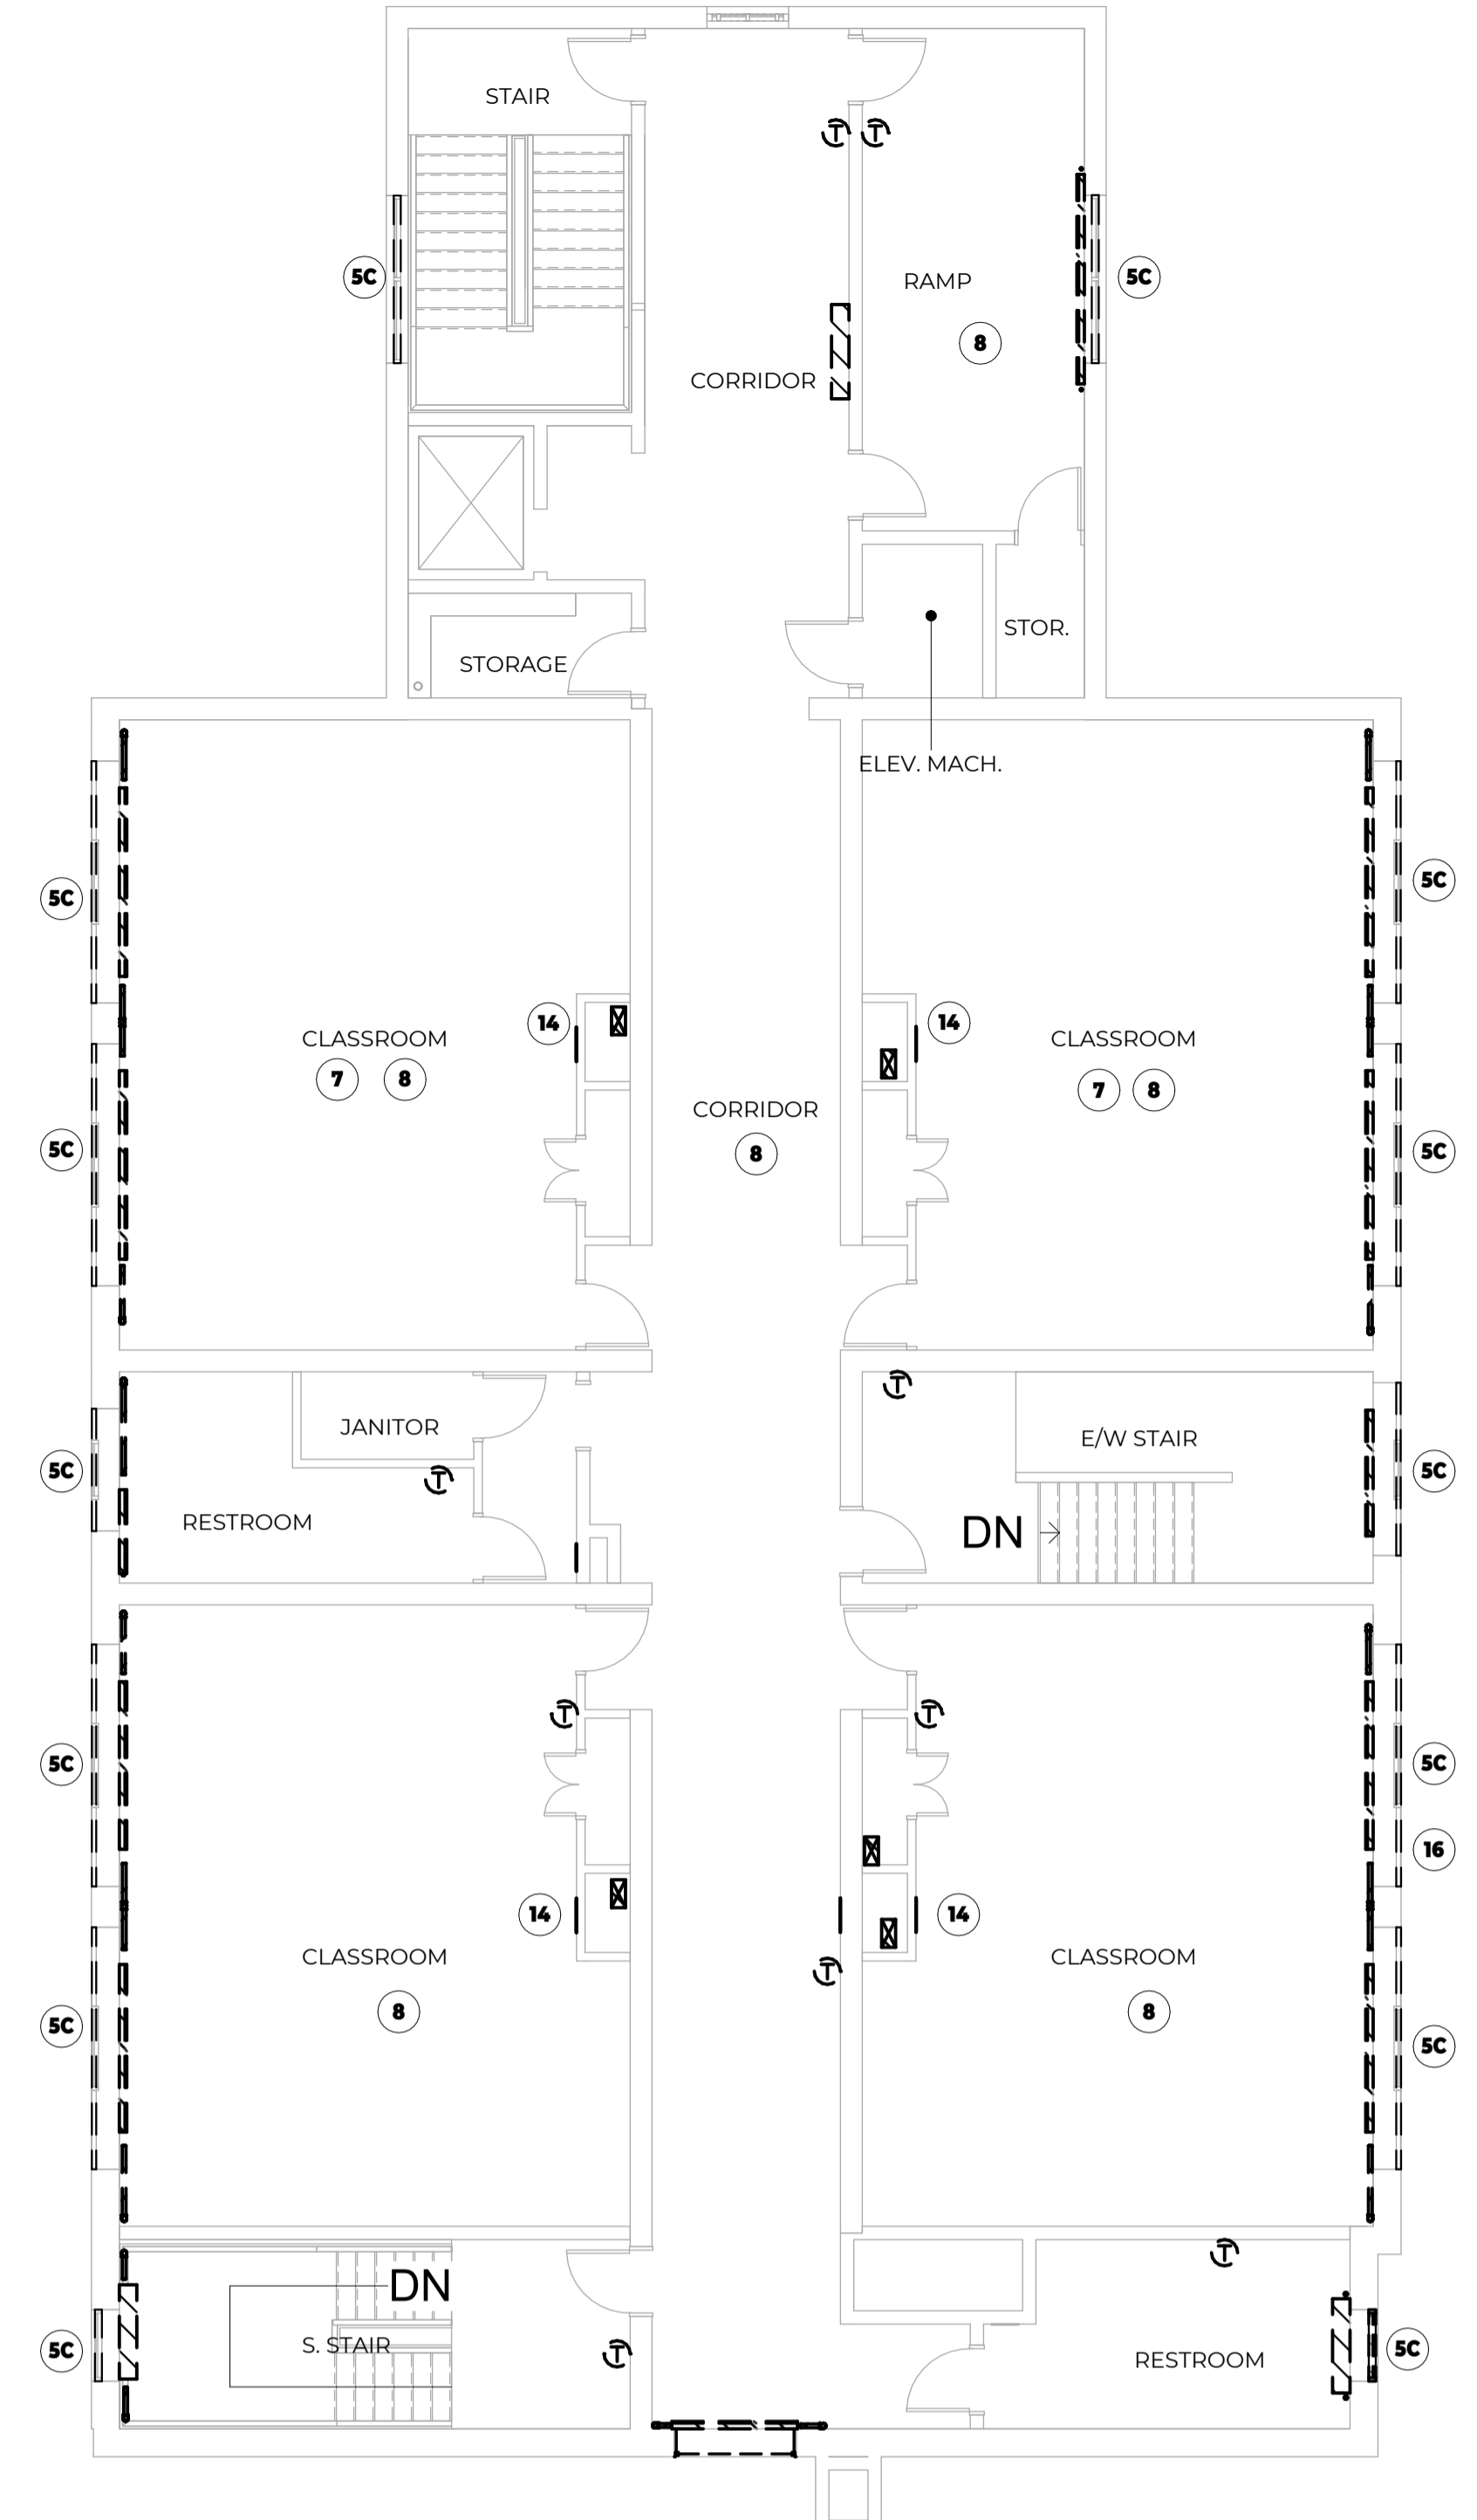

NR TH SECOND FLOOR DEMOLITION PLAN
1/8" = 1'-0"

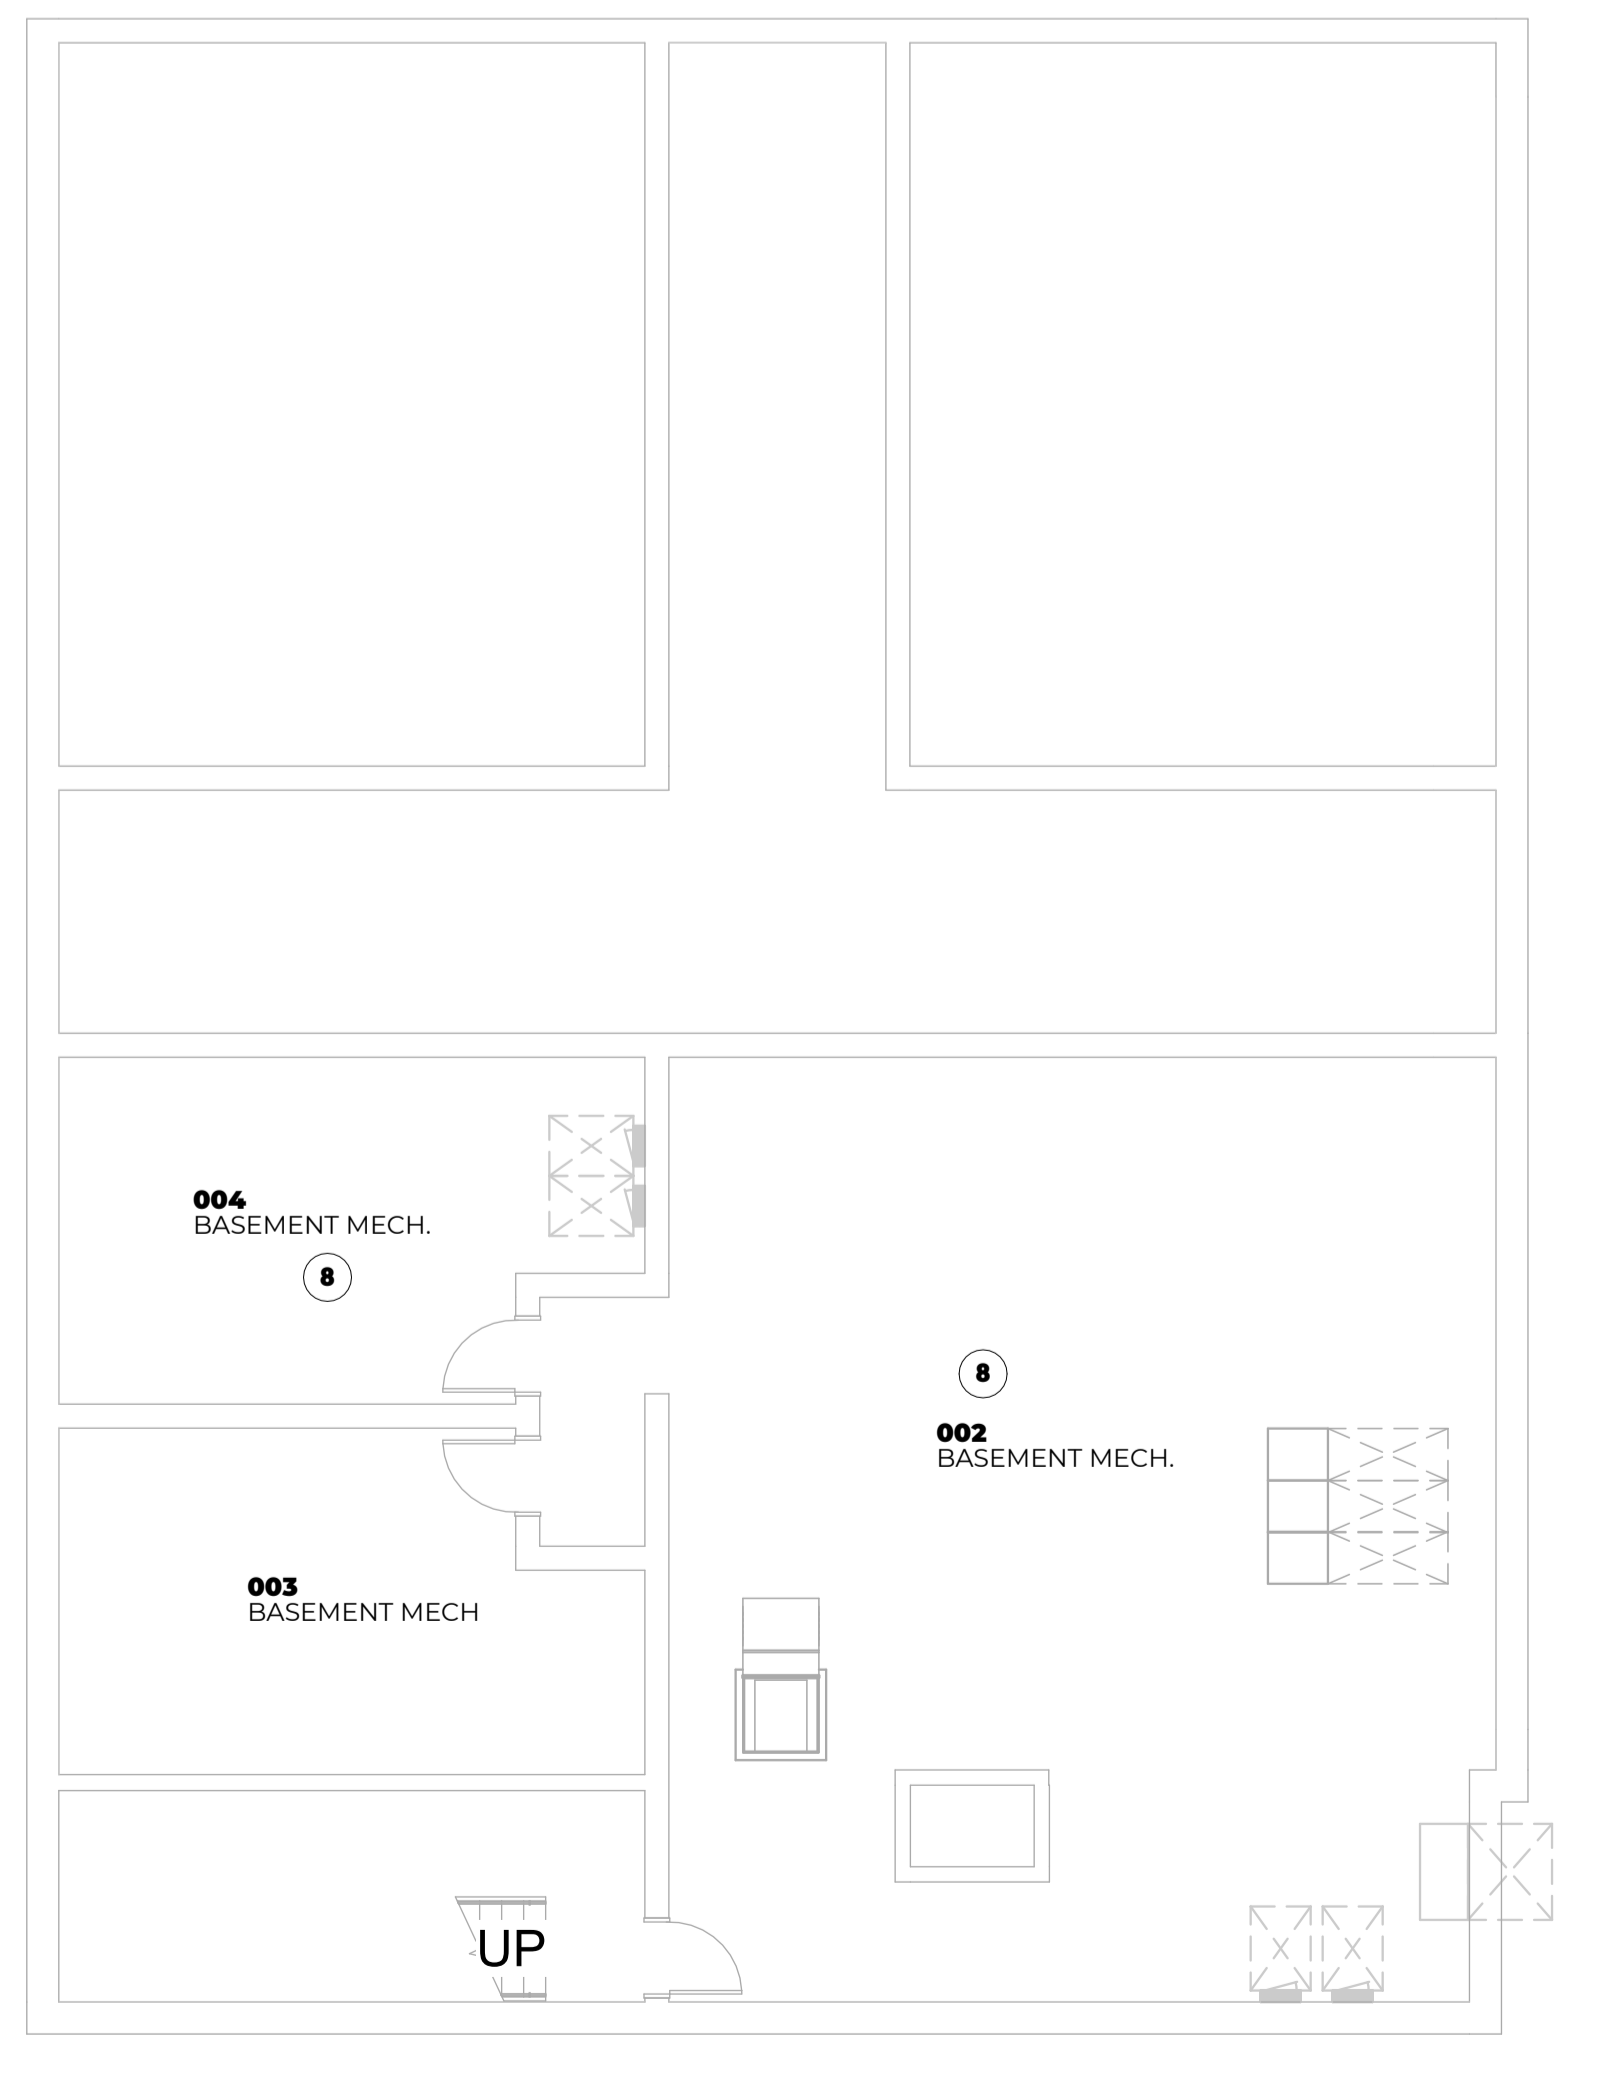

NR TH BASEMENT DEMOLITION PLAN
1/8" = 1'-0"

NOTE DEMOLITION GENERAL NOTES

1. CONTRACTORS ARE REQUIRED TO INSPECT/REVIEW THE EXISTING BUILDING PRIOR TO RELATED DEMOLITION WORK. UNLESS NOTED OTHERWISE, REMOVAL OF ANY WALL, FLOOR OR CEILING INCLUDES ALL GENERAL MECHANICAL AND ELECTRICAL ITEMS WHICH ARE A PART OF, OR ATTACHED TO IT.
2. CONTRACTOR SHALL VERIFY ALL EXISTING JOB SITE CONDITIONS AND DIMENSIONS AND BE RESPONSIBLE FOR THE SAME. ADVISE ARCHITECT OF ANY AND ALL DISCREPANCIES.
3. PATCH FLOORS, WALLS AND CEILINGS DAMAGED DURING CONSTRUCTION AND DEMOLITION AS REQUIRED. FINISH TO MATCH EXISTING.
4. ACCOMMODATE NEW CONSTRUCTION IF NOT INDICATED.
5. PROTECT ALL EXISTING FINISHES THROUGHOUT PROJECT.
6. REFER TO DEMOLITION ELEVATIONS, SECTIONS AND DETAILS FOR ADDITIONAL INFORMATION.
7. REFER TO STRUCTURAL, MECHANICAL, PLUMBING AND ELECTRICAL PLANS FOR ADDITIONAL DEMOLITION NOTES.
8. SALVAGE ALL UNISTRUIT AND PROTECT FOR RE-USE IN NEW CONSTRUCTION, IF REQUIRED.
9. AT LOCATIONS OF REMOVED WALLS, ALL ASSOCIATED ITEMS ATTACHED TO THE WALL ARE TO BE REMOVED. SUCH AS: DOORS, WINDOWS, FRAMES, MARKERBOARDS, TACKBOARDS, TACK STRIPS, ETC.

NOTE DEMOLITION KEYED NOTES

1. REMOVE EXISTING DOOR, FRAME, HARDWARE, AND ANY WOOD TRIM.
2. REMOVE EXISTING WALL AND ANY ITEMS ATTACHED.
3. REMOVE PORTION OF EXISTING WALL FOR NEW OPENING - COORDINATE WITH NEW WORK. CONSERVE BRICK FOR TOOTHING IN OF DOORS AROUND OPENINGS.
4. REMOVE EXISTING PLUMBING FIXTURES, CAP LINES AS REQUIRED. COORDINATE WITH NEW WORK.
- 5A. BASE BID - REMOVE PORTION OF EXISTING CLADDING INFILL EXISTING ROUGH OPENING TO REMAIN. COORDINATE WITH NEW WORK.
- 5B. ALTERNATE 01 - REMOVE EXISTING WINDOW, METAL STUD, AND CLADDING INFILL EXISTING ROUGH OPENING TO REMAIN. COORDINATE WITH NEW WORK OF ALTERNATE #01.
- 5C. ALTERNATE 02 - REMOVE EXISTING WINDOW, METAL STUD, AND CLADDING INFILL EXISTING ROUGH OPENING TO REMAIN. COORDINATE WITH NEW WORK OF ALTERNATE #02.
6. REMOVE EXISTING HORIZONTAL UNIT VENTILATOR. COORDINATE WITH MECHANICAL DRAWINGS AND PREP FOR NEW WORK.
7. SCRAPE PAINT AND PREP FOR NEW.
8. REMOVE CEILING AND GRID.
9. REFER TO INTERIOR DRAWINGS FOR SCOPE OF REMOVAL AND REPLACEMENT AT CLASSROOM RESTROOMS.
10. REMOVE WOOD PANELING - PATCH AND REPAIR WALL AS NEEDED.
11. REMOVE FLOORING. PREP FOR NEW.
12. REMOVE FLOORING AND BASE. PREP FOR NEW.
13. SAWCUT FLOOR FOR INSTALLATION OF BURRIED PLUMBING.
14. REMOVE RETURN LOUVER.
15. DEMO EXISTING CASEWORK. PATCH AND REPAIR FOR NEW WORK. BULKHEAD TO REMAIN.

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REVISIONS

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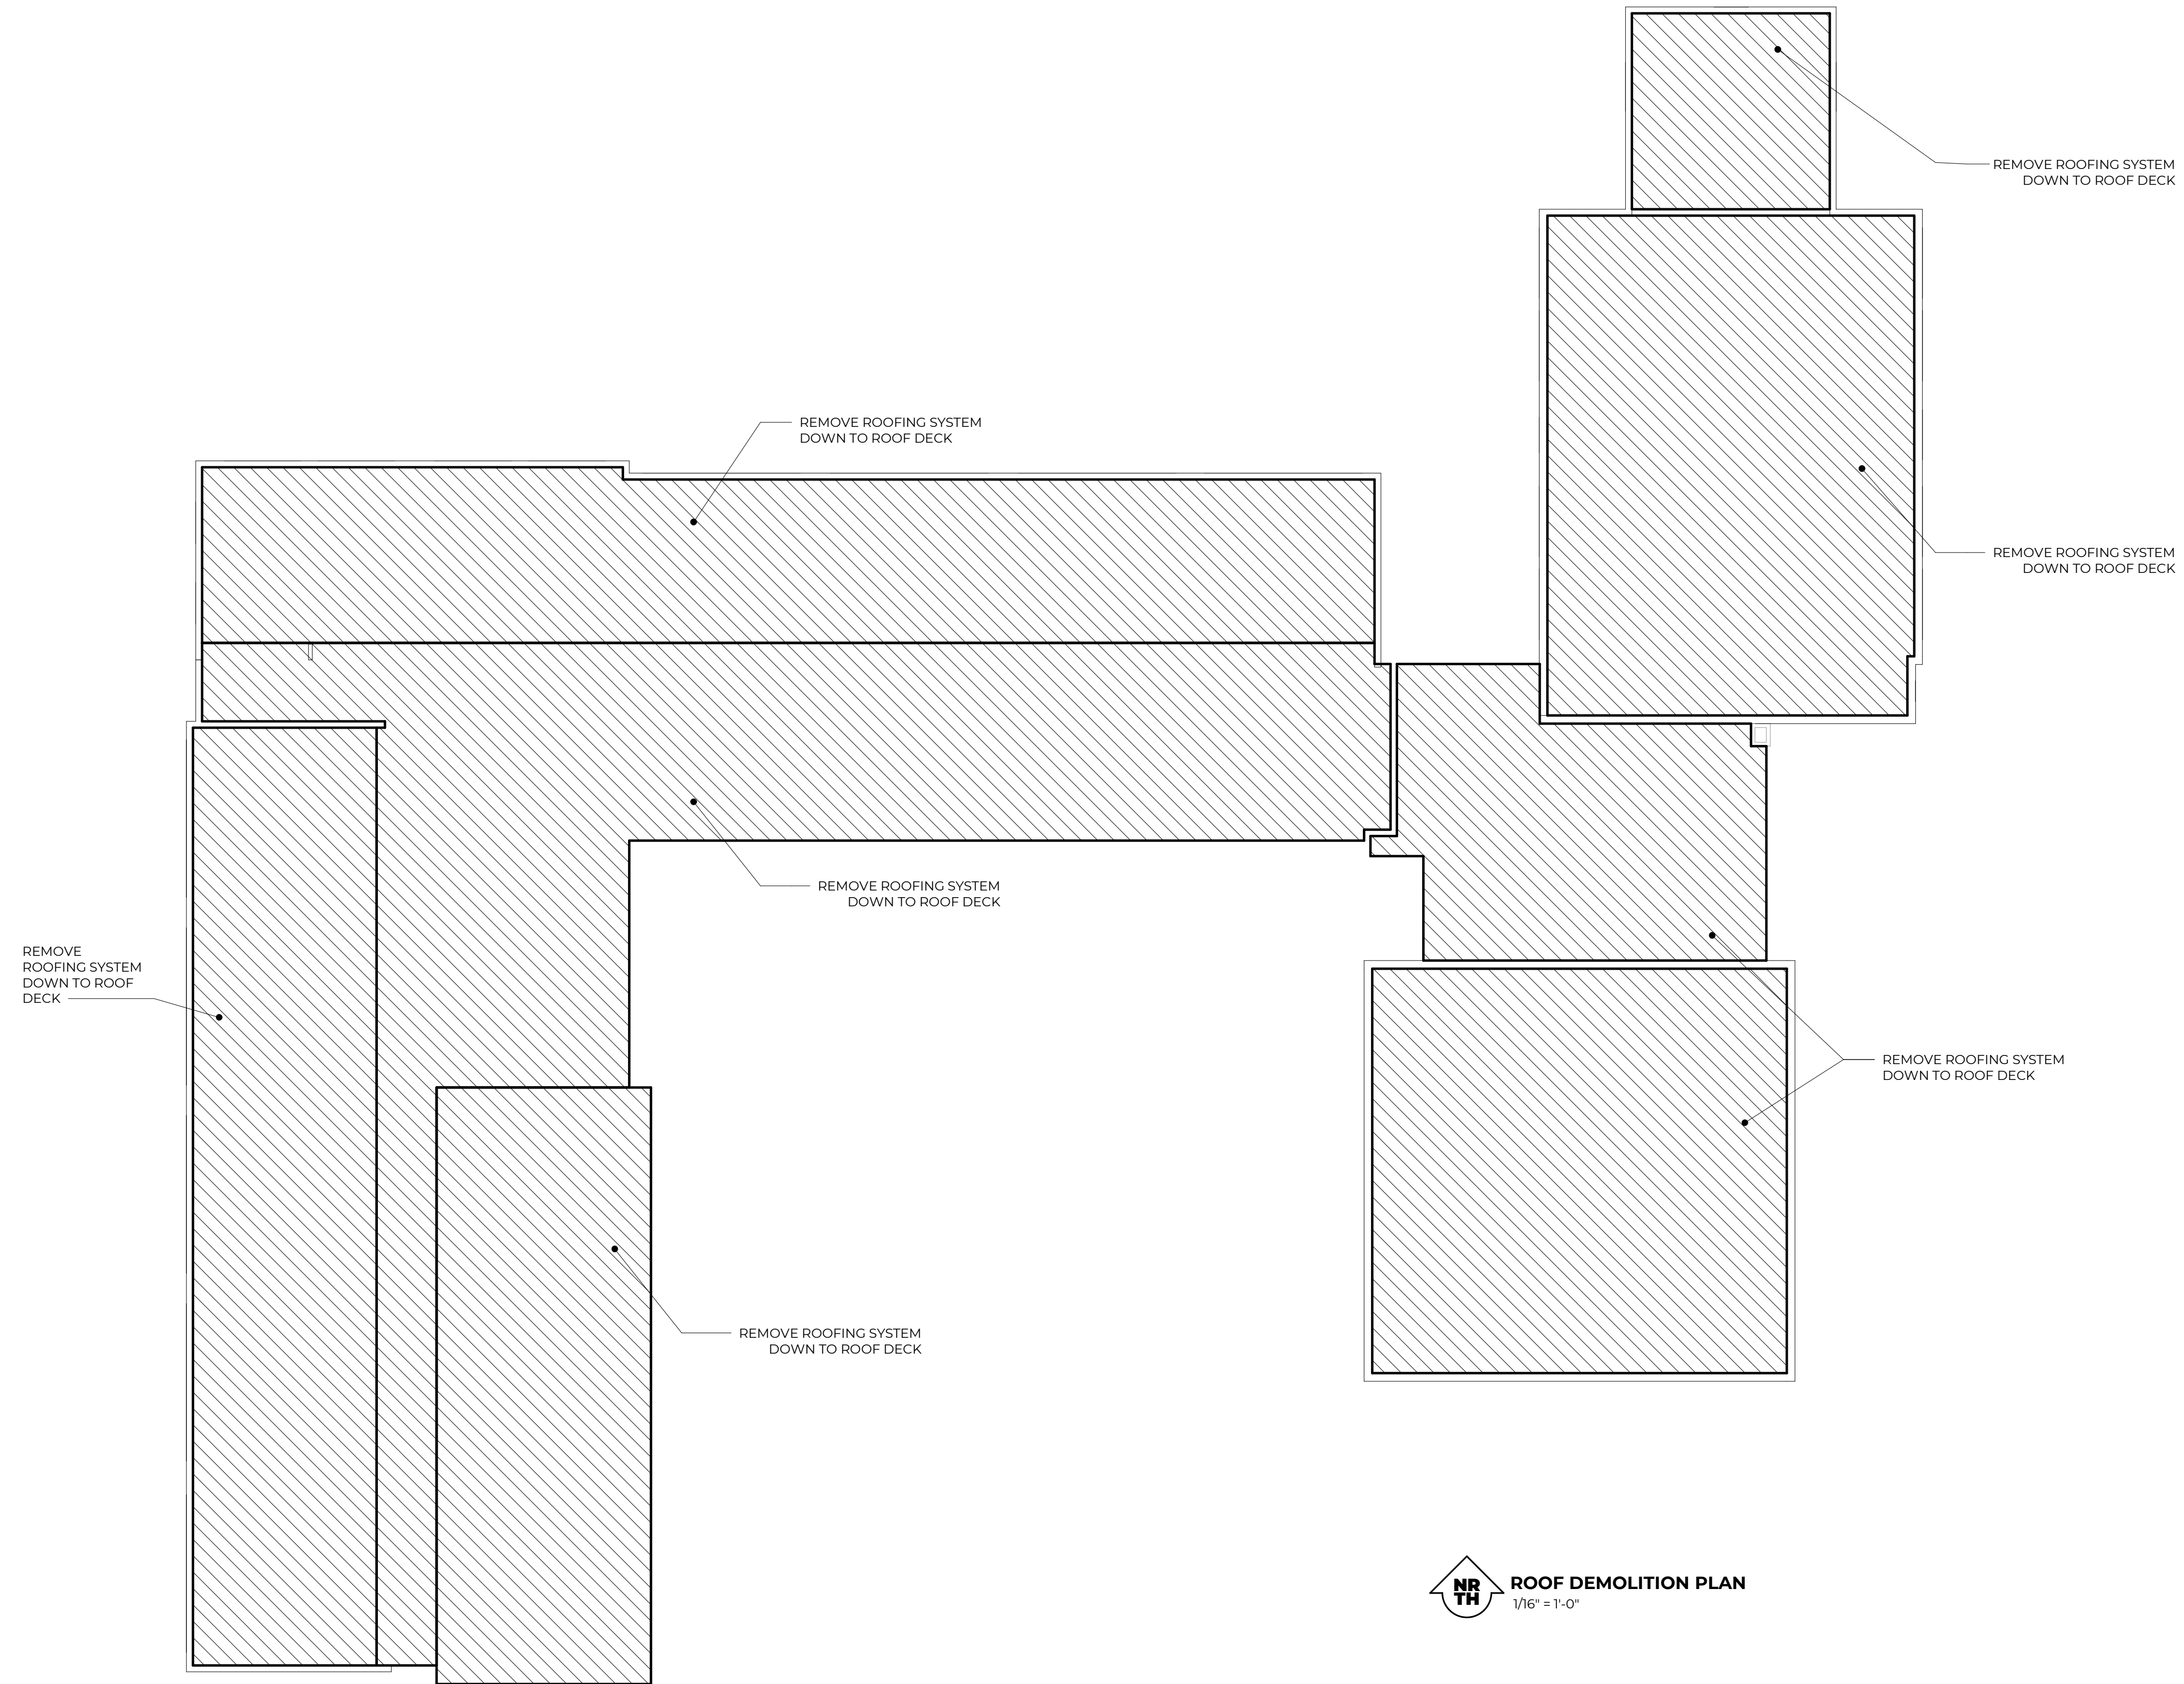
ISSUE DATE
03.08.2024

SHEET NAME
DEMOLITION PLANS - UNIT B


SHEET NUMBER
D101B

NOTE DEMOLITION GENERAL NOTES

1. CONTRACTORS ARE REQUIRED TO INSPECT/REVIEW THE EXISTING BUILDING PRIOR TO RELATED DEMOLITION WORK. UNLESS NOTED OTHERWISE, REMOVAL OF ANY WALL, FLOOR OR CEILING INCLUDES ALL GENERAL MECHANICAL AND ELECTRICAL ITEMS WHICH ARE A PART OF, OR ATTACHED TO IT.
2. CONTRACTOR SHALL VERIFY ALL EXISTING JOB SITE CONDITIONS AND DIMENSIONS AND BE RESPONSIBLE FOR THE SAME. ADVISE ARCHITECT OF ANY AND ALL DISCREPANCIES.
3. PATCH FLOORS, WALLS AND CEILINGS DAMAGED DURING CONSTRUCTION AND DEMOLITION AS REQUIRED. FINISH TO MATCH EXISTING.
4. ACCOMMODATE NEW CONSTRUCTION IF NOT INDICATED.
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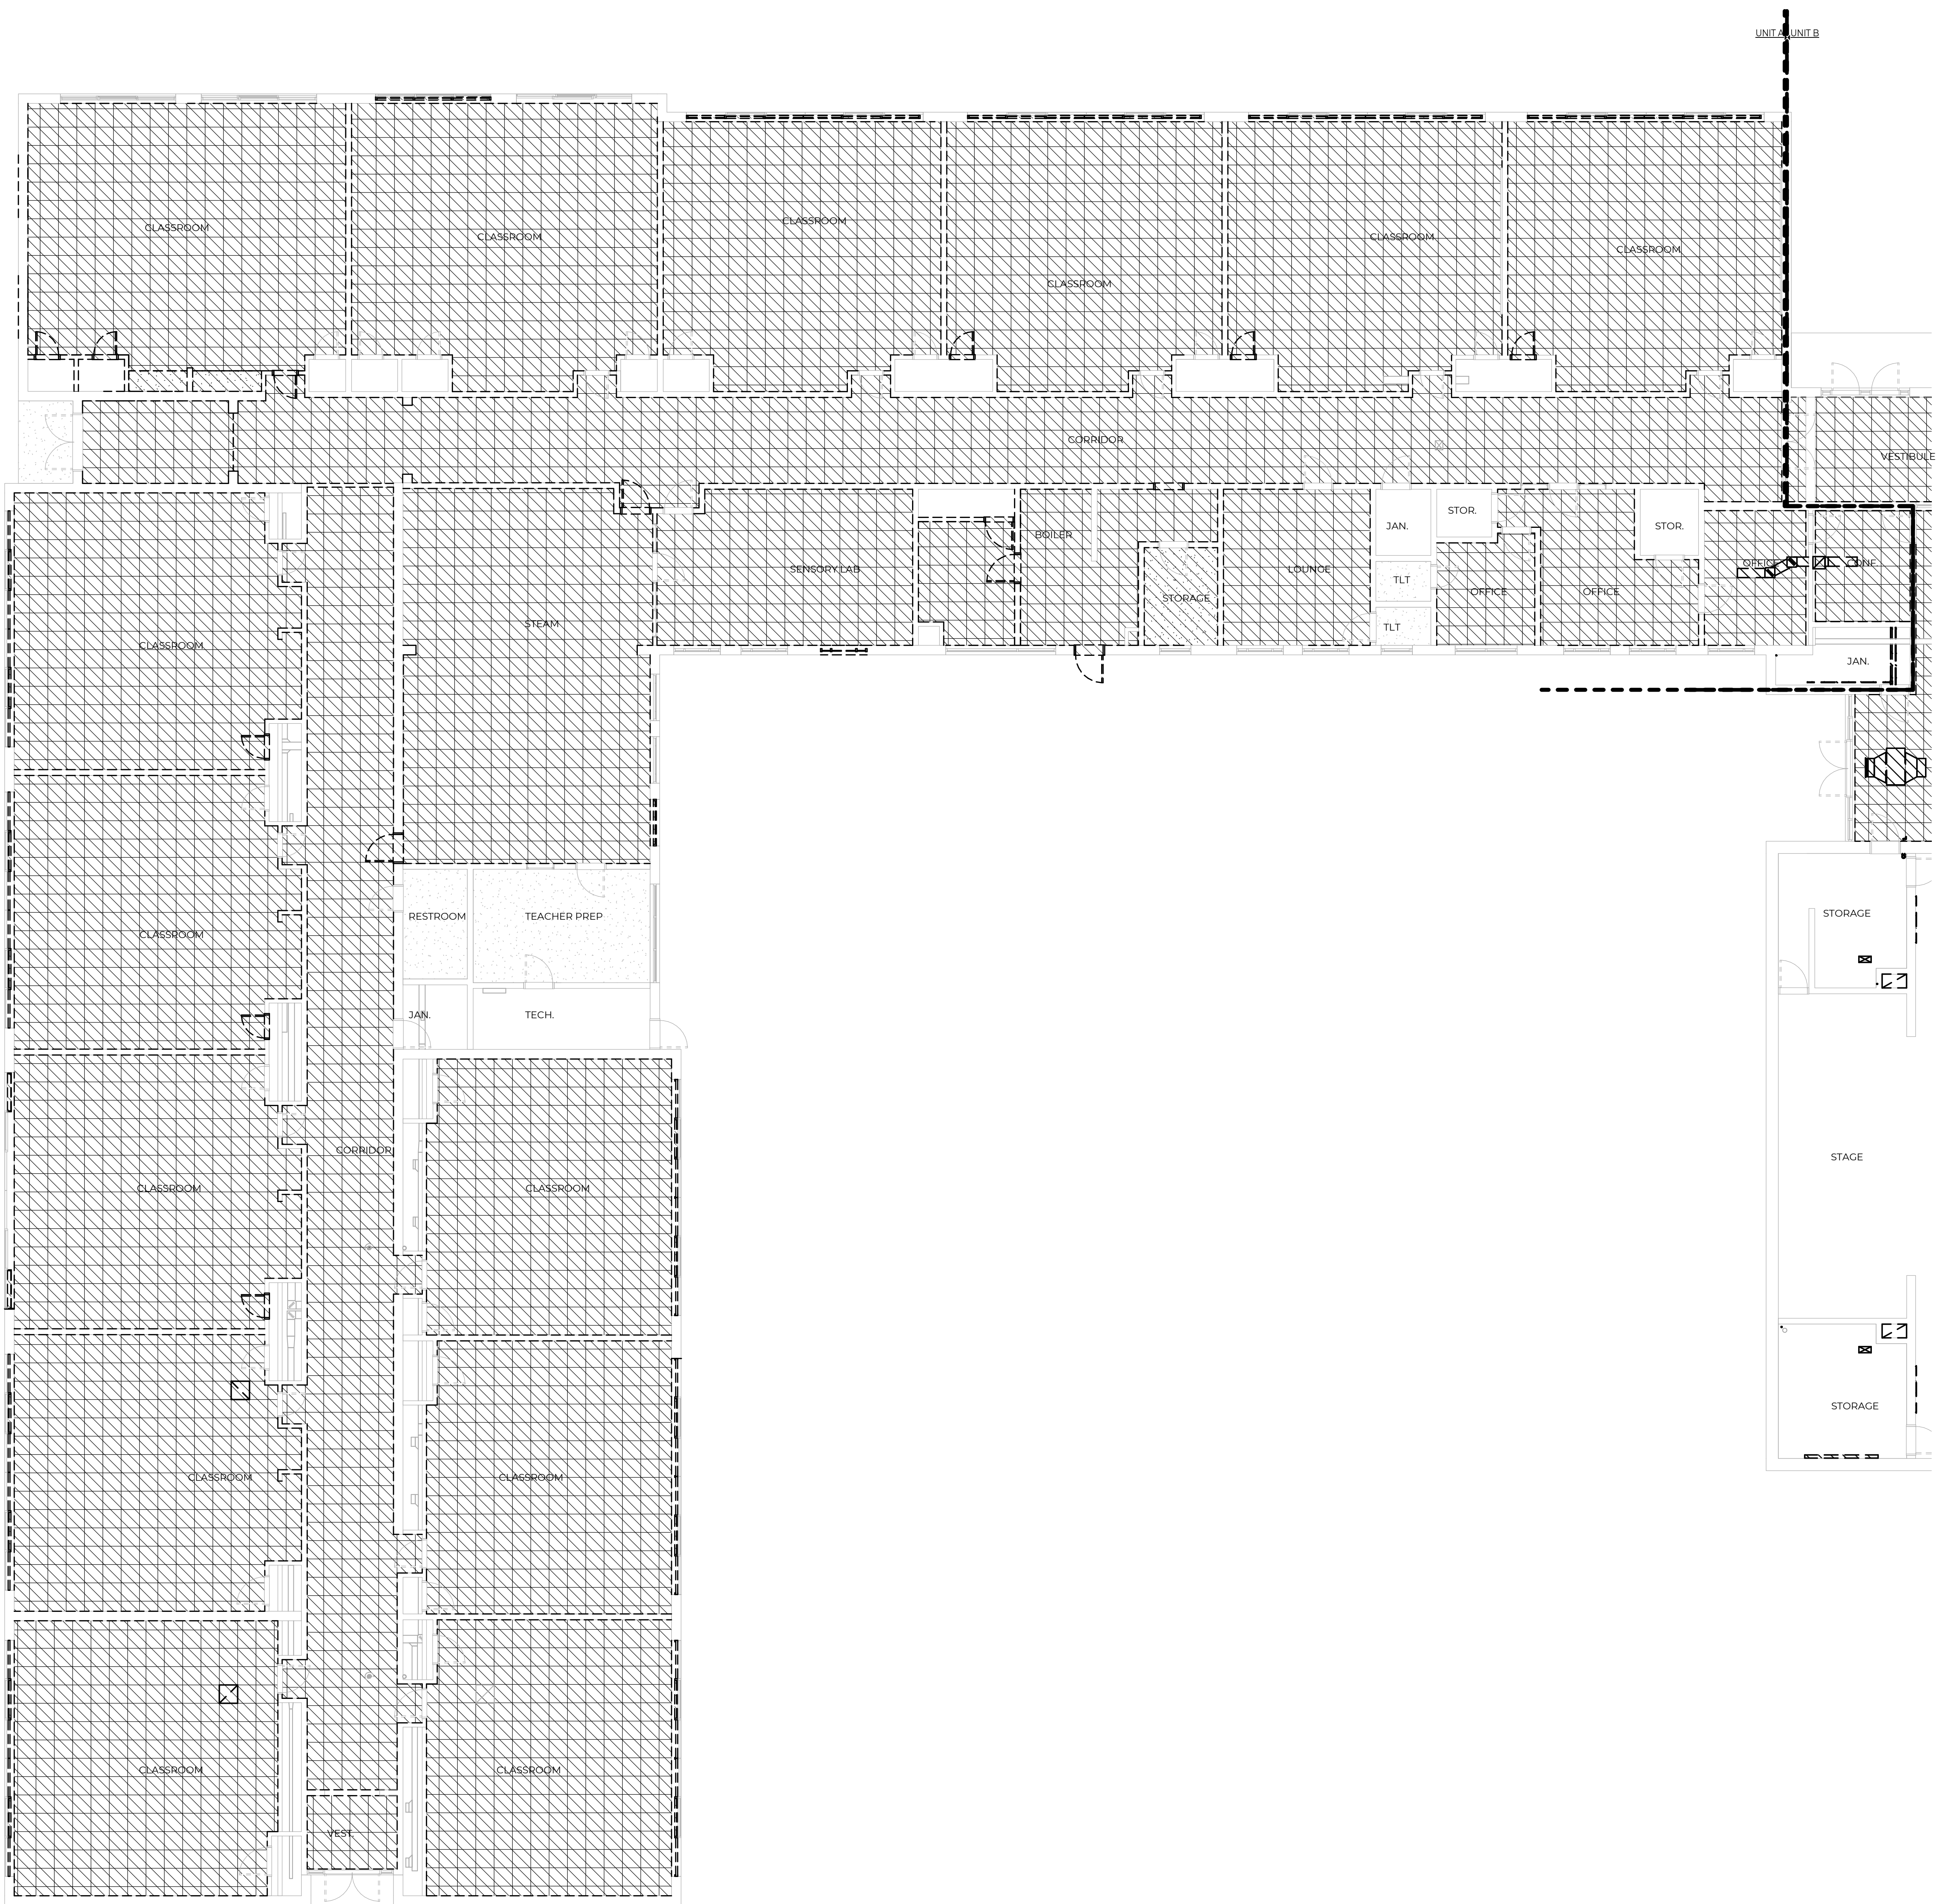


NR TH ROOF DEMOLITION PLAN
1/16" = 1'-0"

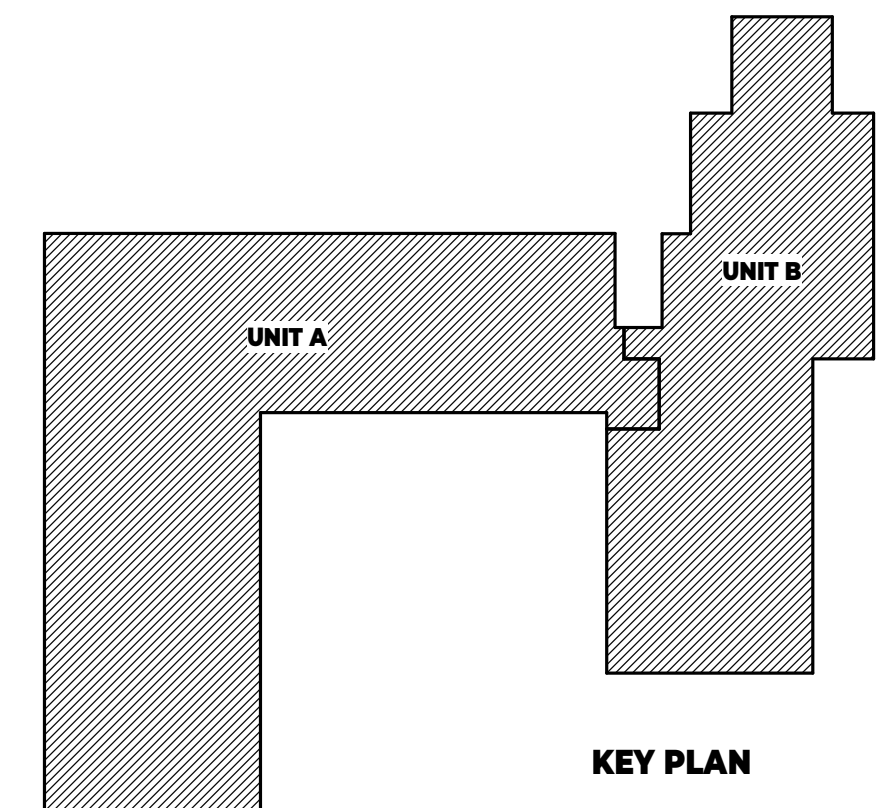

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1213 W Hackley Ave, Muskegon, MI 49441

| SYM | DATE | ISSUED FOR |
|--------------|----------------------|------------|
| ISSUE DATE | 03.08.2024 | |
| SHEET NAME | ROOF DEMOLITION PLAN | |
| SHEET NUMBER | D103 | |
| | PROJECT NO. 22.114 | |



NOTE DEMOLITION GENERAL NOTES


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NOTE DEMOLITION KEYED NOTES

1. REMOVE EXISTING DOOR, FRAME, HARDWARE, AND ANY WOOD TRIM.
2. REMOVE EXISTING WALL AND ANY ITEMS ATTACHED.
3. REMOVE PORTION OF EXISTING WALL FOR NEW OPENING - COORDINATE WITH NEW WORK. CONSERVE BRICK FOR TOOTHING IN OF DOORS AROUND OPENINGS.
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7. SCRAPE PAINT AND PREP FOR NEW.
8. REMOVE CEILING AND GRID.
9. REFER TO INTERIOR DRAWINGS FOR SCOPE OF REMOVAL AND REPLACEMENT AT CLASSROOM RESTROOMS.
10. REMOVE WOOD PANELING - PATCH AND REPAIR WALL AS NEEDED.

LEGEND REFLECTED CEILING DEMOLITION LEGEND

1. REMOVE FLOORING AND BASE. PREP FOR NEW.
2. REMOVE EXISTING WALL AND CEILING TO BE REMOVED.
3. CONTRACTOR TO COORDINATE AND REMOVE ADDITIONAL CEILINGS AS REQUIRED TO INSTALL NEW PARTITIONS.

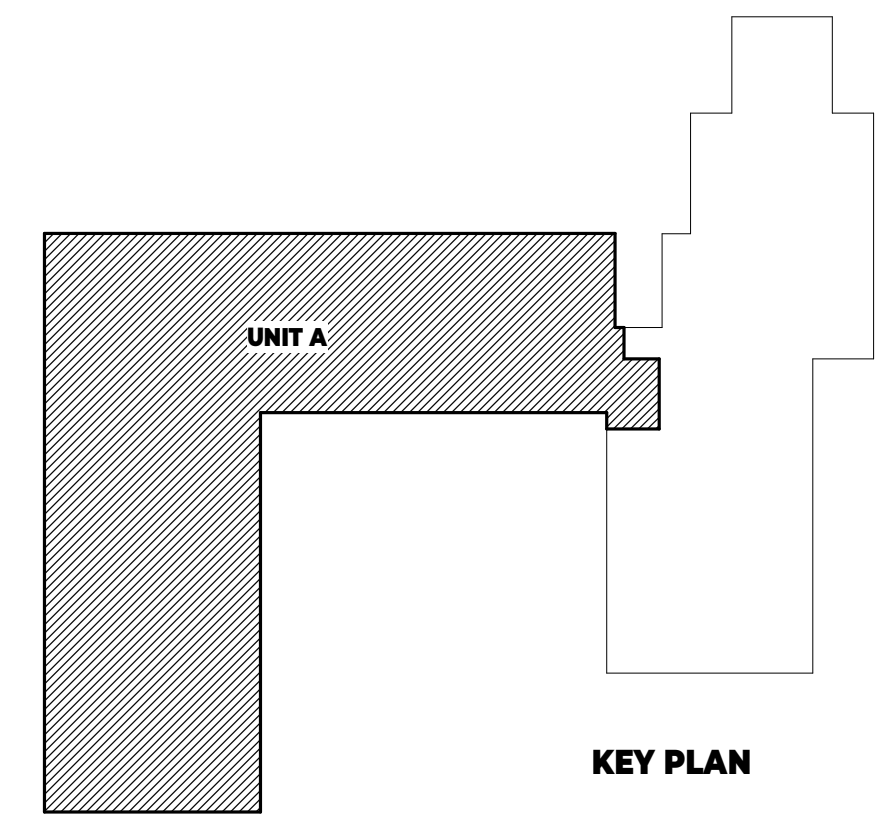

NR TR FIRST FLOOR REFLECTED CEILING PLAN
1/8" = 1'-0"

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|---|------------|------------|
| SYM | DATE | ISSUED FOR |
| | 03.08.2024 | |
| ISSUE DATE | | |
| SHEET NAME FIRST FLOOR REFLECTED CEILING DEMOLITION PLAN - UNIT A | | |
| SHEET NUMBER | | |
| D201A | | |
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DEMOLITION GENERAL NOTES


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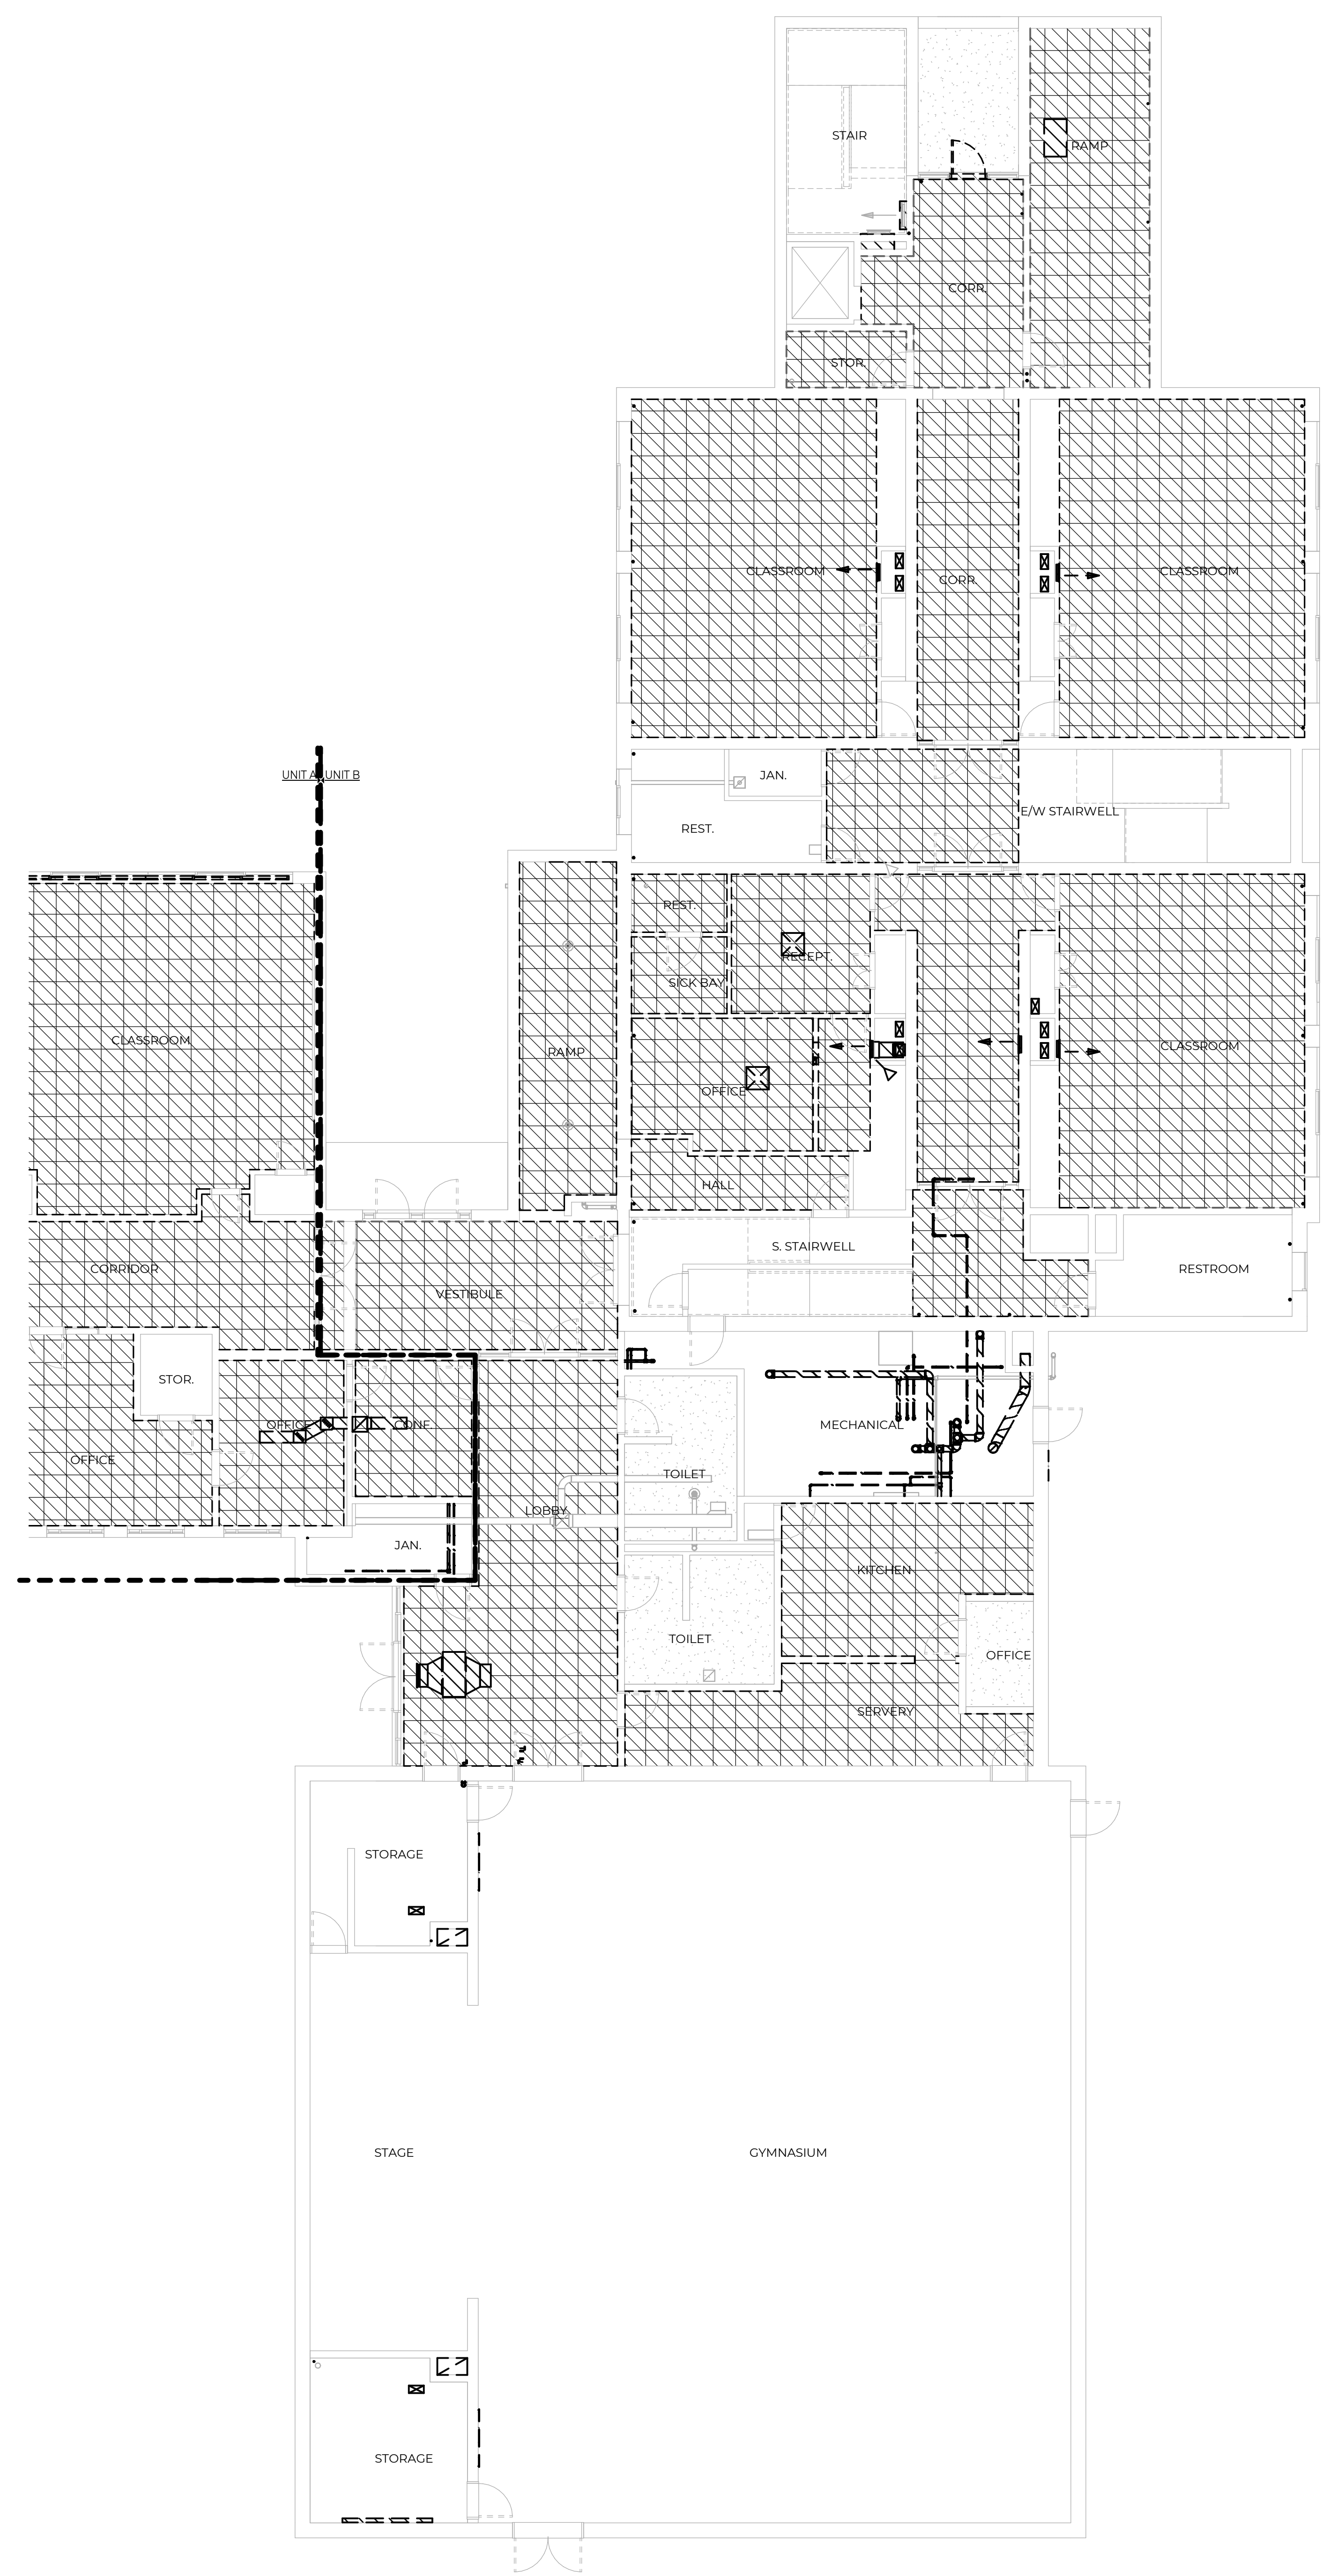
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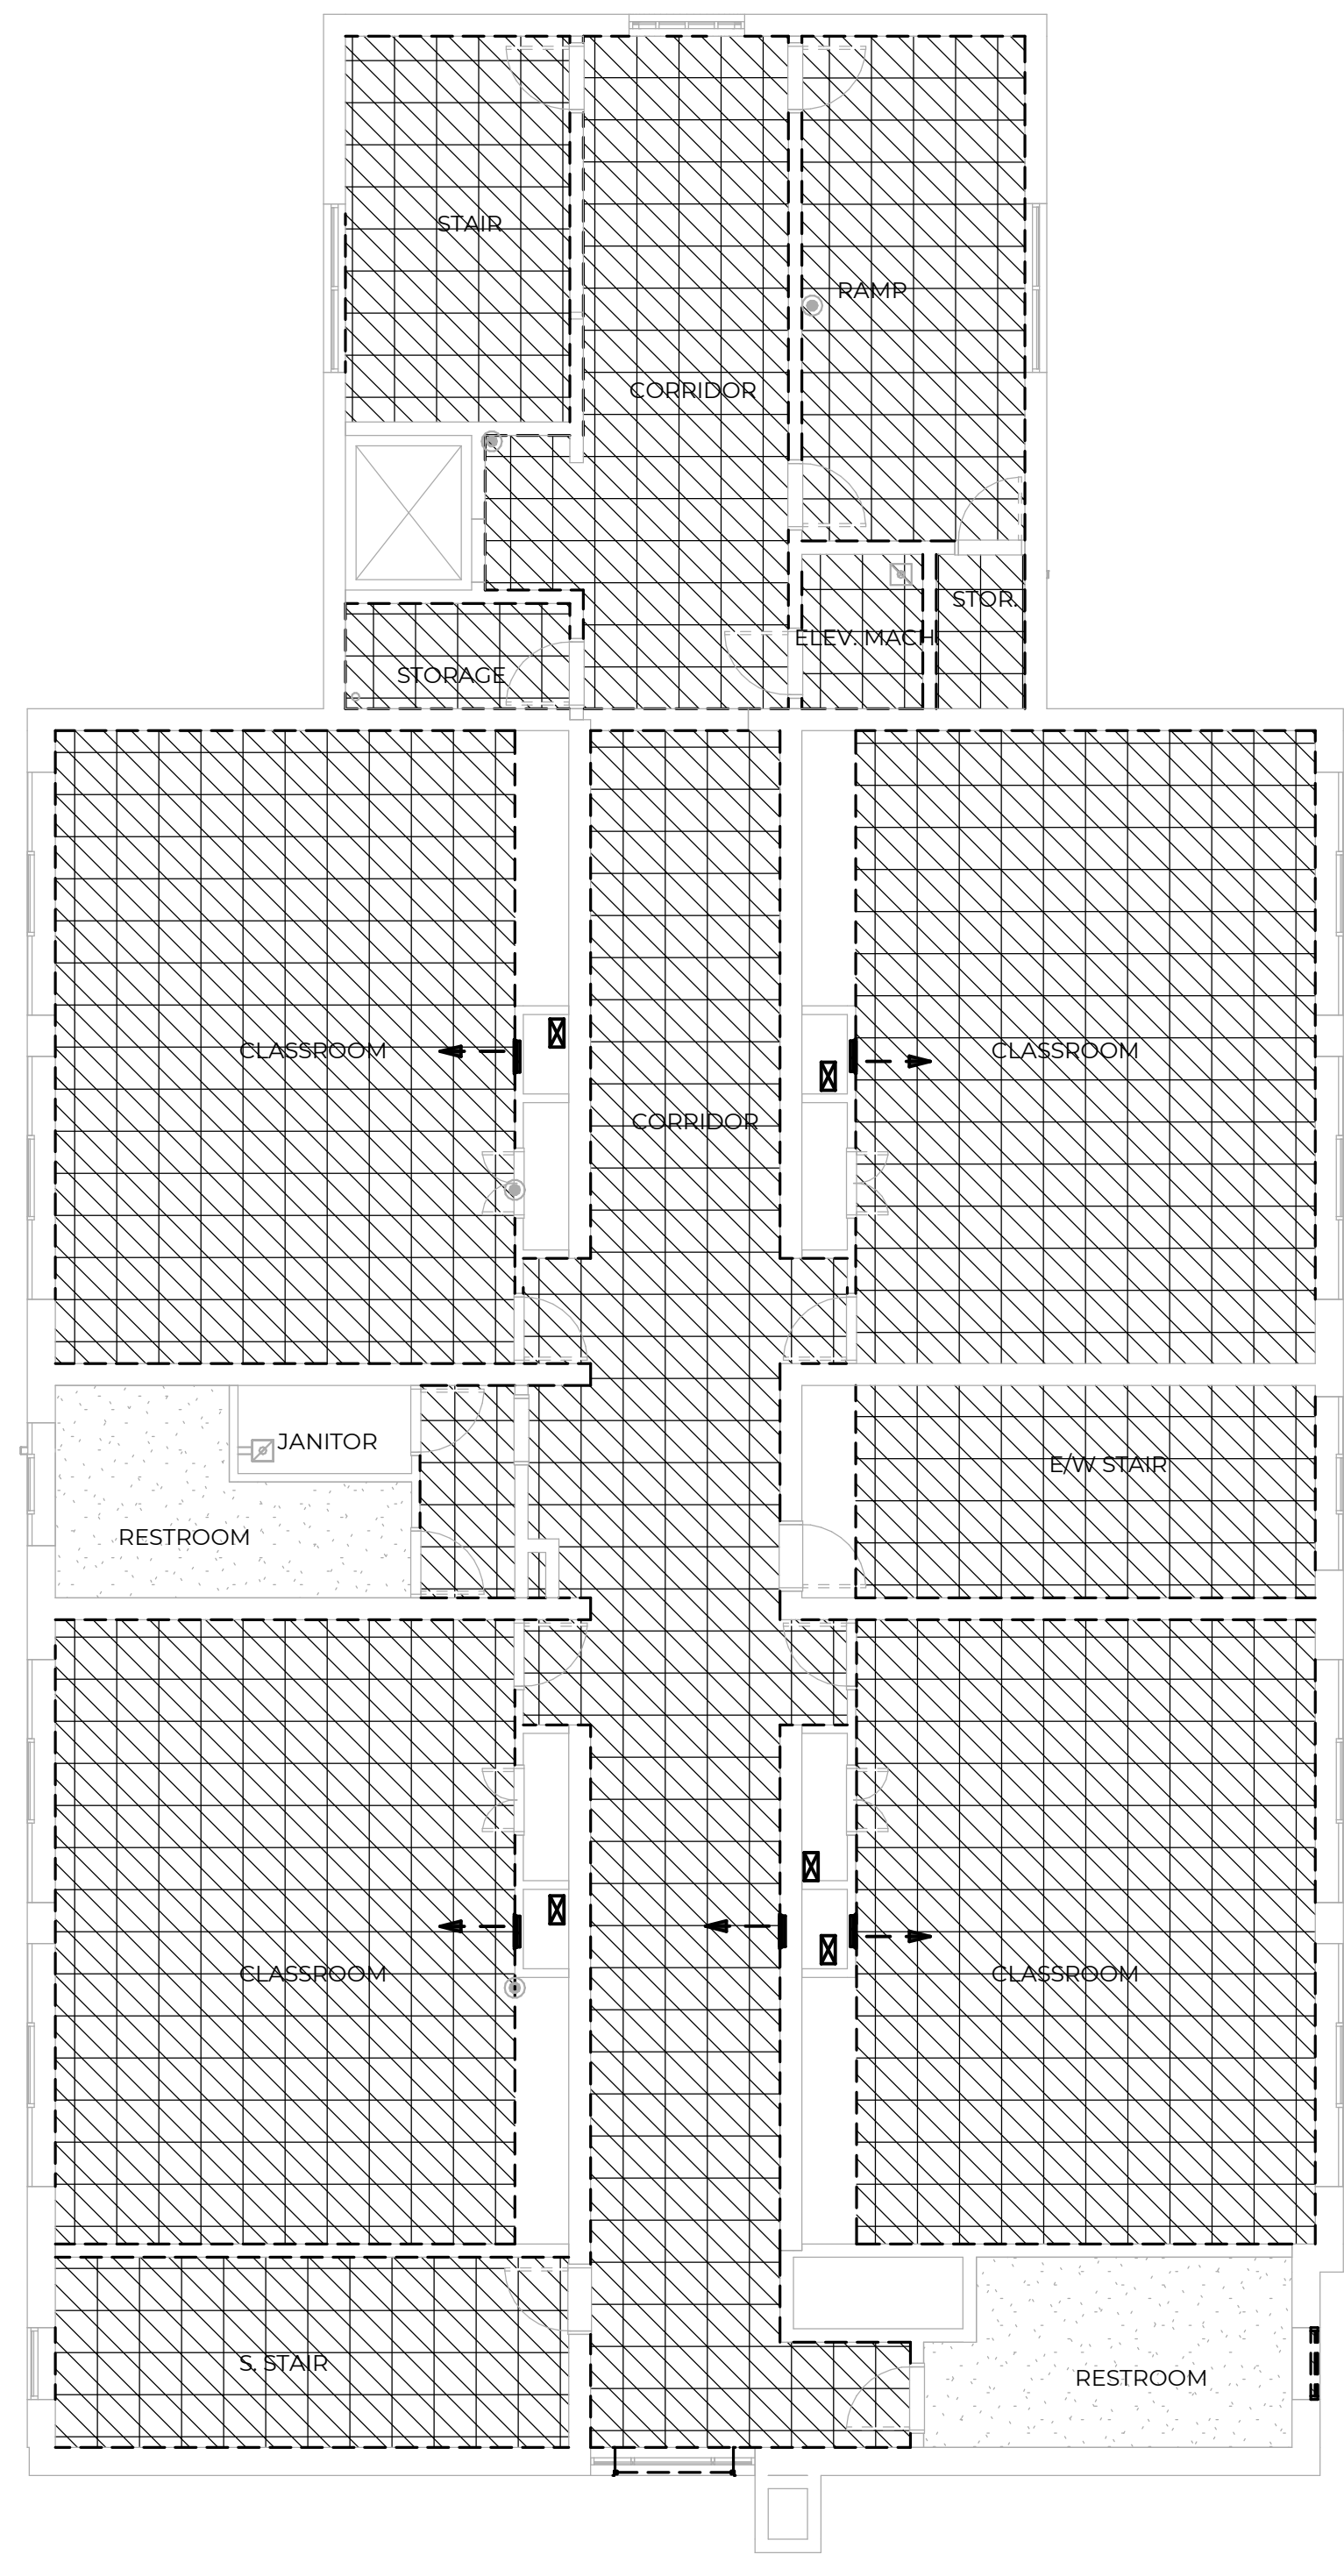
REFLECTED CEILING DEMOLITION LEGEND

1. CEILINGS WITH HATCH ARE TO BE REMOVED IN ITS ENTIRETY.
2. REFER TO MECHANICAL, PLUMBING, ELECTRICAL OR TECHNOLOGY DRAWINGS FOR REMOVAL OF EXISTING DEVICES, DIFFUSERS, LIGHTING, ETC. AND OTHER WORK RELATED TO DEMOLITION.
3. CONTRACTOR TO COORDINATE AND REMOVE ADDITIONAL CEILINGS AS REQUIRED TO INSTALL NEW PARTITIONS.


 CEILING TO BE REMOVED.



NR TH FIRST FLOOR DEMOLITION CEILING PLAN
1/8" = 1'-0"

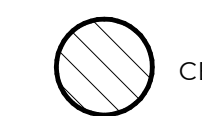

NR TH SECOND FLOOR DEMOLITION CEILING PLAN
1/8" = 1'-0"

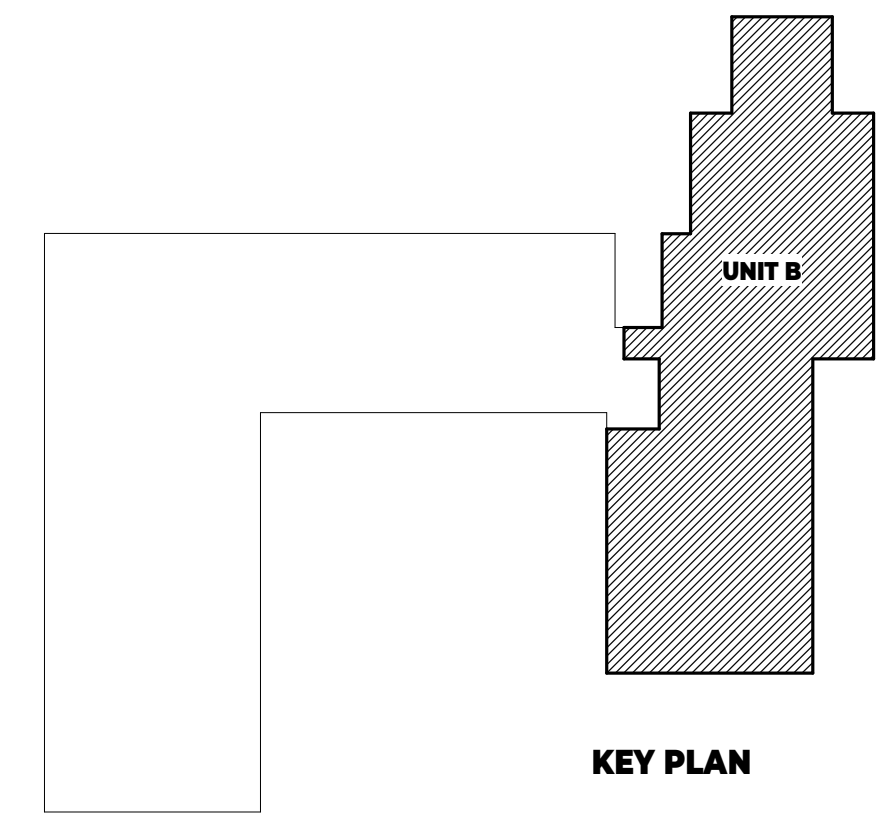

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SYM DATE ISSUED FOR

ISSUE DATE 03.08.2024

SHEET NAME 1ST AND 2ND FLOOR REFLECTED CEILING DEMOLITION PLAN - UNIT B

SHEET NUMBER

D201B

©2022 PROJECT NO. 22.114

STRUCTURAL NOTES

STRUCTURAL LOADS

- BUILDING CODE:
MICHIGAN RESIDENTIAL CODE 2015
MICHIGAN BUILDING CODE 2015
- STRUCTURAL DESIGN CODES AND STANDARDS:
DESIGN LOADS: ASCE 7-10
STEEL: AISI 360-10
CONCRETE: ACI 318-14
MASONRY: TMS402-13/ACI 530-13
WOOD: ANSI/APWC NDS-15
- COLD FORMED STEEL: AISI S100-12
- BUILDING RISK CATEGORY: II
- DESIGN LOADS:
WIND:
ULTIMATE DESIGN WIND SPEED: Vult = 115 MPH
NOMINAL DESIGN WIND SPEED: Vnd = 89 MPH
EXPOSURE CATEGORY: B
INTERNAL PRESSURE COEFFICIENT: ± 0.18
TOPOGRAPHIC FACTOR: Kzt = 1.0
DIRECTIONALITY FACTOR: Kd = 0.85
GUST EFFECT FACTOR: G = 0.85

GENERAL

- ADDITIONAL ENGINEERING EFFORT TO BRING BUILT CONDITIONS TO COMPLIANCE WITH STRUCTURAL DRAWINGS MAY RESULT IN ADDITIONAL FEE.
- THESE NOTES SUPPLEMENT THE PROJECT SPECIFICATIONS. SEE SPECIFICATIONS FOR ADDITIONAL REQUIREMENTS.
- CROSS CHECK ALL DIMENSIONS AND ELEVATIONS INDICATED. REPORT DISCREPANCIES FOR CLARIFICATION PRIOR TO STARTING CONSTRUCTION OR ORDERING MATERIALS. REFER TO ARCHITECTURAL DRAWINGS FOR DIMENSIONS NOT INDICATED ON THE STRUCTURAL DRAWINGS. DO NOT SCALE THESE DRAWINGS.
- DIMENSIONS AND ELEVATIONS OF EXISTING CONSTRUCTION INDICATED ARE APPROXIMATE AND FOR REFERENCE ONLY. CONTRACTOR SHALL FIELD VERIFY ALL DIMENSIONS AND ELEVATIONS PRIOR TO CONSTRUCTION. REPORT DISCREPANCIES PRIOR TO STARTING CONSTRUCTION OR ORDERING MATERIALS.
- IN THE CASE OF A CONFLICT WITHIN THE CONTRACT DOCUMENTS, INCLUDING DRAWINGS AND SPECIFICATIONS, THE MOST STRINGENT REQUIREMENTS WILL GOVERN.
- REFER TO ARCHITECTURAL, MECHANICAL, PLUMBING, ELECTRICAL, CIVIL, AND FOOD SERVICE DRAWINGS FOR SIZE AND LOCATION OF OPENINGS, SLEEVES, CONCRETE HOUSEKEEPING PADS, INSERTS, EMBEDDED ITEMS, CURBS, RAMPS, DRAINS, DEPRESSIONS, ETC. NOTIFY STRUCTURAL ENGINEER OF ANY DISCREPANCIES.
- REFER TO ARCHITECTURAL DRAWINGS FOR MASONRY AND DRYWALL NON-LOADBEARING PARTITIONS. PROVIDE SLP CONNECTIONS THAT ALLOW VERTICAL MOVEMENT AT THE HEADS OF SUCH PARTITIONS. CONNECTIONS SHALL SUPPORT THE TOP OF THE WALLS LATERALLY FOR THE CODE REQUIRED LATERAL LOAD.
- REPRODUCTION OF THE STRUCTURAL DRAWINGS FOR SUBMISSION AS SHOP DRAWINGS IS PROHIBITED. SUBMITTALS PRODUCED IN THIS MANNER WILL BE REJECTED.
- CONTRACTOR TO PROVIDE A SUBMITTAL FOR ENGINEER REVIEW FOR THE FOLLOWING:
CONCRETE MIX
CONCRETE REINFORCEMENT
STRUCTURAL STEEL

ABBREVIATIONS

- ARCH ARCHITECTURAL
- BOT BOTTOM
- BRG BEARING
- BWP BRACED WALL PANEL
- CJ CONTROL OR CONSTRUCTION JOINT
- CL CENTER LINE
- CLR CLEAR
- CMU CONCRETE MASONRY UNIT
- COLJN COLLJN
- CONT CONTINUOUS
- CVR COVER
- DSE DECK BEARING ELEVATION
- DF DOUG FIR-LARCH
- DA DIAMETER
- EA EACH
- EF EACH FACE
- EL ELEVATION
- EQ EQUAL
- EW EACH WAY
- FD FLOOR DRAIN
- FN FOUNDATION
- FO FLOOR OPENING
- GA GAUGE
- HGD HOT-DIP GALVANIZED
- HORIZ HORIZONTAL
- K KIP = 1,000 POUNDS
- MAX MAXIMUM
- MIN MINIMUM
- NTS NOT TO SCALE
- OC ON-CENTER
- PL PLATE
- PSF POUNDS PER SQUARE FOOT
- SIM SIMILAR
- SS STAINLESS STEEL
- T&B TOP-AND BOTTOM
- TF TOP OF FOOTING ELEVATION
- TP TOP OF PIER ELEVATION
- TS TOP OF STEEL ELEVATION
- TW TOP OF WALL ELEVATION
- TPY TYPICAL
- UNO UNLESS NOTED OTHERWISE
- VERT VERTICAL
- VIF VERIFY IN FIELD
- WF WITH
- WWF WELDED WIRE FABRIC

GENERAL CONDITIONS

- OBTAIN ALL NECESSARY STATE AND LOCAL PERMITS. WORK SHALL COMPLY WITH ALL LOCAL ORDINANCES INCLUDING BUT NOT LIMITED TO WORKING HOURS, NOISE LEVELS, DUST, ETC.
- IMPLEMENTING JOB SITE SAFETY AND CONSTRUCTION PROCEDURES IS THE SOLE RESPONSIBILITY OF THE CONTRACTOR.
- THE ENGINEER'S SITE VISITS ARE TO OBSERVE THE CONSTRUCTION. THEY ARE NOT A GUARANTEE OF THE CONTRACTOR'S QUALITY OF WORK, NOR DO THEY INDICATE RESPONSIBILITY FOR COORDINATION, SUPERVISION, OR SAFETY AT THE JOB SITE.
- FIELD VERIFY LOCATIONS OF EXISTING STRUCTURES, PIPING, CONDUITS, DUCTWORK, ETC. AND NOTIFY THE ENGINEER OF INTERFERENCES.

DEMOLITION

- PRIOR TO DEMOLITION, PROVIDE APPROPRIATE SHORING FOR BOTH VERTICAL LOADS AND BRACING AGAINST LATERAL DISPLACEMENT AS REQUIRED TO MAINTAIN STABILITY OF THE STRUCTURE. DESIGN OF TEMPORARY SHORING SYSTEMS IS PART OF THE CONTRACTOR'S MEANS AND METHODS AND IS THE RESPONSIBILITY OF THE CONTRACTOR.

FOUNDATIONS

- LOCATE ALL UNDERGROUND UTILITIES BEFORE STARTING WORK. CONTACT UTILITY LOCATING SERVICES PRIOR TO EXCAVATION. IN MICHIGAN CALL "MISS DIG" 800-486-7171 AT LEAST 72 HOURS PRIOR TO STARTING WORK.
- ANY EXISTING UTILITIES INDICATED ON DRAWINGS ARE BASED ON ORIGINAL CONSTRUCTION DRAWINGS AND SITE SURVEYS. EXACT UTILITY LOCATIONS AND ELEVATIONS OF UTILITIES MUST FIELD VERIFY BY THE CONTRACTOR PRIOR TO BEGINNING WORK.
- DO NOT REPAIR MISPLACED OR DAMAGED COLUMN ANCHOR BOLTS WITHOUT PRIOR APPROVAL BY THE STRUCTURAL ENGINEER.

CONCRETE

- ALL MATERIAL AND WORKMANSHIP SHALL BE IN ACCORDANCE WITH AMERICAN CONCRETE INSTITUTE (ACI) DOCUMENTS REFERENCED IN SPECIFICATIONS.
- MATERIAL PROPERTIES:

| LOCATION | 28 DAY Fc (PSI) | AIR CONTENT | MAX W/C RATIO |
|---------------------------------|-----------------|-------------|---------------|
| ALL CONCRETE EXPOSED TO WEATHER | 4,000 | 6% ± 1% | 0.50 |
| INTERIOR SLABS ON GRADE | 3,500 | NO TEST | 0.50 |

- REINFORCING BARS SHALL BE ASTM A615 GRADE 60 UNO TIES AND STIRRUPS ASTM A615 GRADE 40.
- PROVIDE CRUSHED LIMESTONE LARGE AGGREGATE AND AIR ENTRAINMENT WHERE CONCRETE IS EXPOSED TO WEATHER AND WHERE INDICATED.
- SEE SPECIFICATIONS FOR ALL TESTING REQUIREMENTS. SUBMIT EACH CONCRETE MIX DESIGN FOR REVIEW. SUBMITTAL SHALL CONSIST OF DESIGN MIXES FOR EACH TYPE AND STRENGTH OF CONCRETE AND INCLUDE DATA BY EITHER LABORATORY TRIAL MIX OR FIELD TEST DATA BASED PER ACI 116.
- ALL CONCRETE SHALL BE CURED FOR A MINIMUM OF 7 DAYS PRIOR TO REMOVAL OF FORMS. IF FORMS ARE REMOVED BEFORE THE END OF CURING PERIOD, CURT SURFACES WITH LIQUID CURING COMPOUND.
- PROVIDE DOWELS IN WALL FOOTINGS WITH EQUAL SIZE AND SPACING AS VERTICAL WALL STEEL UNO.
- ALL OPENINGS IN SLABS AND WALLS SHALL HAVE REINFORCING ON EACH SIDE EQUAL TO THE AMOUNT OF REINFORCING DISPLACED.
- ALL CONCRETE SLABS ON GRADE SHALL BE REINFORCED WITH 6"x6"-W1.4W1.4 WELDED WIRE FABRIC UNO. CONTRACTOR MAY SUPPLY FIBER REINFORCED CONCRETE IN AREAS SCHEDULED TO RECEIVE FLOOR COVERINGS AT DOSAGE RATES ACCORDING TO SPECIFICATIONS. IF FIBER REINFORCING IS USED, CONTROL JOINT SPACING SHALL NOT EXCEED 12' IN ANY DIRECTION.
- SEE ARCHITECTURAL DRAWINGS FOR SIZE, DEPTH, AND LOCATION OF DEPRESSED FLOOR SLABS REQUIRED.
- PROVIDE CLASS "B" TENSION LAP SPLICES FOR ALL BARS UNO.

| BAR @ Fc=3ksi | LAP LENGTH @ Fc=4ksi | 90° HOOK EXTENSION | 180° HOOK EXTENSION |
|---------------|----------------------|--------------------|---------------------|
| #3 | 22" | 19" | 6" |
| #4 | 26" | 22" | 6" |
| #5 | 36" | 31" | 10" |
| #6 | 43" | 37" | 12" |

- USE NON-SHRINK, NON-METALLIC GROUT UNDER ALL BASE PLATES, BEARING PLATES, AND SETTING PLATES.
- PROVIDE CONCRETE COVER OVER REINFORCING BARS AS FOLLOWS UNO:
A. CAST AGAINST AND PERMANENTLY EXPOSED TO EARTH = 2"
B. PERMANENTLY EXPOSED TO EARTH OR WEATHER, #5 AND SMALLER = 1 1/2"; #6 AND LARGER = 2"
C. NOT EXPOSED TO EARTH OR WEATHER, WALLS AND SLABS = 3/4" BEAMS AND COLUMNS = 1 1/2"

CONCRETE TESTING

- TESTING AGENCY: OWNER WILL ENGAGE A QUALIFIED INDEPENDENT TESTING AND INSPECTING AGENCY TO SAMPLE MATERIALS, PERFORM TESTS, AND SUBMIT TEST REPORTS DURING CONCRETE PLACEMENT, SAMPLING AND TESTING FOR QUALITY CONTROL. MAY INCLUDE THOSE SPECIFIED IN THIS ARTICLE.
- TESTING SERVICES: TESTING OF FRESH CONCRETE SAMPLES OF FRESH CONCRETE OBTAINED ACCORDING TO ASTM C172 SHALL BE PERFORMED ACCORDING TO THE FOLLOWING REQUIREMENTS:
A. TESTING FREQUENCY: OBTAIN AT LEAST ONE COMPOSITE SAMPLE FOR EACH 100 CUBIC YARD OR FRACTION THEREOF OF EACH CONCRETE MIX PLACED EACH DAY. WHEN FREQUENCY OF TESTING WILL PROVIDE FEWER THAN FIVE COMPRESSIVE-STRENGTH TESTS FOR EACH CONCRETE MIX, TESTING SHALL BE CONDUCTED FROM AT LEAST FIVE RANDOMLY SELECTED BATCHES OR FROM EACH BATCH IF FEWER THAN FIVE ARE USED.
B. SLUMP: ASTM C143. ONE TEST AT POINT OF PLACEMENT FOR EACH COMPOSITE SAMPLE, BUT NOT LESS THAN ONE TEST FOR EACH DAY'S POUR OF EACH CONCRETE MIX. PERFORM ADDITIONAL TESTS WHEN CONCRETE CONSISTENCY APPEARS TO CHANGE.
C. AIR CONTENT: ASTM C231. PRESSURE METHOD, FOR NORMAL-WEIGHT CONCRETE; ONE TEST FOR EACH COMPOSITE SAMPLE, BUT NOT LESS THAN ONE TEST FOR EACH DAY'S POUR OF EACH CONCRETE MIX.
D. CONCRETE TEMPERATURE: ASTM C1064. ONE TEST HOURLY WHEN AIR TEMPERATURE IS 40 DEGREES F AND BELOW AND WHEN 80 DEGREES F AND ABOVE, AND ONE TEST FOR EACH COMPOSITE SAMPLE.
E. COMPRESSIVE-STRENGTH TESTS: ASTM C39. TEST TWO LABORATORY-CURED SPECIMENS AT 7 DAYS AND TWO AT 28 DAYS. A COMPRESSIVE-STRENGTH TEST SHALL BE THE AVERAGE COMPRESSIVE STRENGTH FROM TWO SPECIMENS OBTAINED FROM THE SAME COMPOSITE SAMPLE AND TESTED AT THE AGE INDICATED. CAST AND FIELD CURE ADDITIONAL SETS OF STANDARD CYLINDER SPECIMENS IN SETS OF TWO FOR EACH COMPOSITE SAMPLE WHEN REQUIRED TO VERIFY STRENGTH OF IN PLACE CONCRETE FOR REMOVAL OF SHORING. SPECIMENS SHALL BE STORED ADJACENT TO AND CURED SIMILAR TO CONCRETE TO BE VERIFIED.
3. WHEN STRENGTH OF FIELD-CURED CYLINDERS (IF REQUIRED) IS LESS THAN 85 PERCENT OF COMPANION LABORATORY-CURED CYLINDERS, CONTRACTOR SHALL EVALUATE OPERATIONS AND PROVIDE CORRECTIVE PROCEDURES FOR PROTECTING AND CURING IN-PLACE CONCRETE.
4. STRENGTH OF EACH CONCRETE MIX WILL BE SATISFACTORY IF EVERY AVERAGE OF ANY THREE CONSECUTIVE COMPRESSIVE STRENGTH TESTS EQUALS OR EXCEEDS SPECIFIED COMPRESSIVE STRENGTH AND NO COMPRESSIVE-STRENGTH TEST VALUE FALLS BELOW SPECIFIED COMPRESSIVE STRENGTH BY MORE THAN 500 PSI.
5. TEST RESULTS SHALL BE REPORTED IN WRITING TO ENGINEER, CONCRETE MANUFACTURER, AND CONTRACTOR WITHIN 48 HOURS OF TESTING. REPORTS OF COMPRESSIVE-STRENGTH TESTS SHALL CONTAIN PROJECT IDENTIFICATION NAME AND NUMBER, DATE OF CONCRETE PLACEMENT, NAME OF CONCRETE TESTING AND INSPECTING AGENCY, LOCATION OF CONCRETE BATCH IN WORK, DESIGN COMPRESSIVE STRENGTH AT 28 DAYS, CONCRETE MIX PROPORTIONS AND MATERIALS, COMPRESSIVE BREAKING STRENGTH, AND TYPE OF BREAK FOR BOTH 7- AND 28-DAY TESTS.
6. NONDESTRUCTIVE TESTING: IMPACT HAMMER SONOSCOPE, OR OTHER NONDESTRUCTIVE DEVICE MAY BE PERMITTED BY ENGINEER BUT WILL NOT BE USED AS SOLE BASIS FOR APPROVAL OR REJECTION OF CONCRETE.
7. ADDITIONAL TESTS, TESTING AND INSPECTING AGENCY SHALL MAKE ADDITIONAL TESTS OF CONCRETE WHEN TEST RESULTS INDICATE THAT SLUMP, AIR ENTRAINMENT, COMPRESSIVE STRENGTHS, OR OTHER REQUIREMENTS HAVE NOT BEEN MET, AS DIRECTED BY ENGINEER. TESTING AND INSPECTING AGENCY MAY CONDUCT TESTS TO DETERMINE ADEQUACY OF CONCRETE BY CORED CYLINDERS COMPLYING WITH ASTM C42 OR BY OTHER METHODS AS DIRECTED BY ARCHITECT.

POST-INSTALLED ANCHORS

- POST INSTALLED ADHESIVE ANCHORS:
A. INSTALL PER MANUFACTURERS PRINTED INSTALLATION INSTRUCTIONS (MPI).
B. DO NOT INSTALL ANCHORS IN WET OR SATURATED CONCRETE.
C. DO NOT INSTALL ANCHORS IN CONCRETE LESS THAN 21 DAYS OLD OR UNTIL CONCRETE HAS REACHED ITS DESIGN STRENGTH, WHICHEVER COMES FIRST.
D. VERIFY ADHESIVE EXPIRATION DATE PRIOR TO INSTALLATION.
E. DO NOT CORE DRILL HOLES FOR ADHESIVE ANCHORS.
F. CLEAN HOLES PER MPI.
G. CURE ADHESIVE PER MPI PRIOR TO LOADING ANCHORS.
H. ADHESIVE FOR REBAR AND ANCHORS SHALL HAVE BEEN TESTED IN ACCORDANCE WITH AC308.4 AND ICC-ES ACI 308 FOR CRACKED CONCRETE AND SEISMIC APPLICATIONS.
I. ANCHOR DESIGN IS BASED ON ADHESIVE BOND STRENGTH PER ACI 308.4 TEMPERATURE CATEGORY B WITH INSTALLATIONS INTO DRY HOLES DRILLED USING A CARBIDE DRILL BIT INTO CRACKED CONCRETE THAT HAS CURED FOR AT LEAST 21 DAYS.
2. POST METALLECH MECHANICAL ANCHORS:
A. INSTALL PER MANUFACTURERS PRINTED INSTALLATION INSTRUCTIONS (MPI).
B. DO NOT CORE DRILL HOLES FOR MECHANICAL ANCHORS.
C. CLEAN HOLES PER MANUFACTURERS REQUIREMENTS.
D. INSTALL IN STRICT COMPLIANCE WITH MANUFACTURERS REQUIREMENTS.

MASONRY

- MATERIAL PROPERTIES:
MASONRY 28 DAY COMPRESSIVE STRENGTH: Fm = 2,000 PSI
CONCRETE MASONRY UNITS: 2,000 PSI ASTM C90
MORTAR (TYPE S): 2,000 PSI ASTM C270
GROUT: ASTM C476
GROUT 28 DAY COMPRESSIVE STRENGTH: 2,000 PSI
OPENING SIZE | STEEL LINTEL PER 4" OF WALL | 8" DEEP MASONRY LINTEL
0" TO 4'-0" | L4x3-12x14 | (2) #5 BOND BEAM
2. REFER TO ARCHITECTURAL DRAWINGS FOR MASONRY CONTROL JOINT LOCATIONS.
3. ALL MASONRY WALLS SHALL BE REINFORCED WITH LADDER TYPE HORIZONTAL JOINT REINFORCEMENT PLACED EVERY OTHER COURSE FOR RUNNING BOND AND EVERY COURSE FOR STACK BOND. PROVIDE GALVANIZED WIRE REINFORCEMENT WITH #6 GAUGE SIDE RODS AND #9 GAUGE CROSS RODS SPACED 18" OC. FOR TWO WYTHE WALLS, PROVIDE HOOK AND PINTEL TIES.
4. PROVIDE LINTELS PER THE FOLLOWING TABLE UNO ON THE DRAWINGS:
5. PROVIDE A MINIMUM OF 8" BEARING AT EACH END OF ALL LINTELS UNO.
6. VERTICAL REINFORCING SHALL BE LAPPED AND HELD IN POSITION WITH BAR POSITIONERS.
BAR | LAP LENGTH
#3 | 16"
#4 | 24"
#5 | 30"
#6 | 64"
#7 | 87"
7. NO CHASES, REBARS, CONDUITS OR TOOTHING OF MASONRY SHALL OCCUR IN MASONRY WALLS WITHIN 18" OF CENTERLINE OF BEAM BEARING.
8. GROUT SOLID ALL REINFORCED CELLS, CELLS BELOW GRADE, AND ALL CELLS BELOW FINISH FLOOR.
9. VERTICAL CELLS TO BE GROUTED SHALL HAVE VERTICAL ALIGNMENT SUFFICIENT TO MAINTAIN A TOTAL MINIMUM CLEAR AREA OF 3"x4" ALL OVERHANGS AND REBARS SHALL BE CLEANED FROM THE INSIDE OF CELLS PRIOR TO GROUTING.
10. REINFORCEMENT SHALL BE PLACED PRIOR TO GROUTING.
11. MAXIMUM HEIGHT OF GROUT POURS SHALL NOT EXCEED 5'-0" BETWEEN GROUT POURS. A HORIZONTAL CONSTRUCTION JOINT SHALL BE FORMED BY STOPPING GROUT 1 1/2" BELOW MORTAR JOINT EXCEPT AT THE TOP OF THE WALL.

STRUCTURAL STEEL

- MATERIAL PROPERTIES:
MATERIALS | ASTM | MIN YIELD STRESS (KSI) | TENSILE STRESS (KSI)
STRUCTURAL STEEL (WIDE FLANGE): A992 | 50 | 65
STRUCTURAL STEEL (ALL OTHERS): A36 | 36 | 58
STRUCTURAL TUBES (HSS): A500 Gr. C | 50 | 62
STRUCTURAL PIPE: A53 Gr. B | 35 | 60
WELDING ELECTRODES: AWS E1-186 | - | -
3/4" DIAMETER BOLTS: A325 | - | -
ANCHOR RODS: F1554 Gr. 36 | 36 | 58
NUTS: A307 | - | -
WASHERS: F436 CIRCULAR | - | -
2. FIELD ALTERATIONS OF STRUCTURAL MEMBERS ARE NOT PERMITTED WITHOUT APPROVAL OF THE STRUCTURAL ENGINEER.
3. STEEL COLUMNS SHALL EXTEND TO WITHIN 1" OF TOP OF BEAMS UNO.
4. ERECTION CONTRACTOR SHALL PROVIDE ADEQUATE TEMPORARY BRACING TO RESIST WIND LOADS UNTIL ALL FINAL CONNECTIONS OF THE STEEL FRAME, METAL DECK, AND SHEAR WALLS ARE COMPLETED.
5. FERO BREAK-AWAY FIRE-RELEASE CONNECTORS ARE MANUFACTURED BY FERO CORPORATION, 15305-117 AVENUE, EDMONTON, ALBERTA, CANADA T5M 3A4, (780)455-5598, WWW.FEROCORP.COM.



4650 Plainfield Avenue NE, Suite A
Grand Rapids, MI 49525
Phone (616) 365-9733
compeg.com

Designed By: GCS
Drawn By: TNU

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MPS GLENSIDE
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 1213 W Hackley Ave, Muskegon, MI 49441

REVISIONS

SYM DATE ISSUED FOR

ISSUE DATE

03/08/2024



SHEET NAME

STRUCTURAL NOTES


SHEET NUMBER

S001

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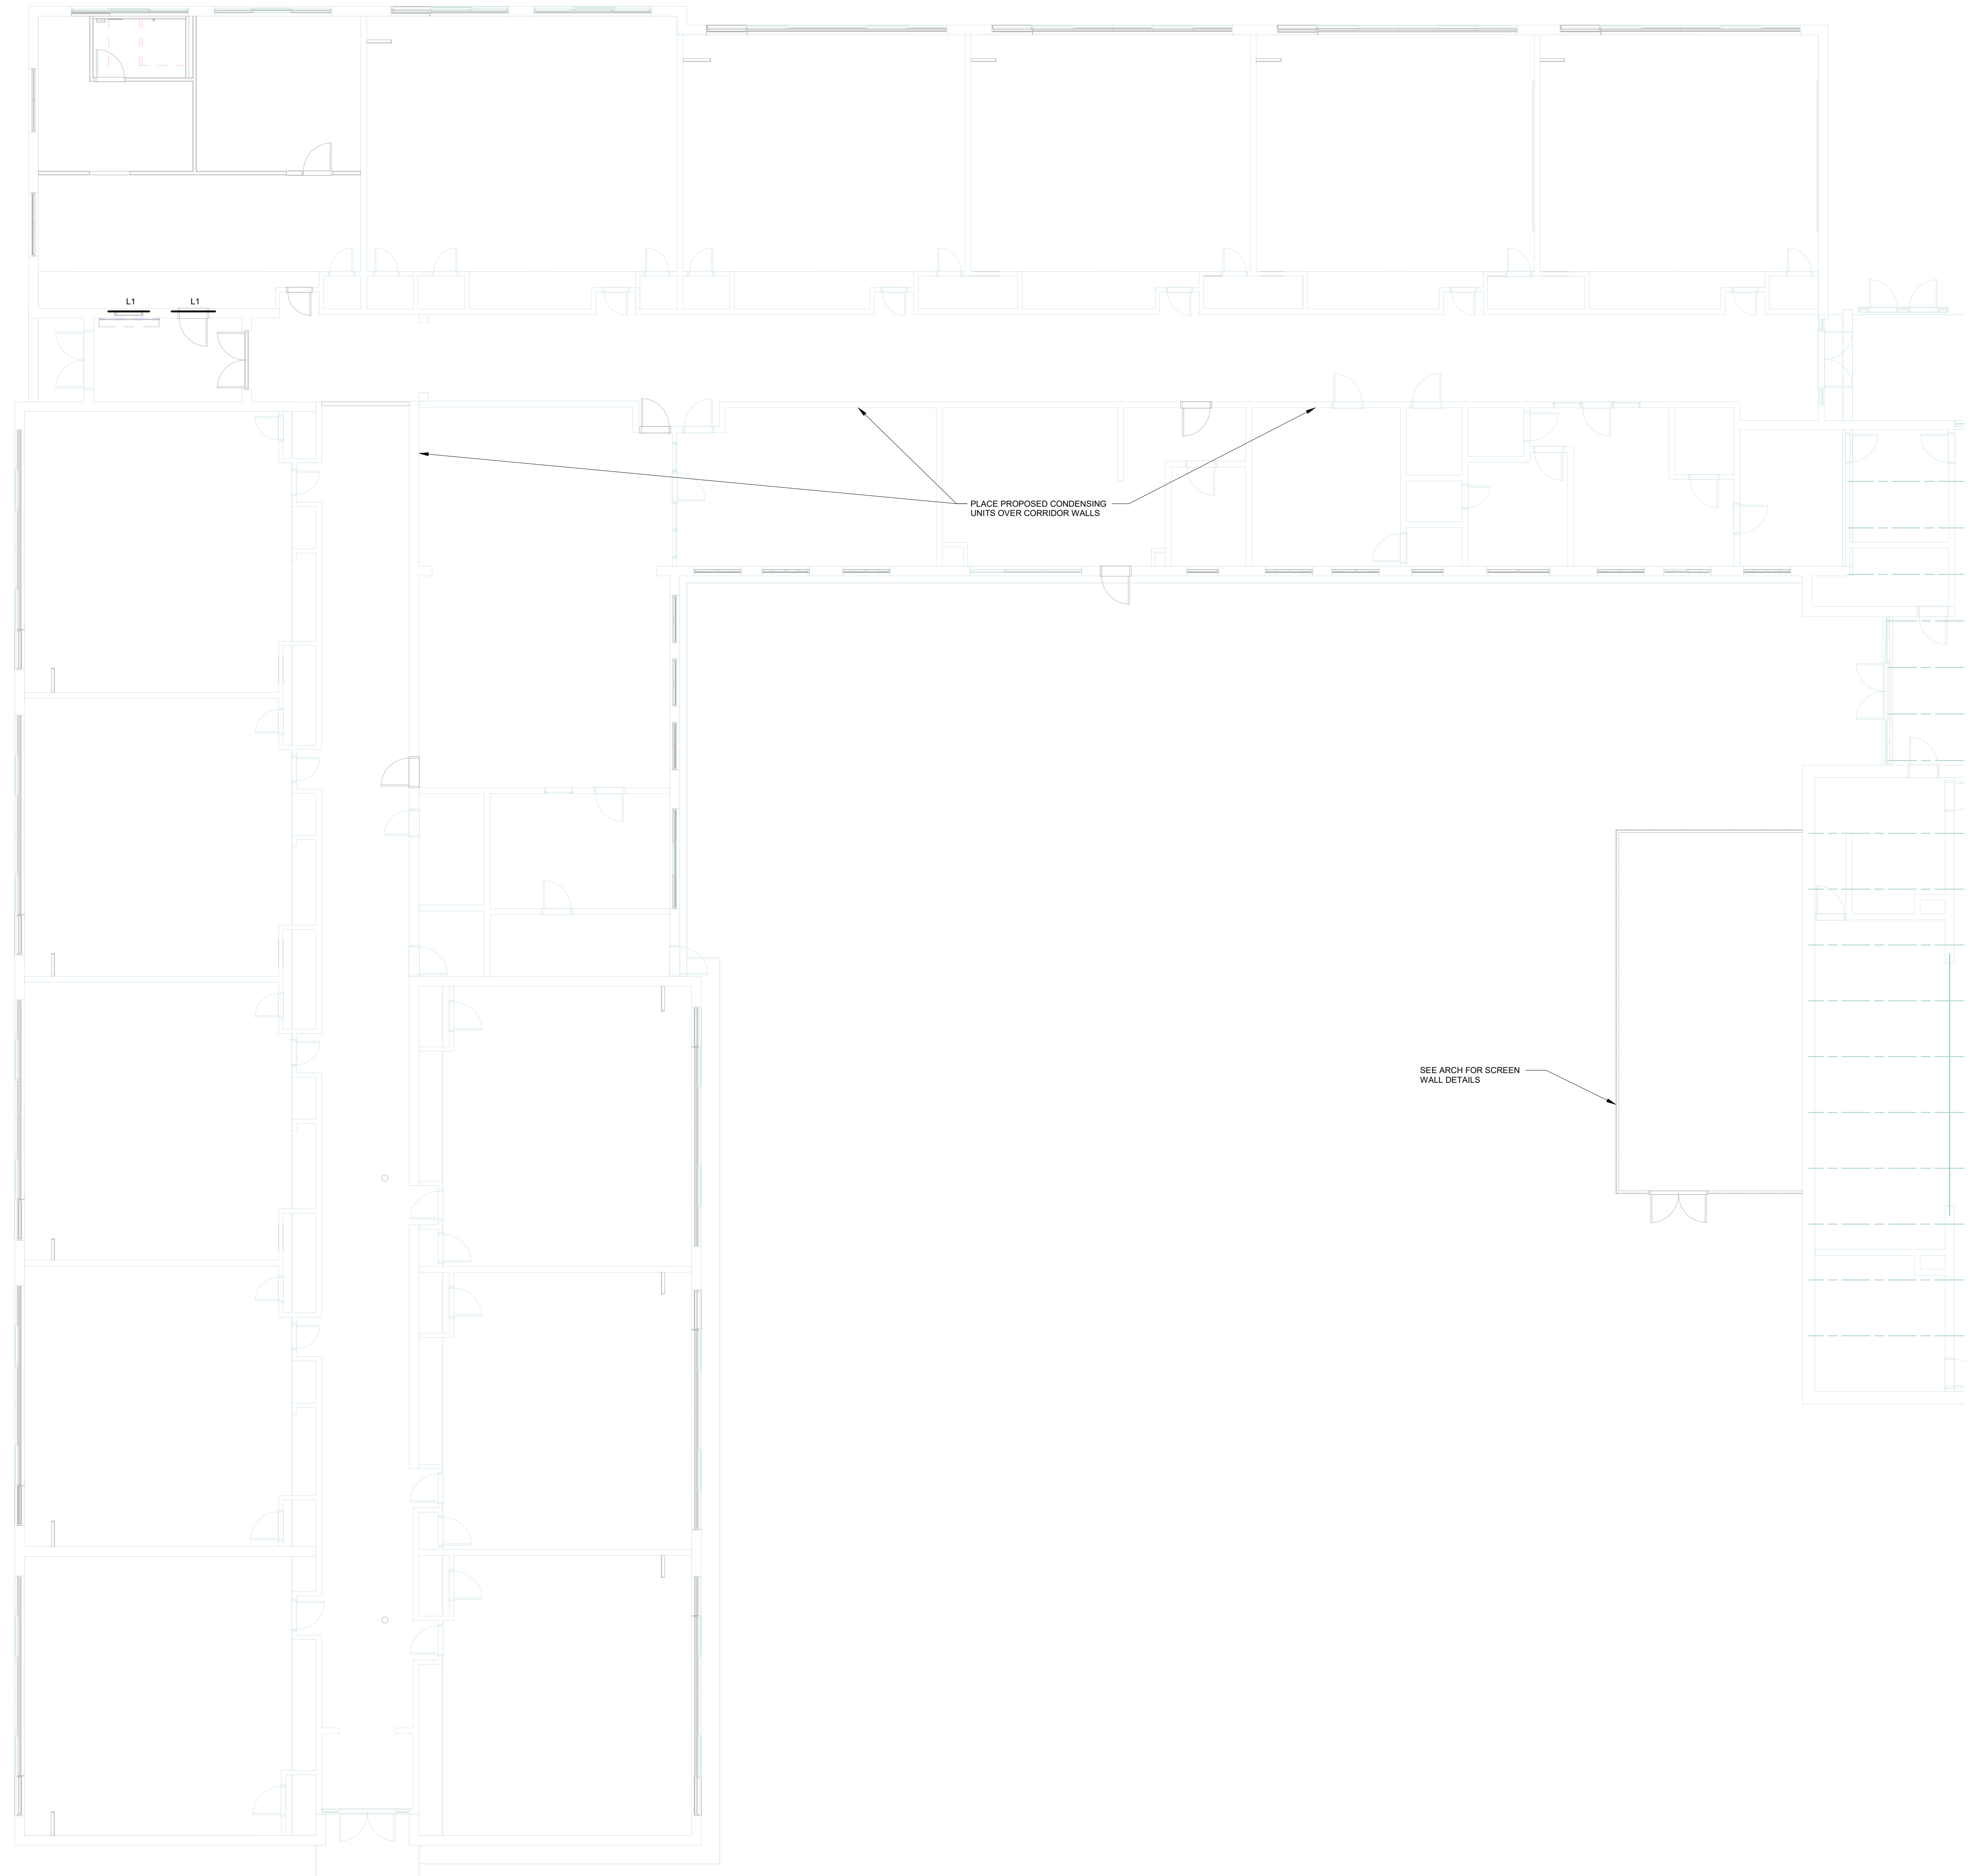
1 **TURNED DOWN SLAB EDGE**
S101A 1/2" = 1'-0"

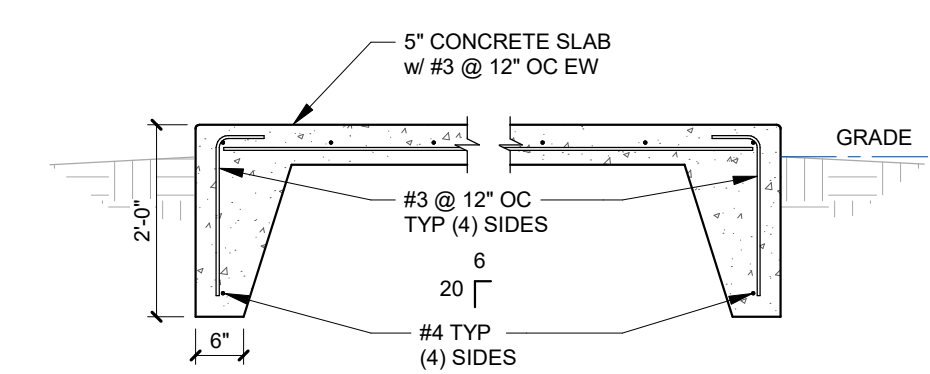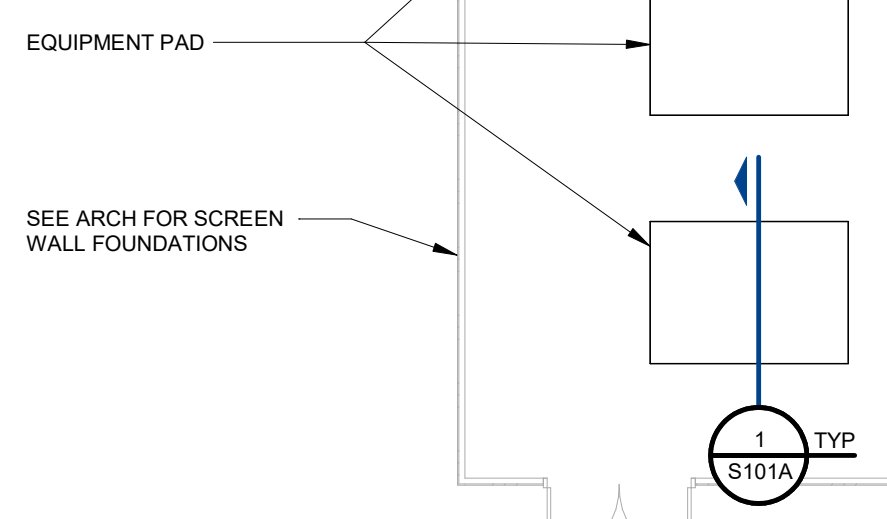


FOUNDATION PLAN - UNIT A
SCALE: 1/8" = 1'-0"
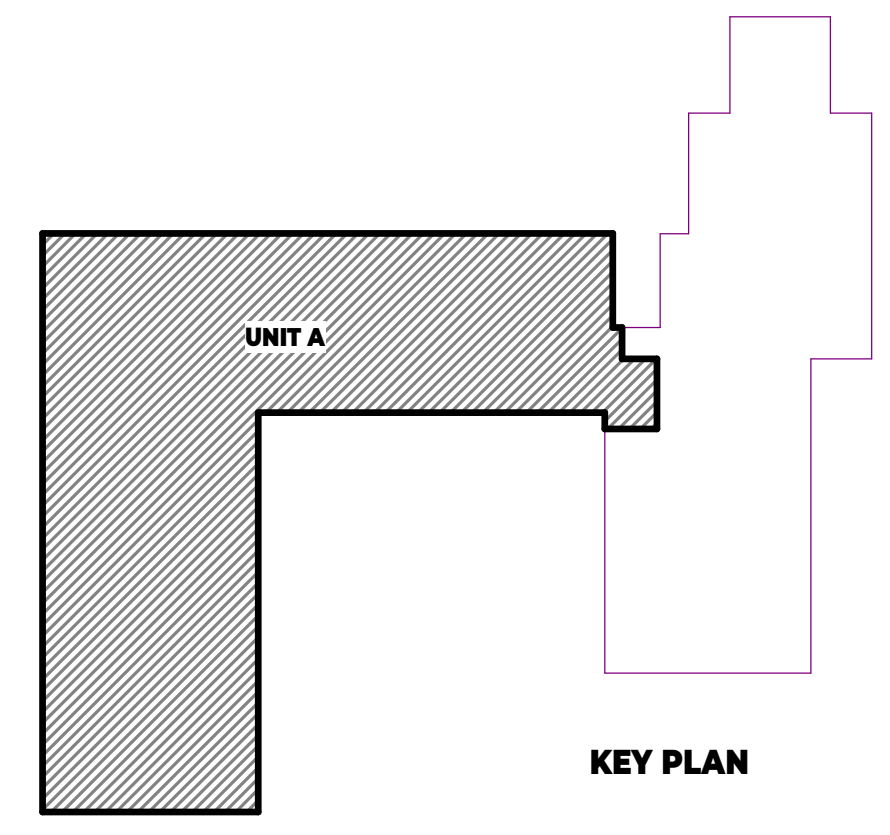
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1213 W Hackley Ave, Muskegon, MI 49441

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|---------------------------------|------------|------------|
| | 03/08/2024 | |
| ISSUE DATE | | |
| FOUNDATION PLAN - UNIT A | | |
| SHEET NAME | | |
| S101A | | |
| SHEET NUMBER | | |
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- ROOF FRAMING NOTES**
1. FIELD VERIFY ALL DIMENSIONS AND ELEVATIONS PRIOR TO ORDERING MATERIALS AND STARTING CONSTRUCTION.
 2. SEE S001 FOR STRUCTURAL NOTES.



MASONRY LINTEL TYPES
NOT TO SCALE
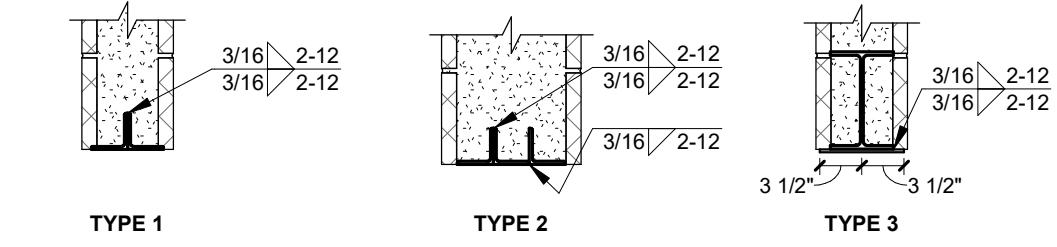
| MASONRY LINTEL SCHEDULE | | | | | |
|-------------------------|-----------------------|-----------|--------|---------|------------|
| MARK | SIZE | WALL TYPE | BRG PL | BEARING | NOTES |
| L1 | (2) L3 1/2x3 1/2x5/16 | 1 | - | 8" | 2 |
| L2 | (3) L5x3 1/2x5/16 | 2 | - | 8" | 2, 3 |
| L10 | WBx10 w/ 1/4" B7M PL | 3 | - | 8" | 2, 3, 4, 5 |

- MASONRY LINTEL SCHEDULE NOTES**
1. SEE TYPICAL LINTEL BEARING DETAIL FOR ADDITIONAL INFORMATION.
 2. GROUT CORE TWO COURSES BELOW LINTEL BEARING.
 3. GALVANIZED AT EXTERIOR WALLS.
 4. BOTTOM PLATE WIDTH TO BE 1" LESS THAN THE NOMINAL THICKNESS OF THE WALL.
 5. EXTEND BOTTOM PLATE FULL LENGTH OF LINTEL.
 6. CAVITY WIDTHS GREATER THAN 4" NOMINAL SHALL HAVE ENGINEERED VENEER TIES.



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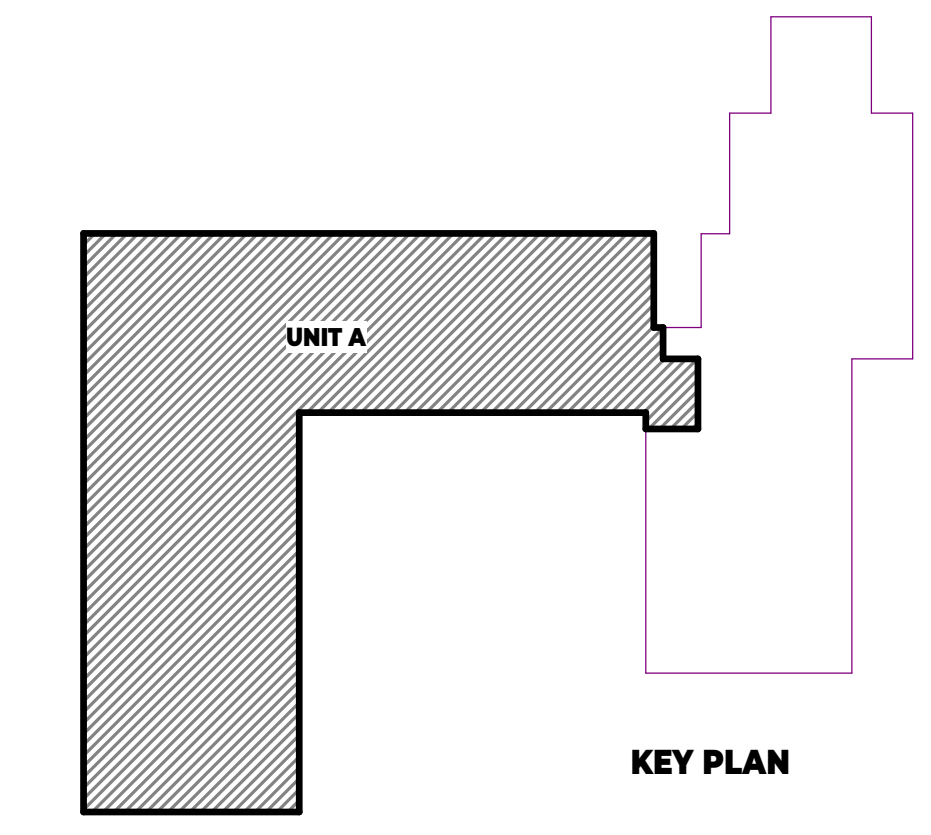
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| | | |

ISSUE DATE: 03/08/2024

SHEET NAME: ROOF FRAMING PLAN - UNIT A

SHEET NUMBER: **S301A**

ROOF FRAMING PLAN - UNIT A
SCALE: 1/8" = 1'-0"





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SYM DATE ISSUED FOR


ISSUE DATE 03/08/2024

SHEET NAME ROOF FRAMING PLAN - UNIT B


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S302B

PROJECT NO. 22.114

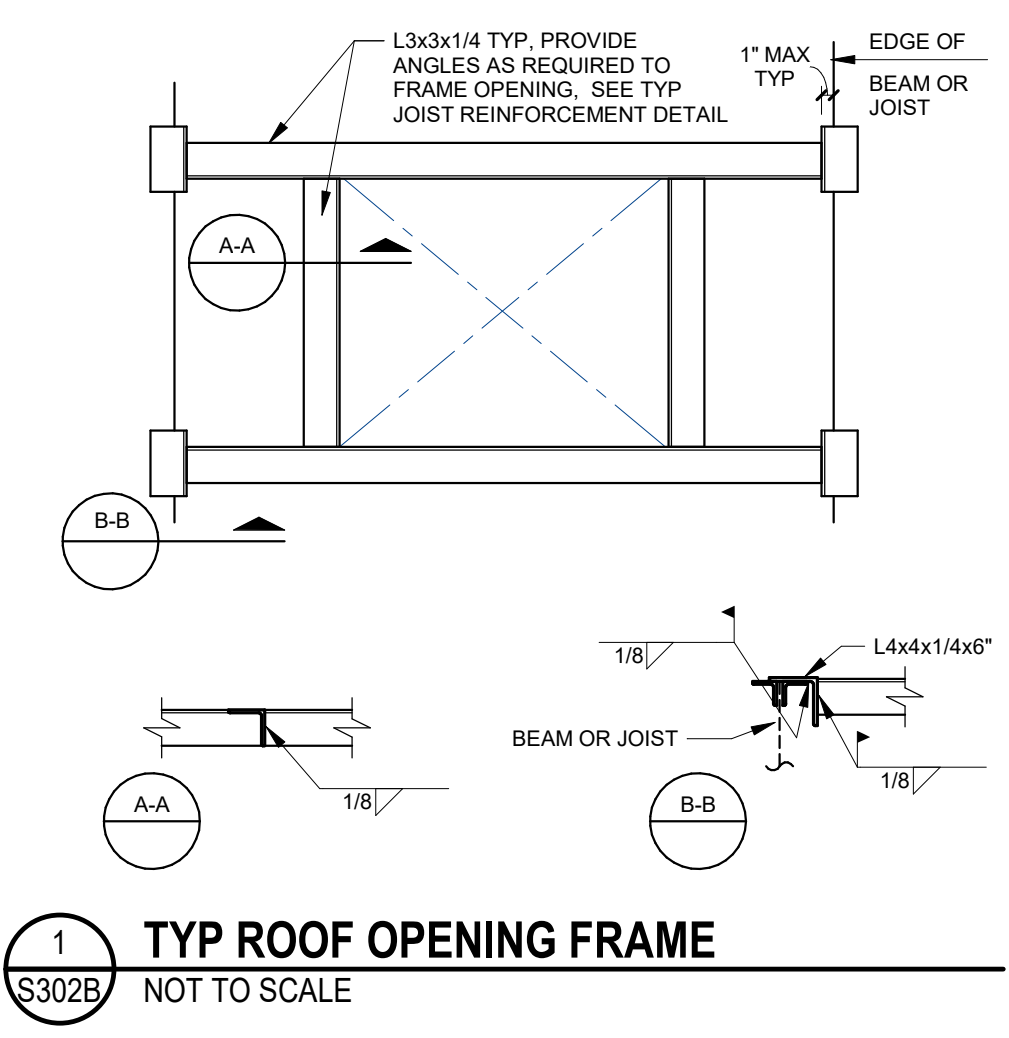


ROOF FRAMING NOTES
1. FIELD VERIFY ALL DIMENSIONS AND ELEVATIONS PRIOR TO ORDERING MATERIALS
2. SEE S001 FOR STRUCTURAL NOTES.

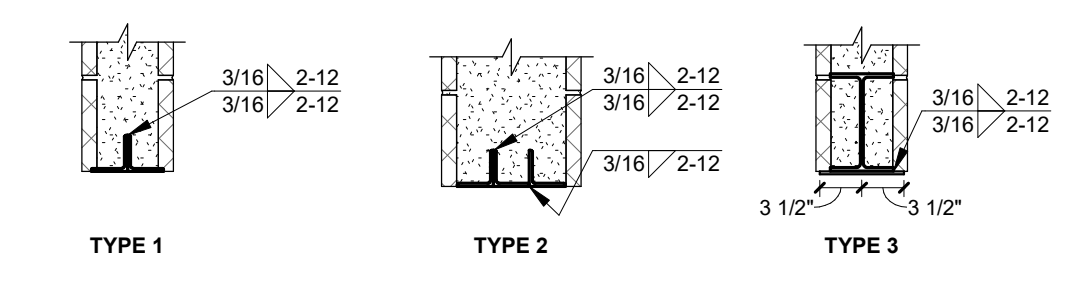


MASONRY LINTEL TYPES
NOT TO SCALE

| MASONRY LINTEL SCHEDULE | | | | | |
|-------------------------|-----------------------|-----------|--------|---------|------------|
| MARK | SIZE | WALL TYPE | BRG PL | BEARING | NOTES |
| L1 | (2) L3 1/2x3 1/2x5/16 | 1 | 8" | 2 | |
| L2 | (3) L5x3 1/2x5/16 | 2 | - | 8" | 2, 3 |
| L10 | W8x10 w/ 14" B7M PL | 3 | - | 8" | 2, 3, 4, 5 |


MASONRY LINTEL SCHEDULE NOTES
1. SEE TYPICAL LINTEL BEARING DETAIL FOR ADDITIONAL INFORMATION.
2. GROUT CORE TWO COURSES BELOW LINTEL BEARING.
3. GALVANIZED AT EXTERIOR WALLS.
4. BOTTOM PLATE WIDTH TO BE 1" LESS THAN THE NOMINAL THICKNESS OF THE WALL.
5. EXTEND BOTTOM PLATE FULL LENGTH OF LINTEL.
6. CAVITY WIDTHS GREATER THAN 4" NOMINAL SHALL HAVE ENGINEERED VENEER TIES.

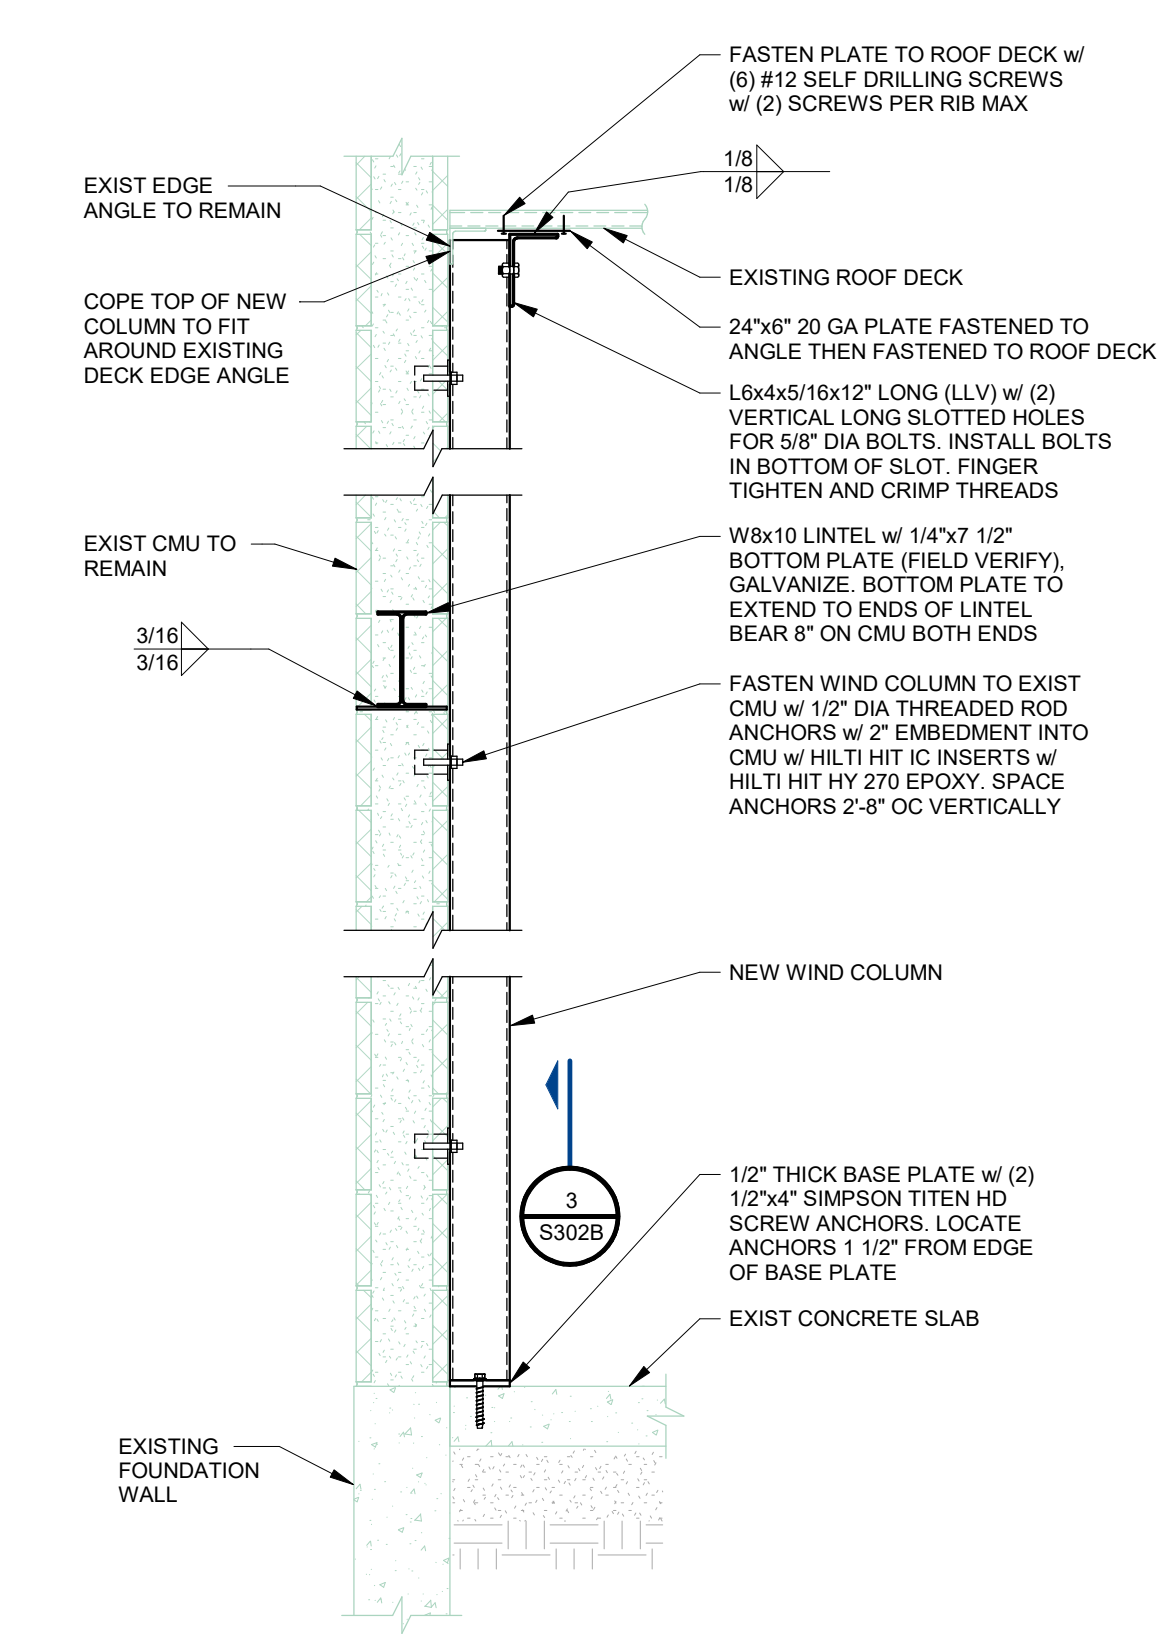


2 WIND COLUMN SECTION
3/4" = 1'-0"

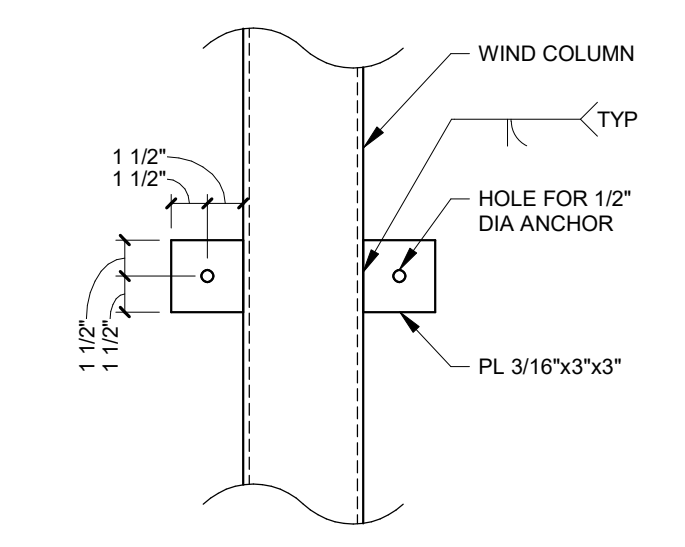


3 WIND COLUMN WALL ANCHOR TAB
1 1/2" = 1'-0"

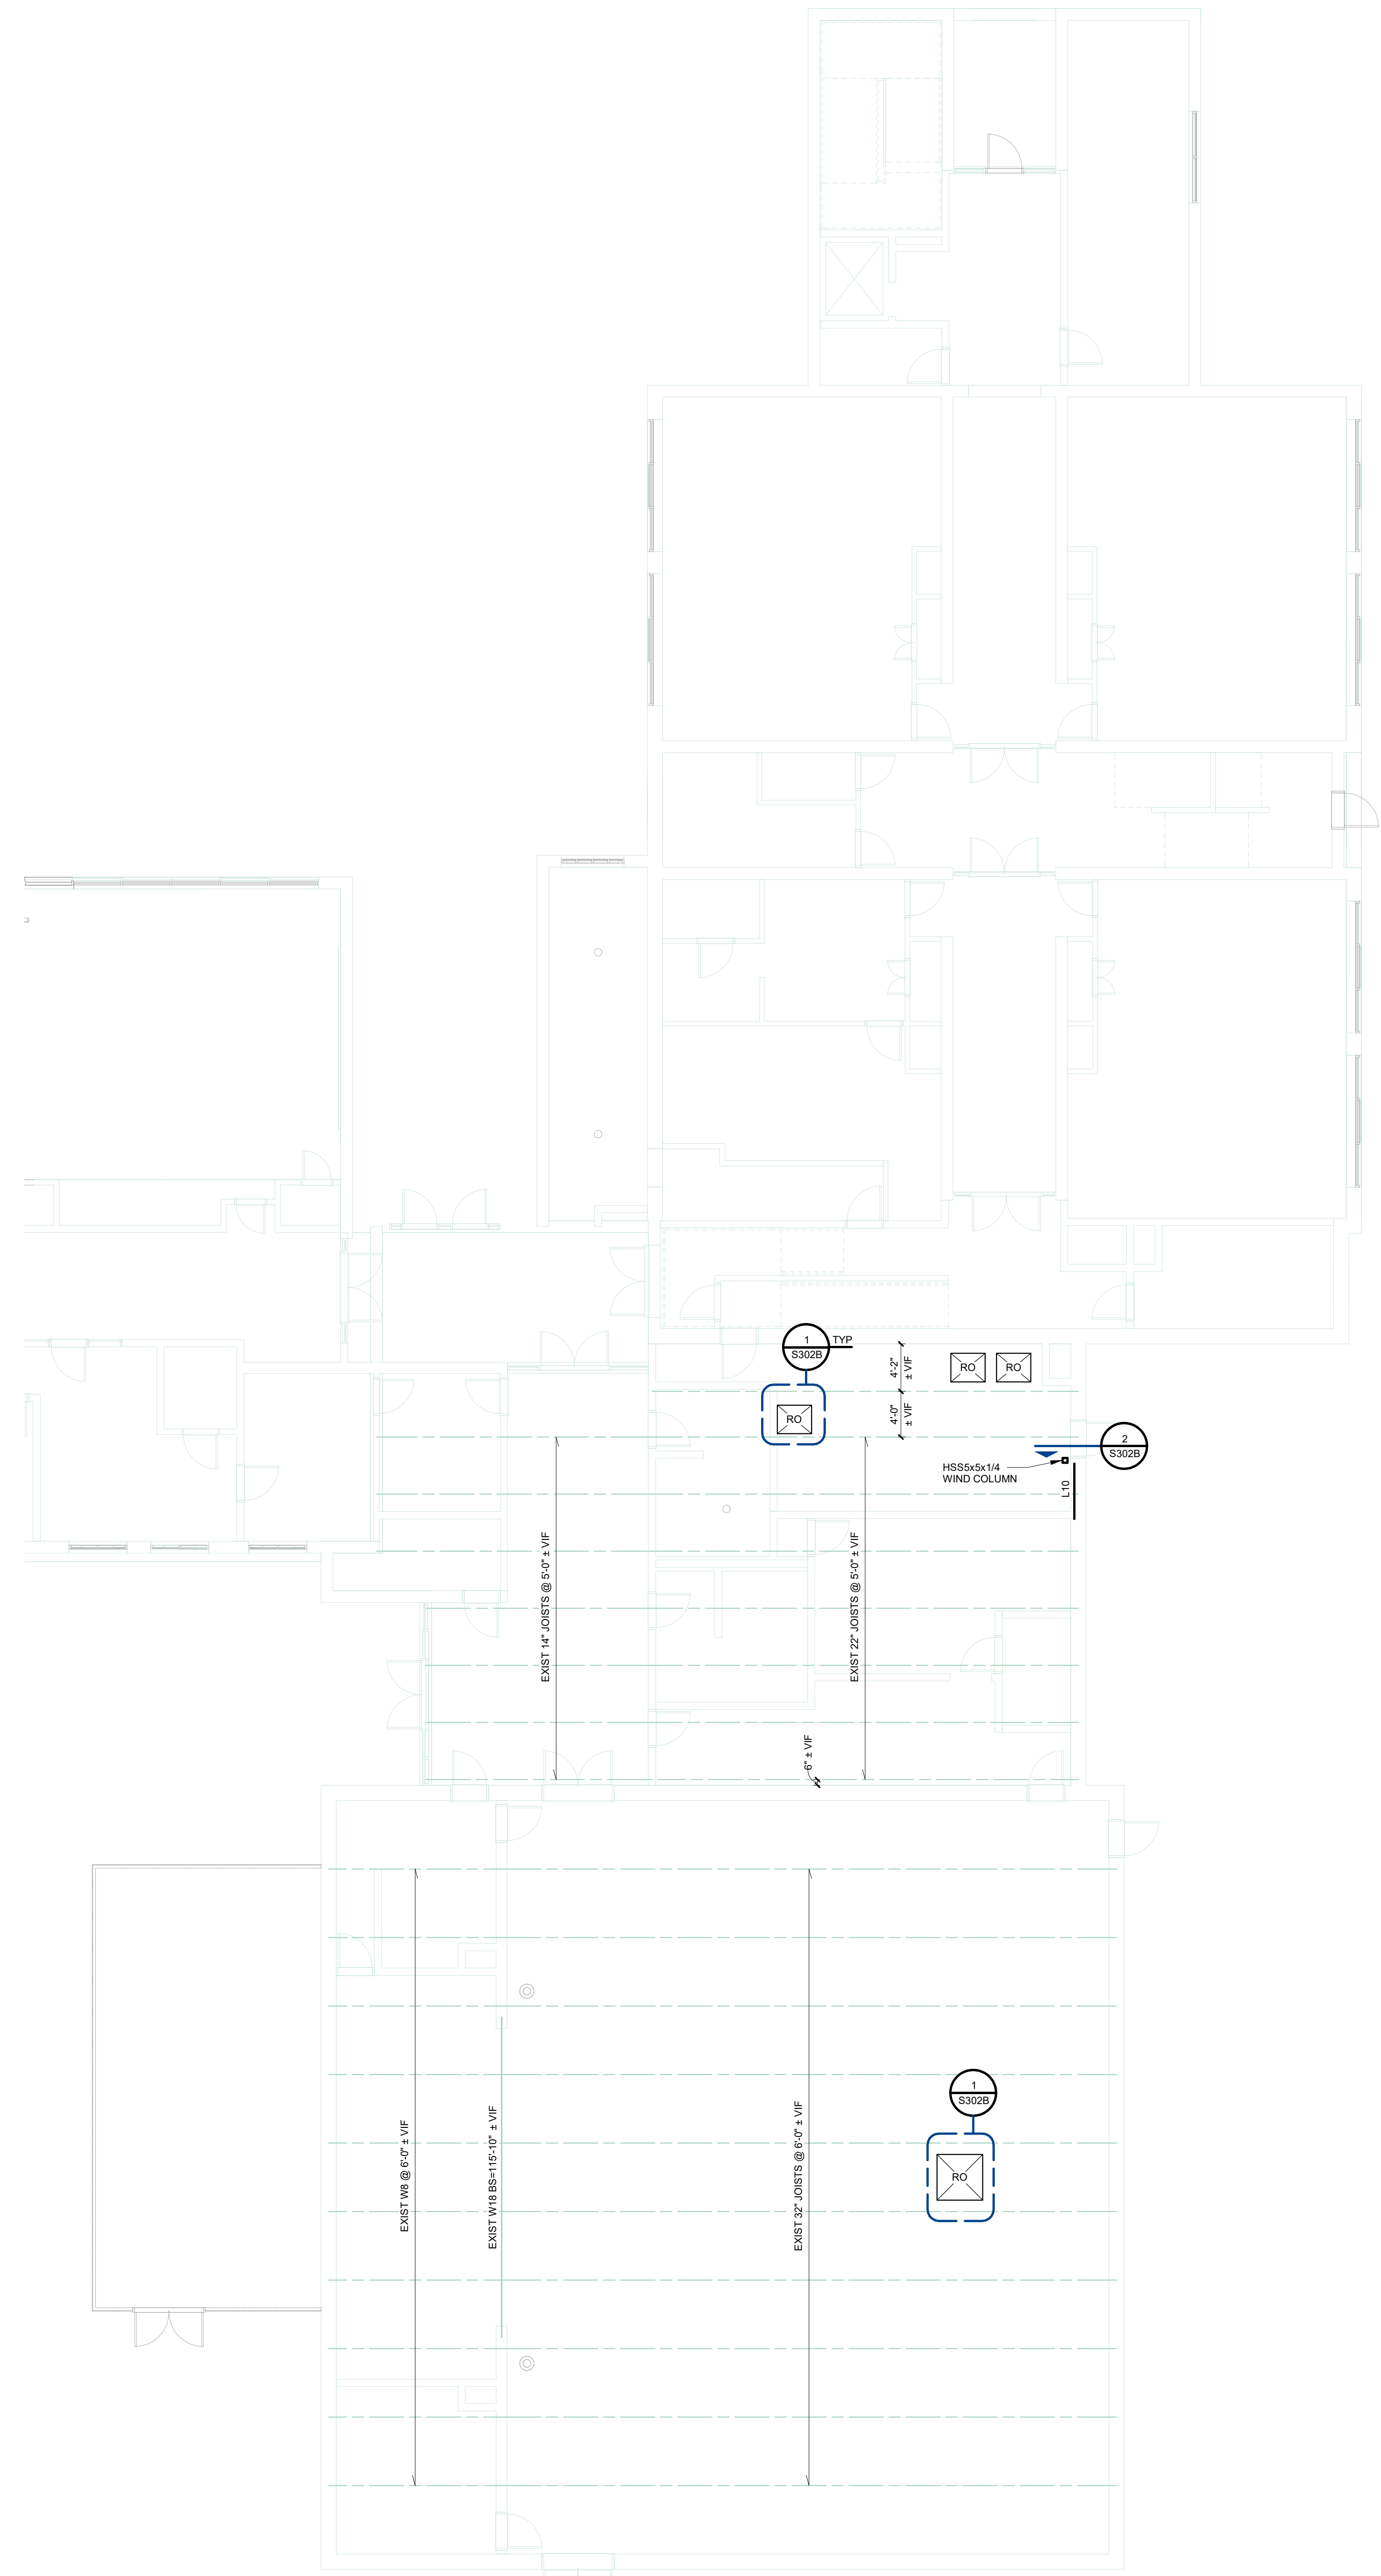

LOW ROOF FRAMING PLAN - UNIT B
SCALE: 1/8" = 1'-0"

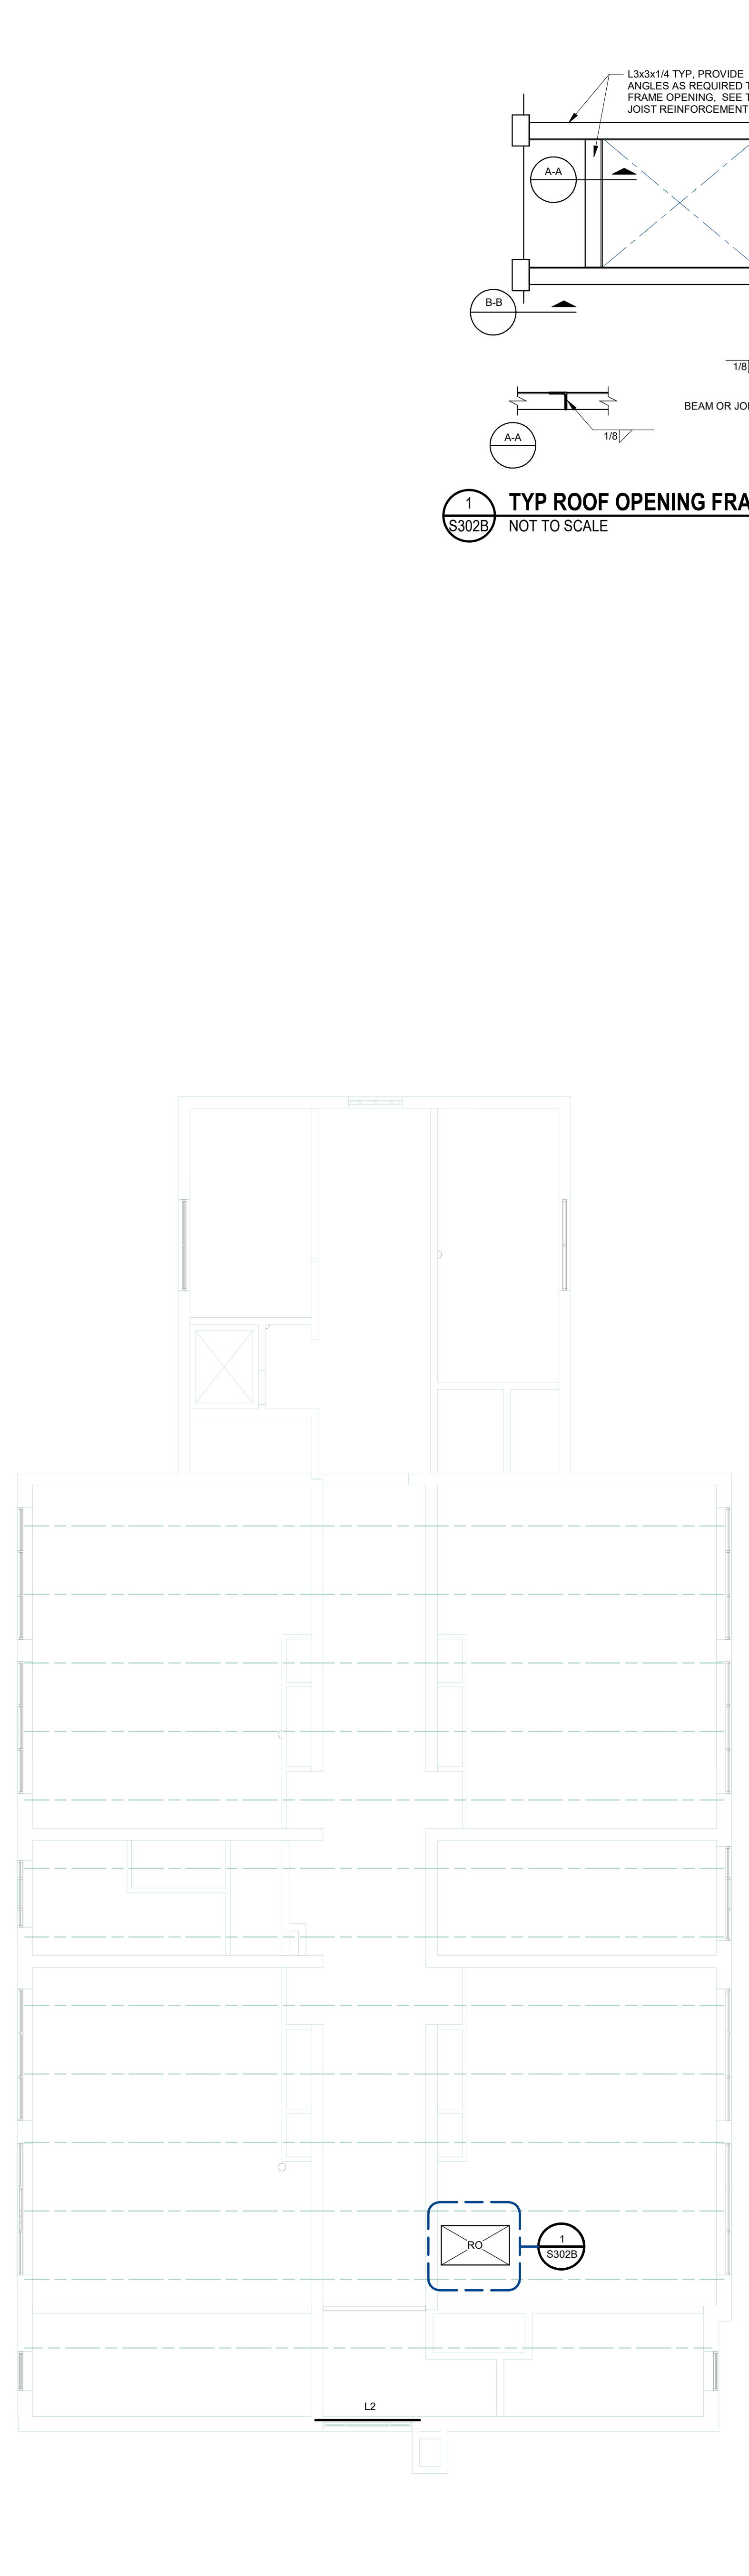




HIGH ROOF FRAMING PLAN - UNIT B
SCALE: 1/8" = 1'-0"

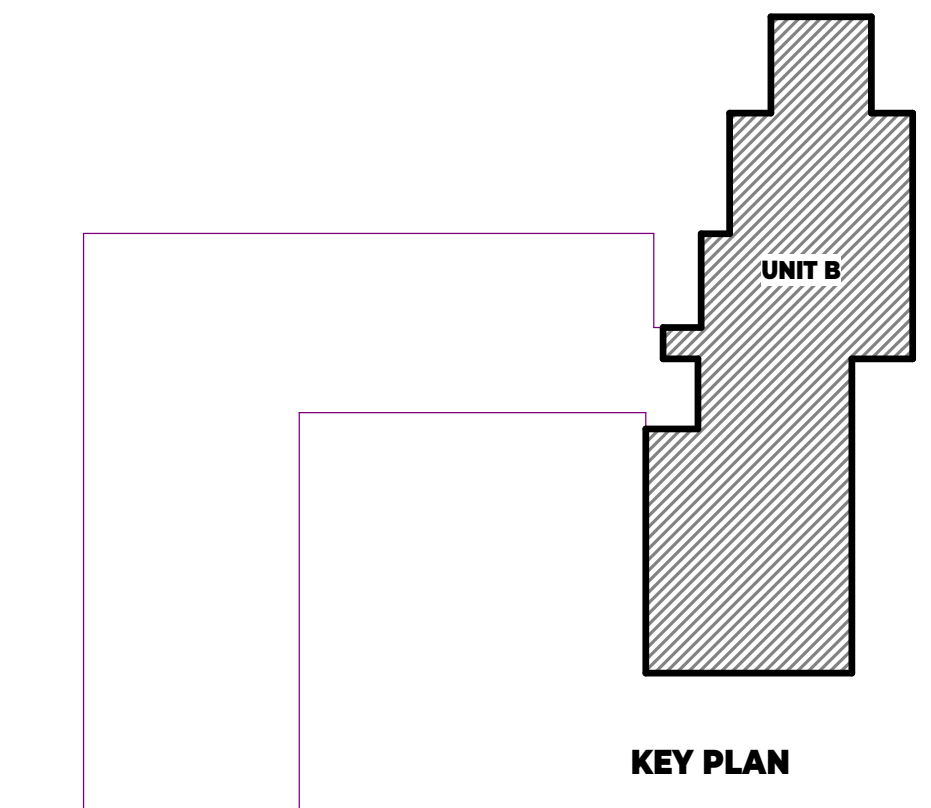

KEY PLAN

- FLOOR PLAN LEGEND**
- ROOM TAG**
 - ROOM NUMBER
 - ROOM NAME
 - EXPOSED CEILING
 - DOOR TAG**
 - DOOR TAG NUMBER
 - CORRESPONDS TO THE ROOM IN WHICH IT IS USED
 - THE DECIMAL NUMBER REFERS TO DIFFERENT DOORS IN THE SAME ROOM
 - WALL TAG**
 - WALL TYPE
 - WALL FIRE RATING

- FLOOR PLAN KEYED NOTES**
- INFILL WALL, MATCH EXISTING.
 - REFER TO INTERIOR DRAWINGS FOR SCOPE OF FINISHES AT CLASSROOM RESTROOMS.
 - LOUVER, COORDINATE WITH VUV LOCATIONS.
 - CLASSROOM EGRESS WINDOW. REFER TO FRAME ELEVATIONS FOR CLEARANCE DIMENSIONS.
 - WALL MOUNTED LADDER TO ROOF WITH ROOF HATCH ABOVE - REFERENCE ROOF PLAN FOR DETAILS.
 - INFILL EXISTING OPENING, MATCH EXISTING. - REFERENCE IMAGE ON SHEET A101B
 - INFILL EXISTING HUV MASONRY LOUVER OPENING WITH 6" CMU FLUSH WITH INTERIOR FACE OF EXISTING CMU WALL WITH SPRAY APPLIED INSULATION IN CAVITY. FURR OUT INTERIOR SIDE WITH HAT CHANNELS AND GYPSUM BOARD FLUSH WITH EXISTING. PROVIDE BLANK-OFF PANEL AT REAR FACE OF EXISTING LOUVER EXISTING. LOUVER TO BE PAINTED TO MATCH WINDOW FRAMING. ENTIRE FACE OF INTERIOR WALL TO BE PAINTED TO MATCH ADJACENT WALLS
 - PAINT ENTIRE WALL WHERE MECHANICAL UNIT IS TO BE REMOVED TO MATCH ADJACENT WALLS, TYP.
 - PAINT EXISTING EIFS TO MATCH ADJACENT STOREFRONT SYSTEM

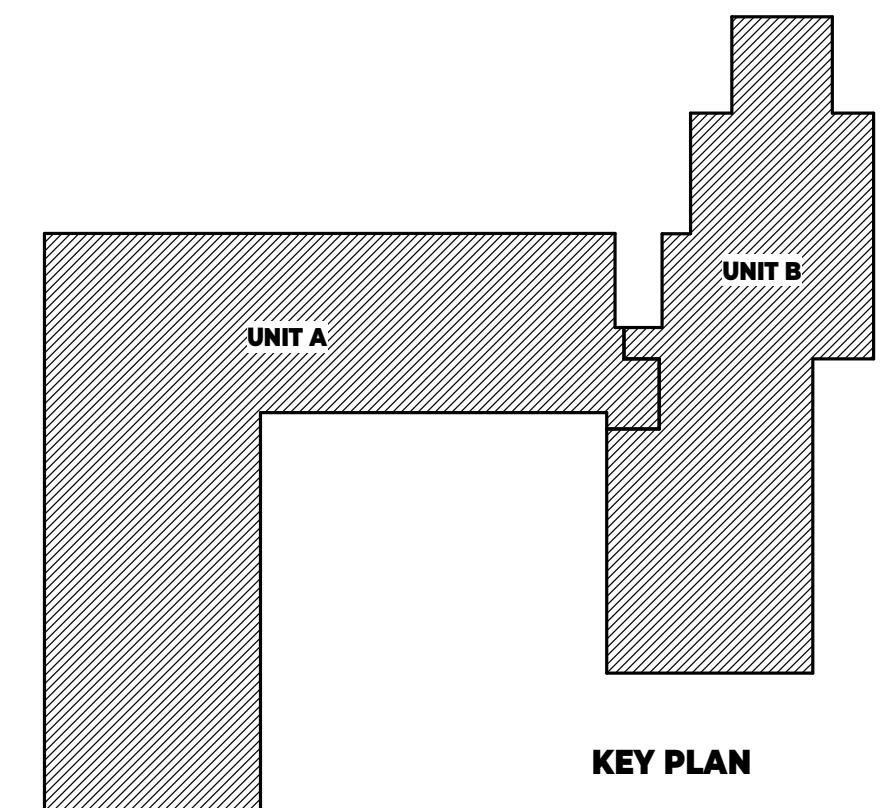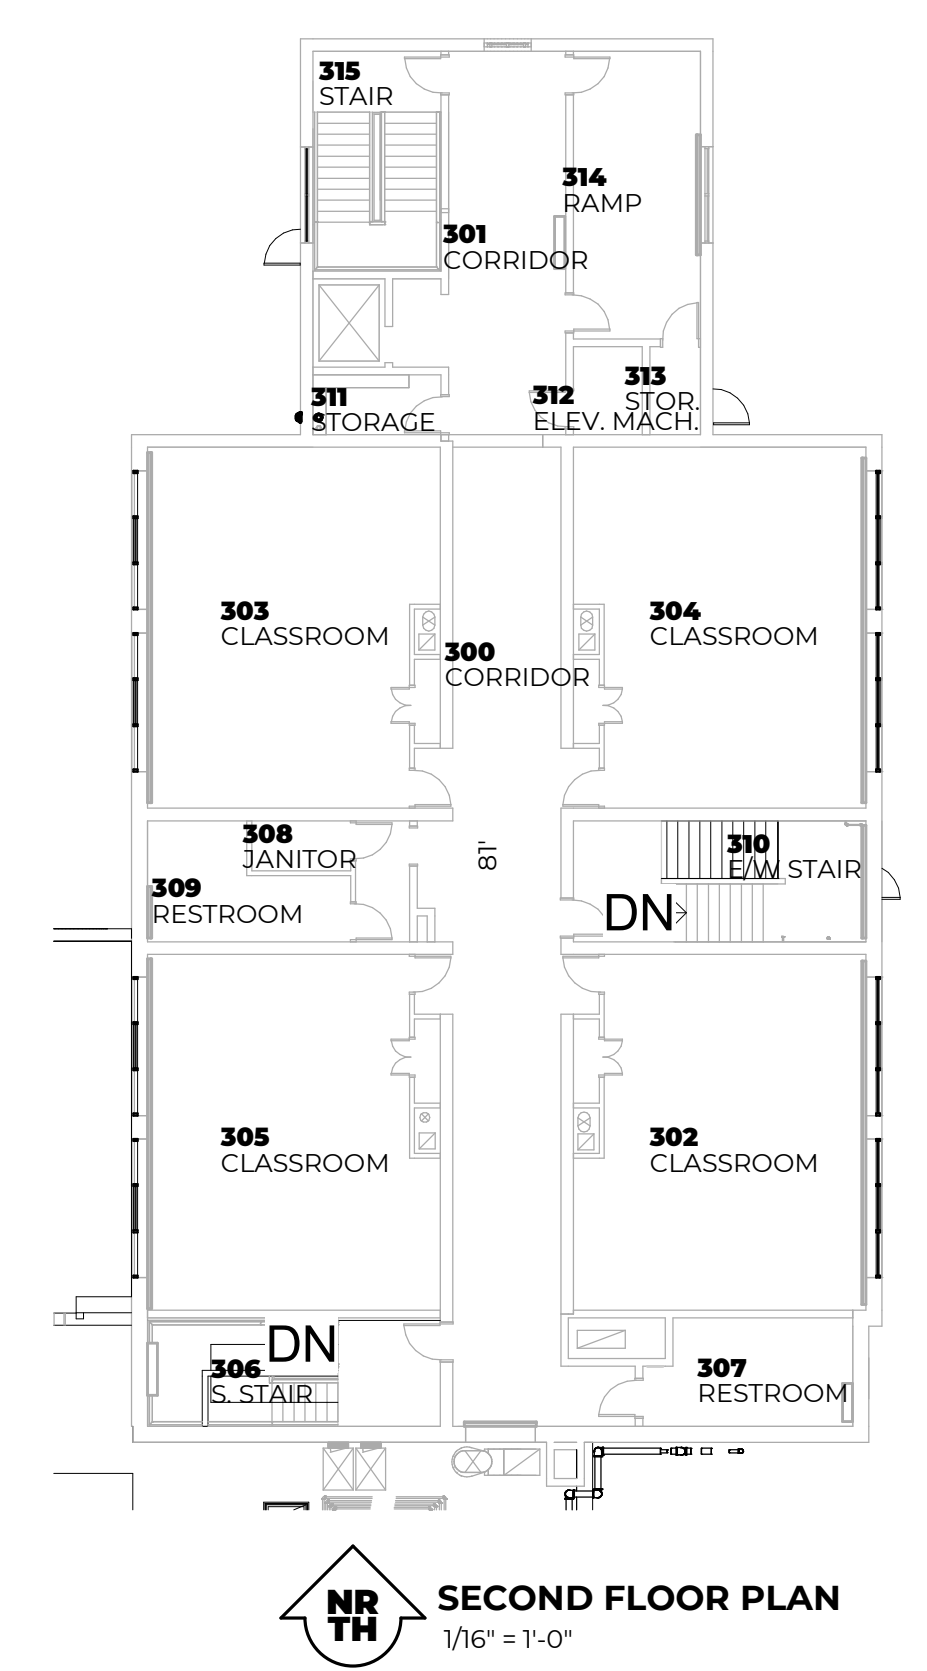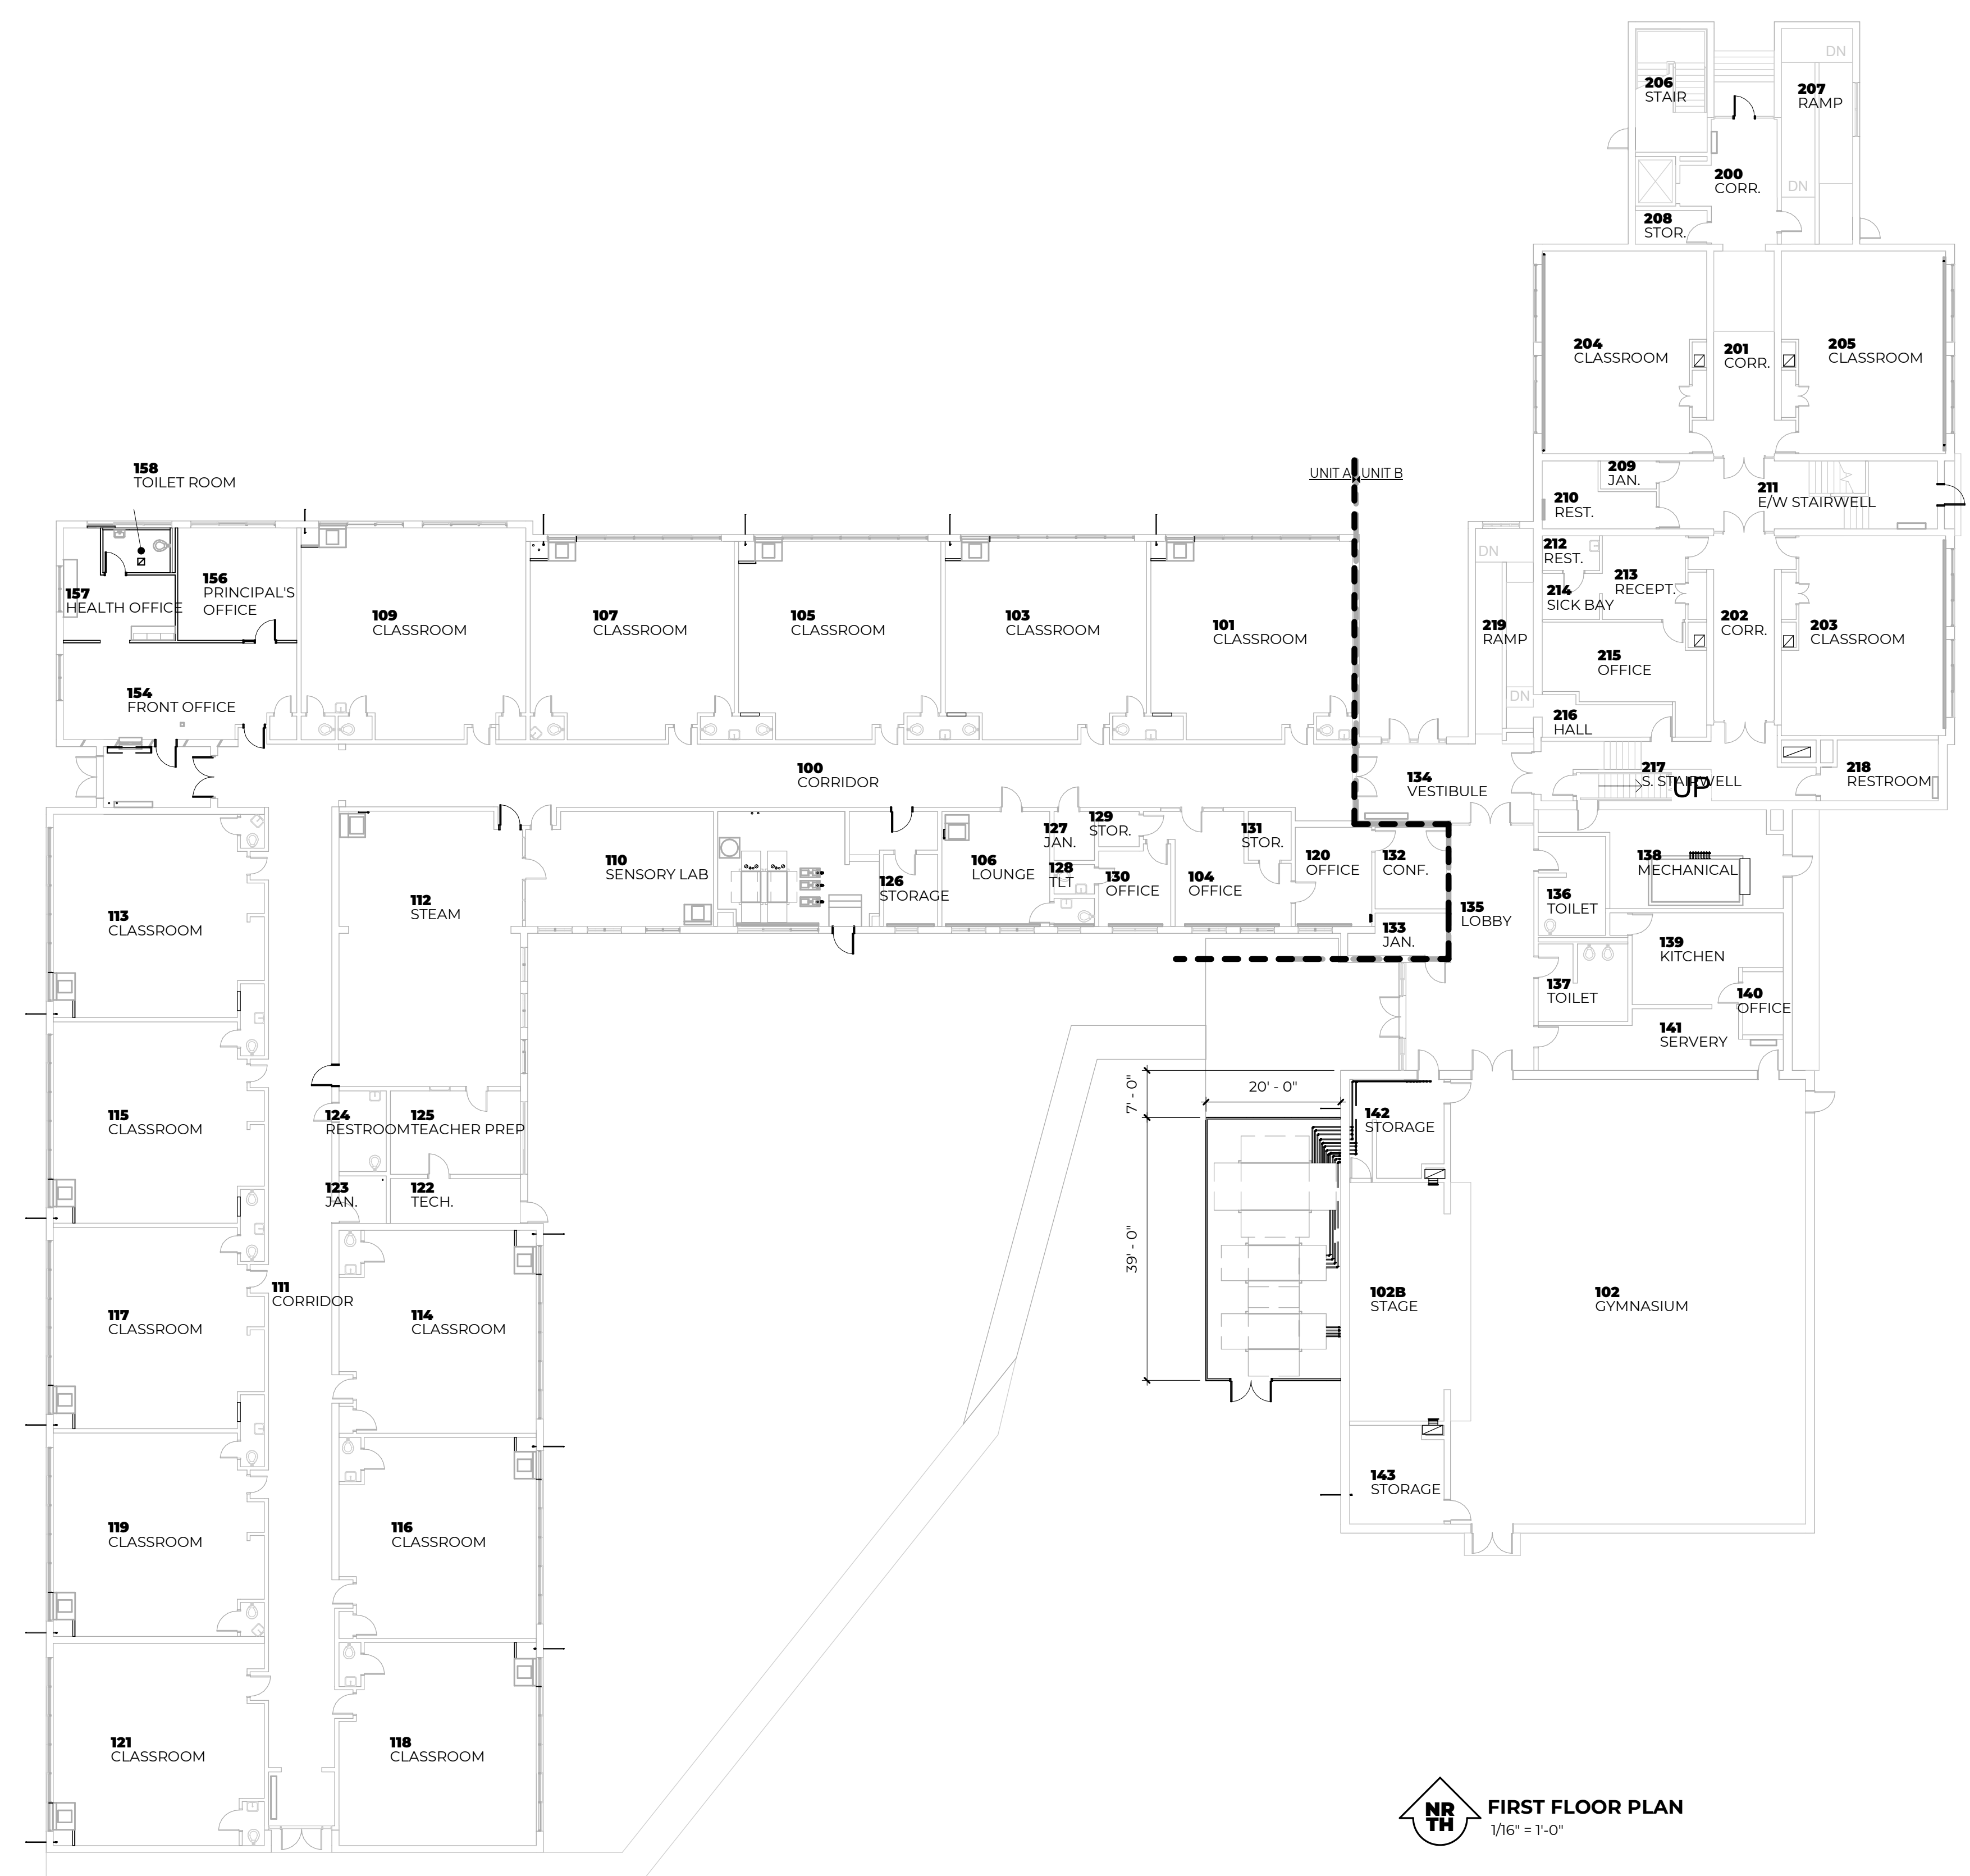


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|--------------|---------------------|------------|
| ISSUE DATE | 03.08.2024 | |
| SHEET NAME | OVERALL FLOOR PLANS | |
| SHEET NUMBER | A100 | |
| | PROJECT NO. 22.114 | |

- LEGEND**
- ROOM TAG
 - ROOM NUMBER
 - ROOM NAME
 - EXPOSED CEILING
 - DOOR TAG
 - DOOR TAG NUMBER CORRESPONDS TO THE ROOM IN WHICH IT IS USED
 - THE DECIMAL NUMBER REFERS TO DIFFERENT DOORS IN THE SAME ROOM
 - WALL TAG
 - WALL TYPE
 - WALL FIRE RATING


- KEYED NOTES**
- INFILL WALL, MATCH EXISTING.
 - REFER TO INTERIOR DRAWINGS FOR SCOPE OF FINISHES AT CLASSROOM RESTROOMS.
 - LOUVER, COORDINATE WITH VUV LOCATIONS.
 - CLASSROOM EGRESS WINDOW, REFER TO FRAME ELEVATIONS FOR CLEARANCE DIMENSIONS.
 - WALL MOUNTED LADDER TO ROOF WITH ROOF HATCH ABOVE - REFERENCE ROOF PLAN FOR DETAILS.
 - INFILL EXISTING OPENING, MATCH EXISTING, REMOVE AND REPLACE RUBBER BASE ON WALL SEGMENT - REFERENCE IMAGE 1 ON SHEET A101B
 - INFILL EXISTING HUV MASONRY LOUVER OPENING WITH 6" CMU FLUSH WITH INTERIOR FACE OF EXISTING CMU WALL WITH SPRAY APPLIED INSULATION IN CAVITY. FURR OUT INTERIOR SIDE WITH HAT CHANNELS AND GYPSUM BOARD FLUSH WITH EXISTING. PROVIDE BLANK-OFF PANEL AT REAR FACE OF EXISTING LOUVER, EXISTING LOUVER TO BE PAINTED TO MATCH WINDOW FRAMING. ENTIRE FACE OF INTERIOR WALL TO BE PAINTED TO MATCH ADJACENT WALLS
 - PAINT ENTIRE WALL WHERE MECHANICAL UNIT IS TO BE REMOVED TO MATCH ADJACENT WALLS, TYP.
 - PAINT EXISTING EIFS TO MATCH ADJACENT STOREFRONT SYSTEM
 - INFILL EXISTING OPENING, MATCH EXISTING, REFERENCE IMAGE 2 ON SHEET A101B

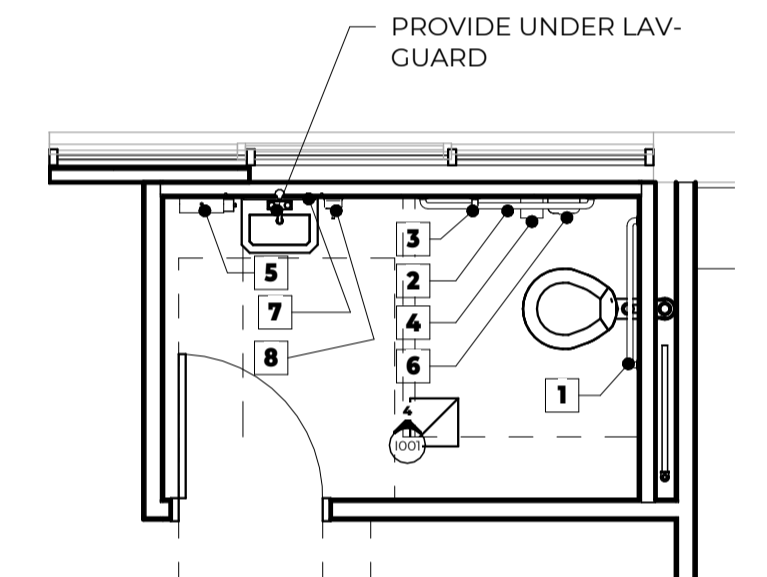


2 ENLARGED RESTROOM PLAN
1/4" = 1'-0"

TOILET ACCESSORIES SCHEDULE

| MARK | PRODUCT | RESPONSIBILITY | | | |
|------|-------------------------|----------------|----|----|----|
| | | CI | CP | OI | OP |
| 1 | 36" GRAB BAR | x | x | | |
| 2 | 42" GRAB BAR | x | x | | |
| 3 | 18" GRAB BAR | x | x | | |
| 4 | Toilet Tissue Dispenser | x | | | x |
| 5 | Towel Dispenser | x | | | x |
| 6 | NAPKIN DISPOSAL | x | | | x |
| 7 | MIRROR | x | x | | |
| 8 | Soap Dispenser | x | | | x |

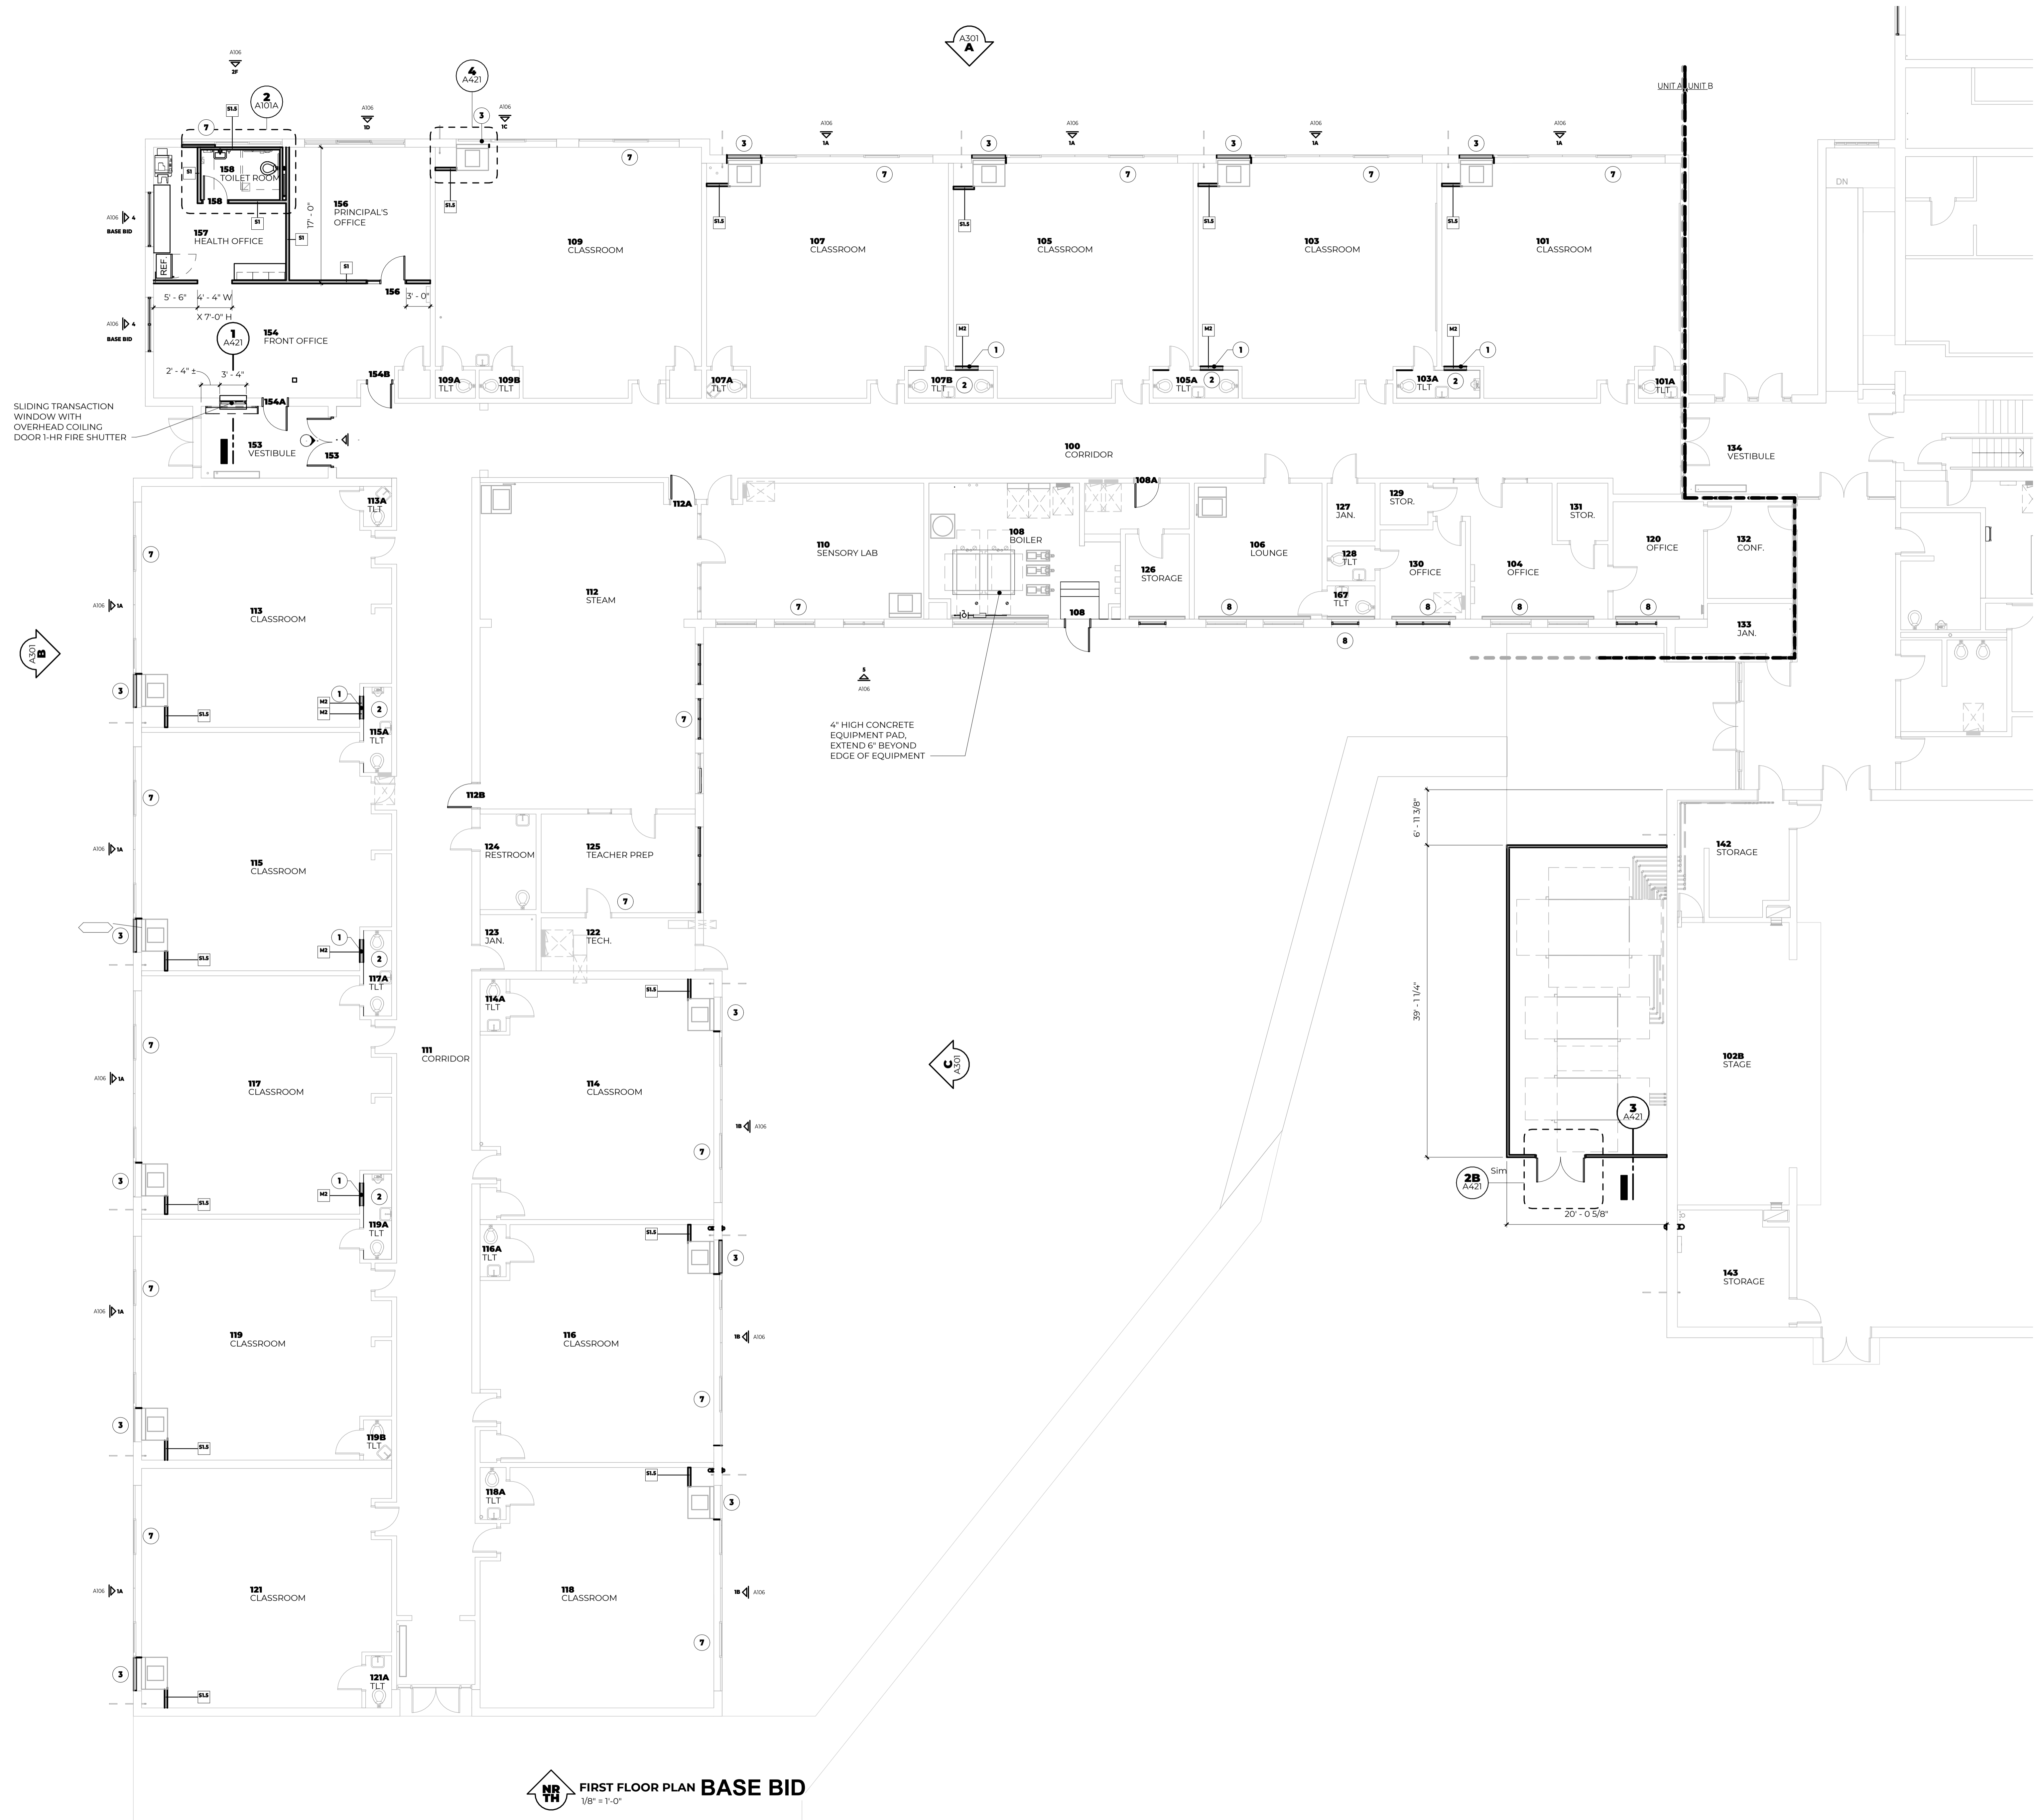

NR TH FIRST FLOOR PLAN BASE BID
1/8" = 1'-0"

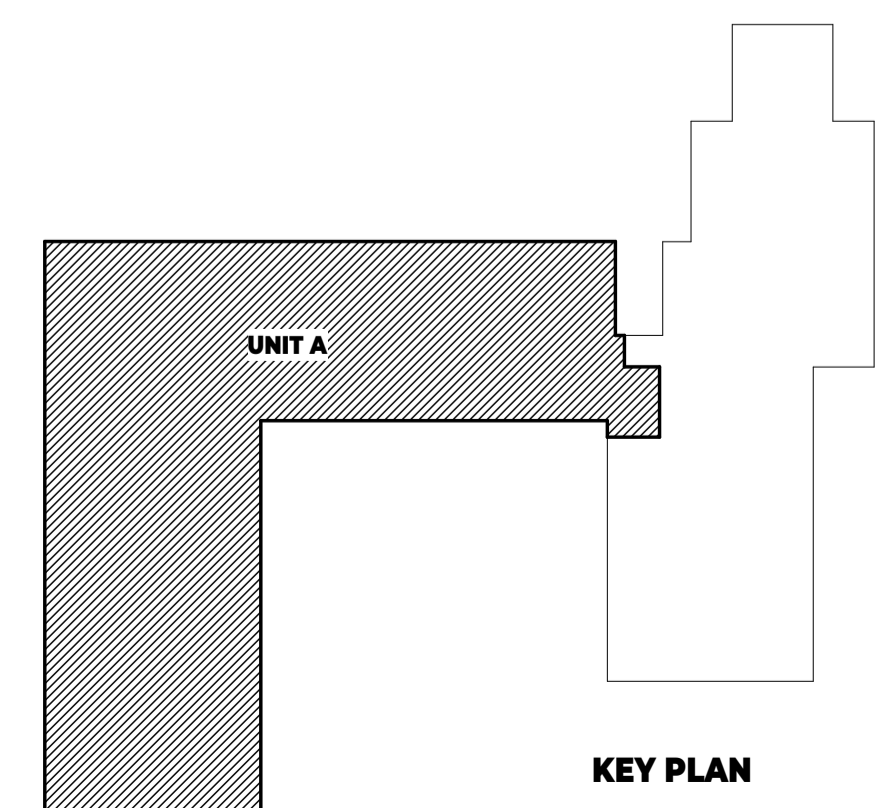

KEY PLAN

MPS GLENSIDE
MUSKEGON PUBLIC SCHOOLS
1213 W Hackley Ave, Muskegon, MI 49441

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| | 03.08.2024 | |

ISSUE DATE

SHEET NAME
FIRST FLOOR PLAN - UNIT A

SHEET NUMBER
A101A

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LEGEND

ROOM TAG
ROOM NUMBER
ROOM NAME
EXPOSED CEILING

DOOR TAG
DOOR TAG NUMBER
CORRESPONDS TO THE ROOM IN WHICH IT IS USED
THE DECIMAL NUMBER REFERS TO DIFFERENT DOORS IN THE SAME ROOM

WALL TAG
WALL TYPE
WALL FIRE RATING

NOTE

FLOOR PLAN KEYED NOTES

- INFILL WALL, MATCH EXISTING.
- REFER TO INTERIOR DRAWINGS FOR SCOPE OF FINISHES AT CLASSROOM RESTROOMS.
- LOUVER, COORDINATE WITH VUV LOCATIONS.
- CLASSROOM EGRESS WINDOW. REFER TO FRAME ELEVATIONS FOR CLEARANCE DIMENSIONS.
- WALL MOUNTED LADDER TO ROOF WITH ROOF HATCH ABOVE - REFERENCE ROOF PLAN FOR DETAILS
- INFILL EXISTING OPENING, MATCH EXISTING. REMOVE AND REPLACE RUBBER BASE ON WALL SEGMENT - REFERENCE IMAGE 1 ON SHEET A101B
- INFILL EXISTING HUV MASONRY LOUVER OPENING WITH 6" CMU FLUSH WITH INTERIOR FACE OF EXISTING CMU WALL WITH SPRAY APPLIED INSULATION IN CAVITY. FLURR OUT INTERIOR SIDE WITH HAT CHANNELS AND GYPSUM BOARD FLUSH WITH EXISTING. PROVIDE BLANK-OFF PANEL AT REAR FACE OF EXISTING LOUVER. EXISTING LOUVER TO BE PAINTED TO MATCH WINDOW FRAMING. ENTIRE FACE OF INTERIOR WALL TO BE PAINTED TO MATCH ADJACENT WALLS
- PAINT ENTIRE WALL WHERE MECHANICAL UNIT IS TO BE REMOVED TO MATCH ADJACENT WALLS, TYP.
- PAINT EXISTING EIFS TO MATCH ADJACENT STOREFRONT SYSTEM
- INFILL EXISTING OPENING, MATCH EXISTING. REFERENCE IMAGE 2 ON SHEET A101B

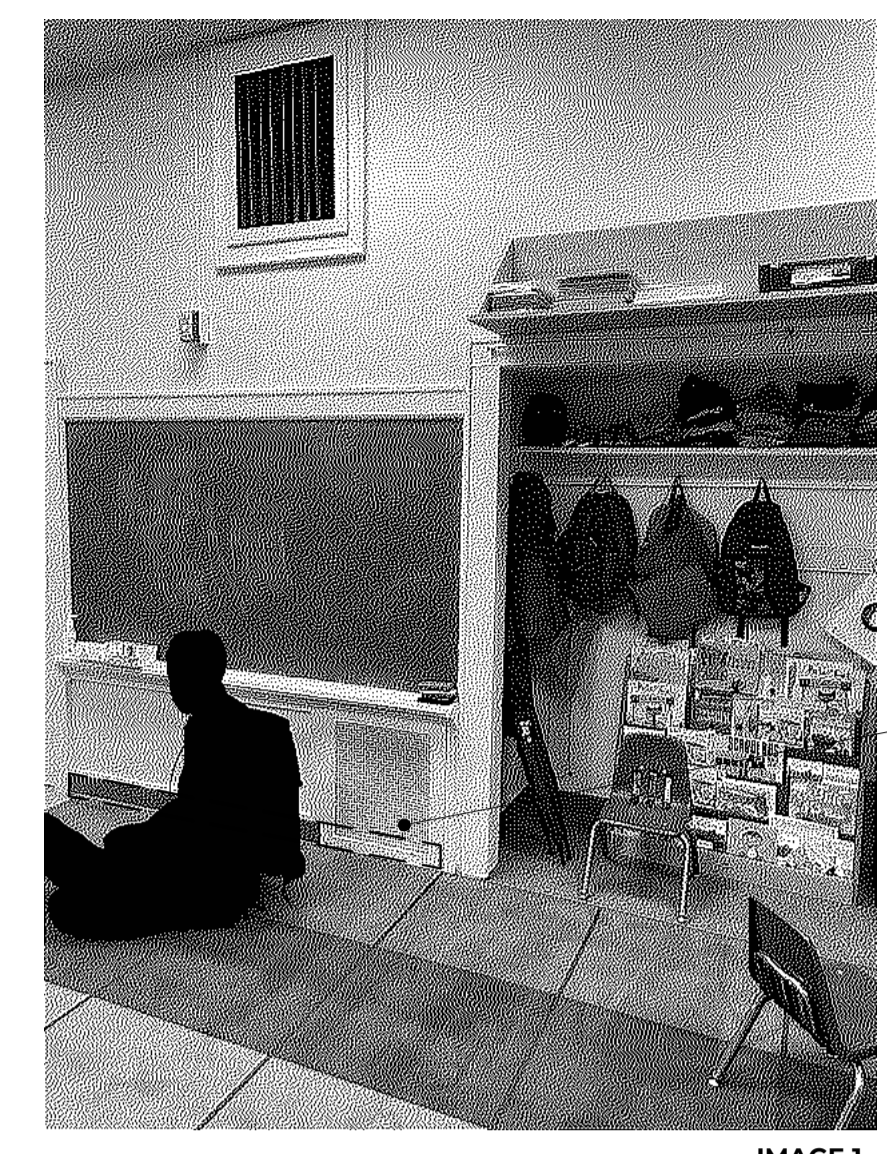


IMAGE 1




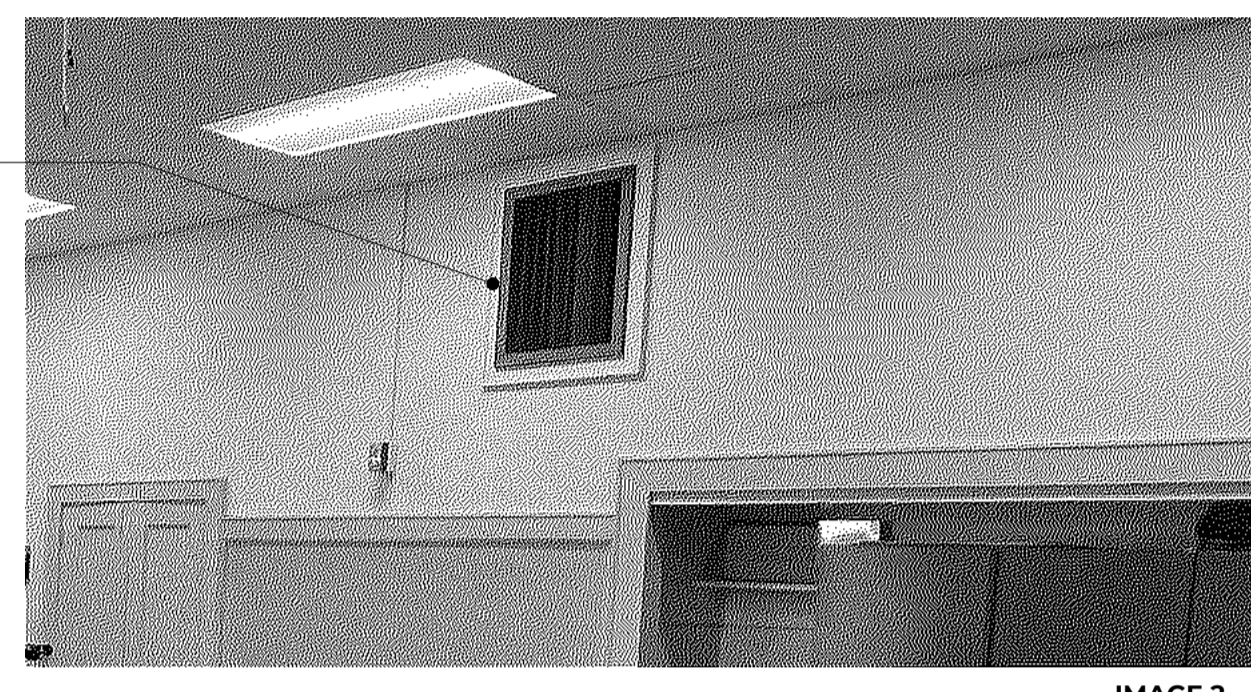


IMAGE 2


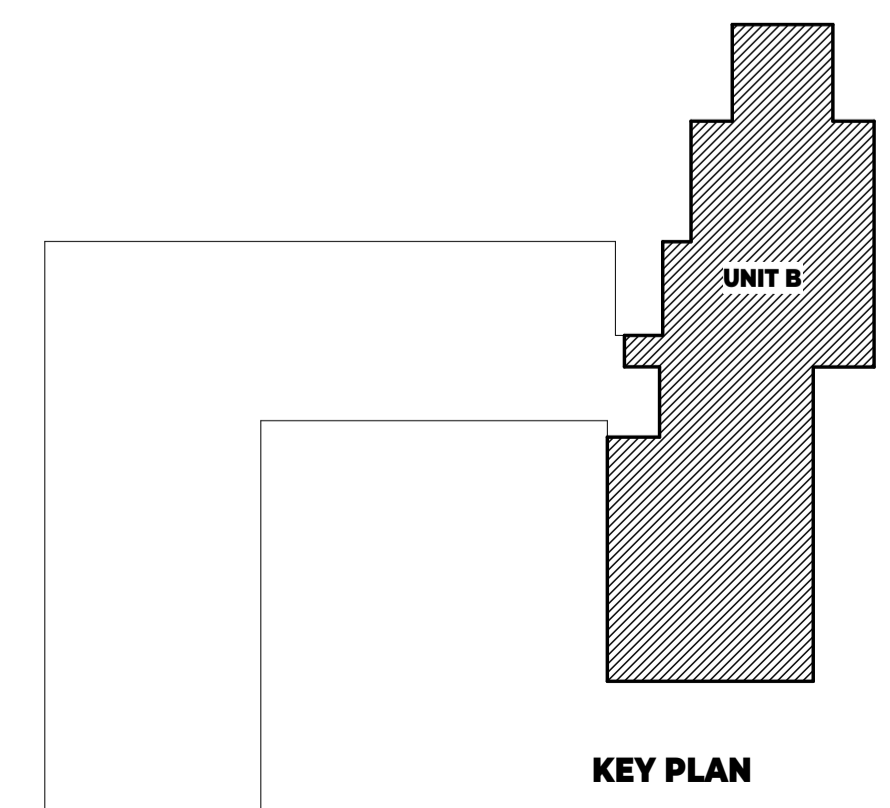
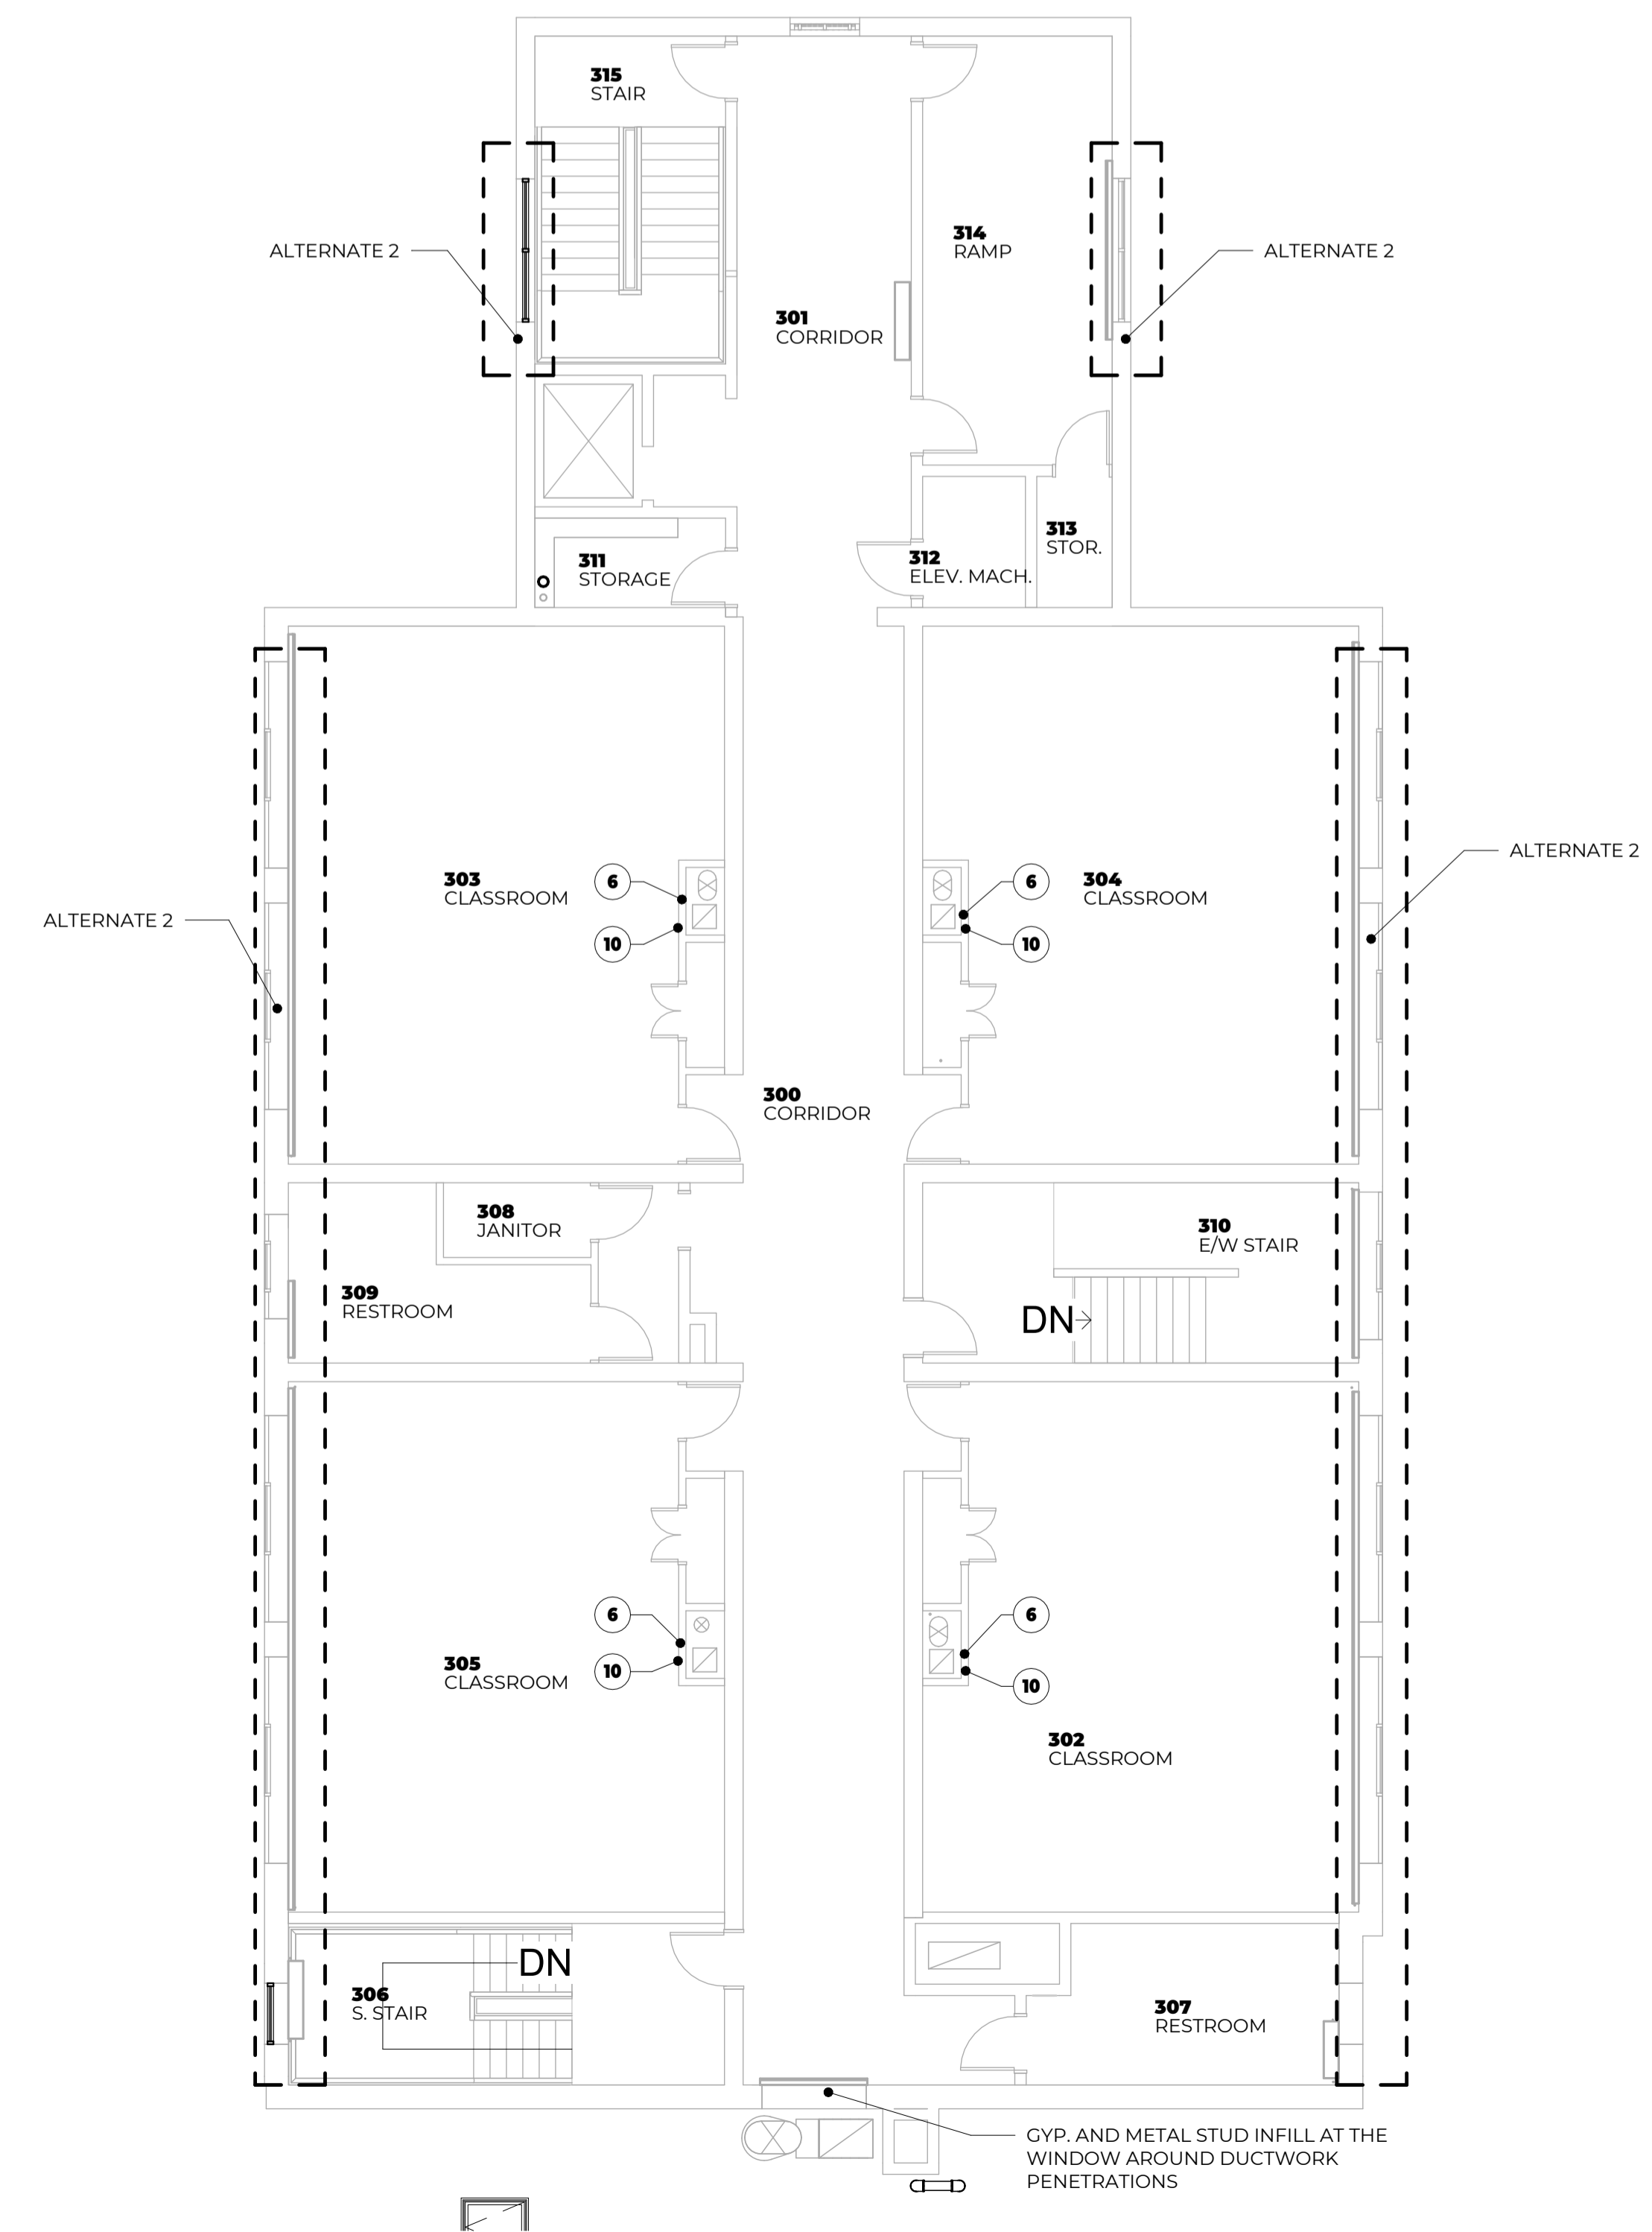
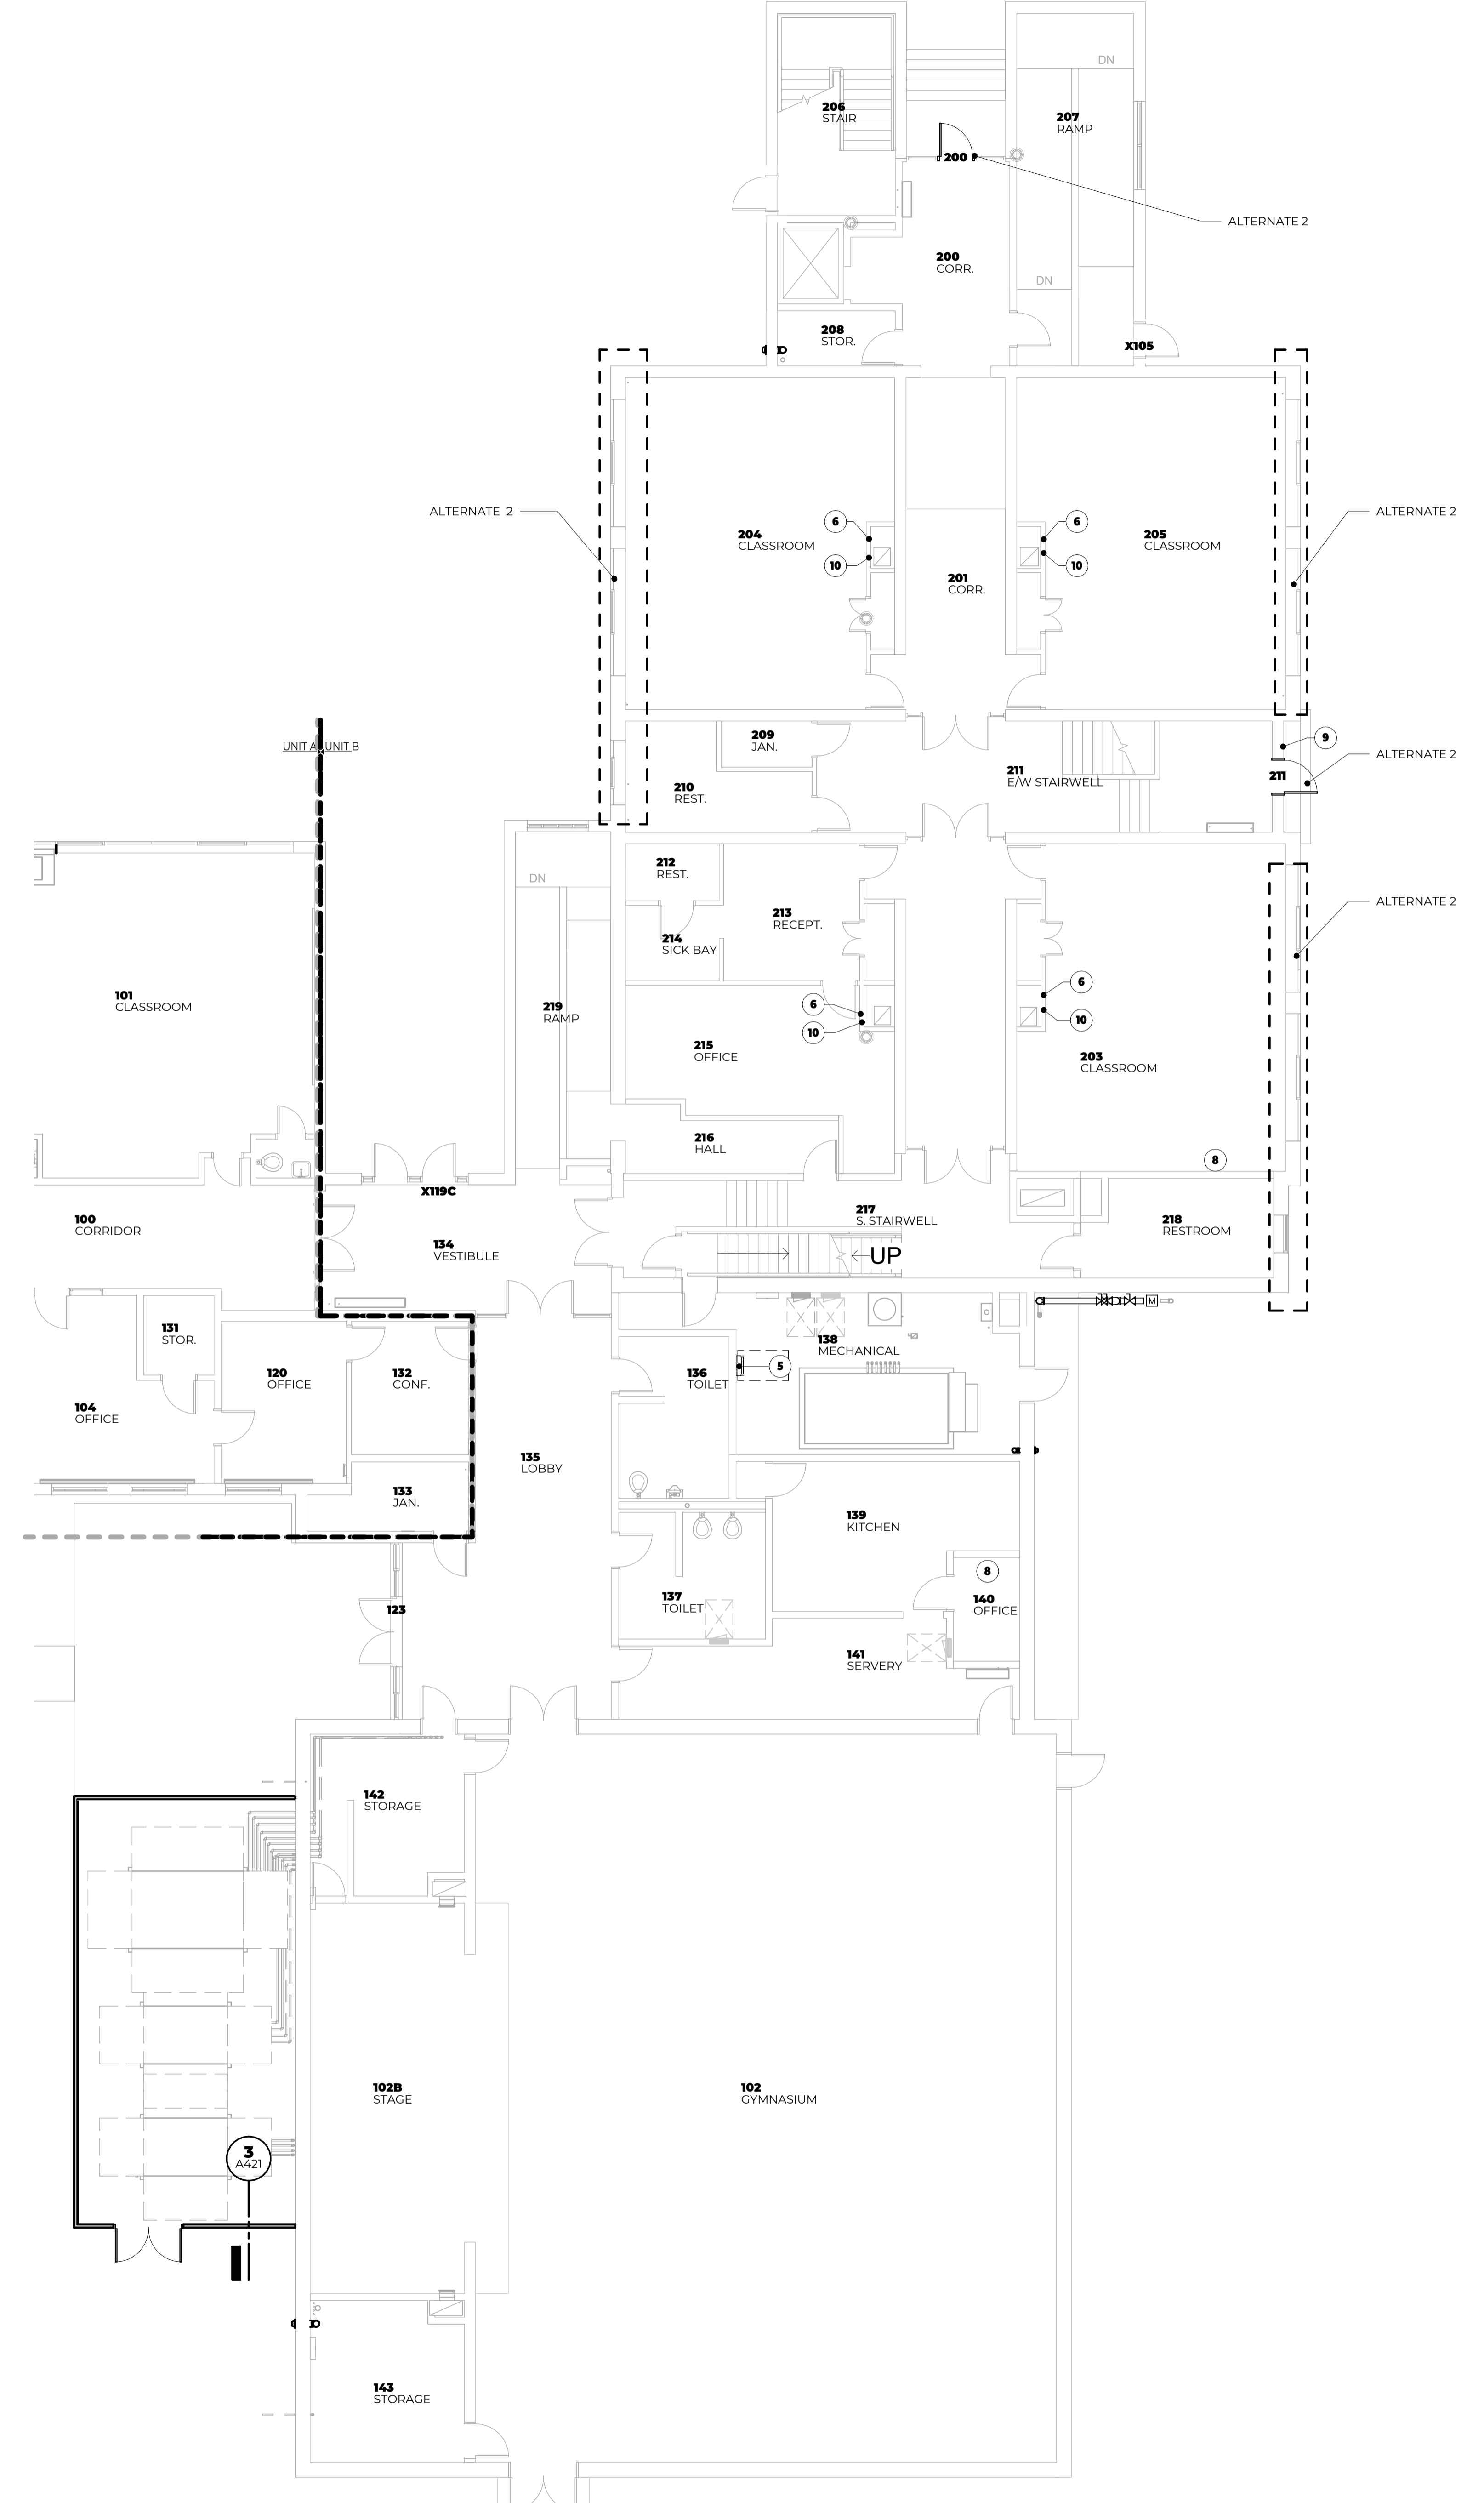


NR TH FIRST FLOOR PLAN
1/8" = 1'-0"

NR TH SECOND FLOOR PLAN
1/8" = 1'-0"


KEY PLAN

ROOF PLAN LEGEND

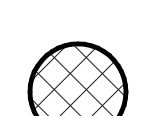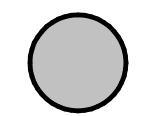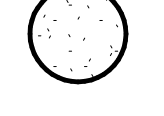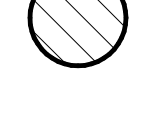
-  60 MIL, FULLY ADHERED, STANDARD EPDM ROOF MEMBRANE ON TWO LAYERS OF 2" POLYISOCYANURATE WITH TAPERED ROOF INSULATION.
 -  SAME AS SYSTEM ABOVE WITH TAPERED INSULATION.
 -  60 MIL, FULLY ADHERED, STANDARD EPDM ROOF MEMBRANE ON TWO LAYERS OF 2" POLYISOCYANURATE.
 -  VAPOR BARRIER AND 60 MIL, FULLY ADHERED, STANDARD EPDM ROOF MEMBRANE ON TWO LAYERS OF 2" POLYISOCYANURATE WITH TAPERED ROOF INSULATION.
- R.D. ROOF DRAIN - SEE PLUMBING DRAWINGS
 O.D. OVERFLOW DRAIN - SEE PLUMBING DRAWINGS
 ← ROOF SLOPE DUE TO TAPERED INSULATION OR SLOPED STRUCTURE - REFER TO STRUCTURAL DRAWINGS

NOTES


1. TYPICAL ROOF SLOPE 1/4" / 1'-0" UNLESS NOTED OTHERWISE.
2. PROVIDE ROOFING MANUFACTURER'S STANDARD ROOFING TERMINATION DETAILS AT ALL PARAPETS, PRE-MANUFACTURED ROOF EDGE SYSTEMS, CURBS, PIPE PENETRATIONS, ETC.
3. PROVIDE CRICKETS AS REQUIRED AT ALL MECHANICAL UNITS, VENTS, ETC. TO MAINTAIN POSITIVE SLOPE OF 1/4" / 1'-0" MINIMUM.
4. REPLACE EXISTING EDGE METAL AND METAL COPING WITH CONTINUOUS PREFINISHED METAL PROFILES TO MATCH EXISTING WITH CONSISTANT FINISH TO MATCH STOREFRONT FINISH.

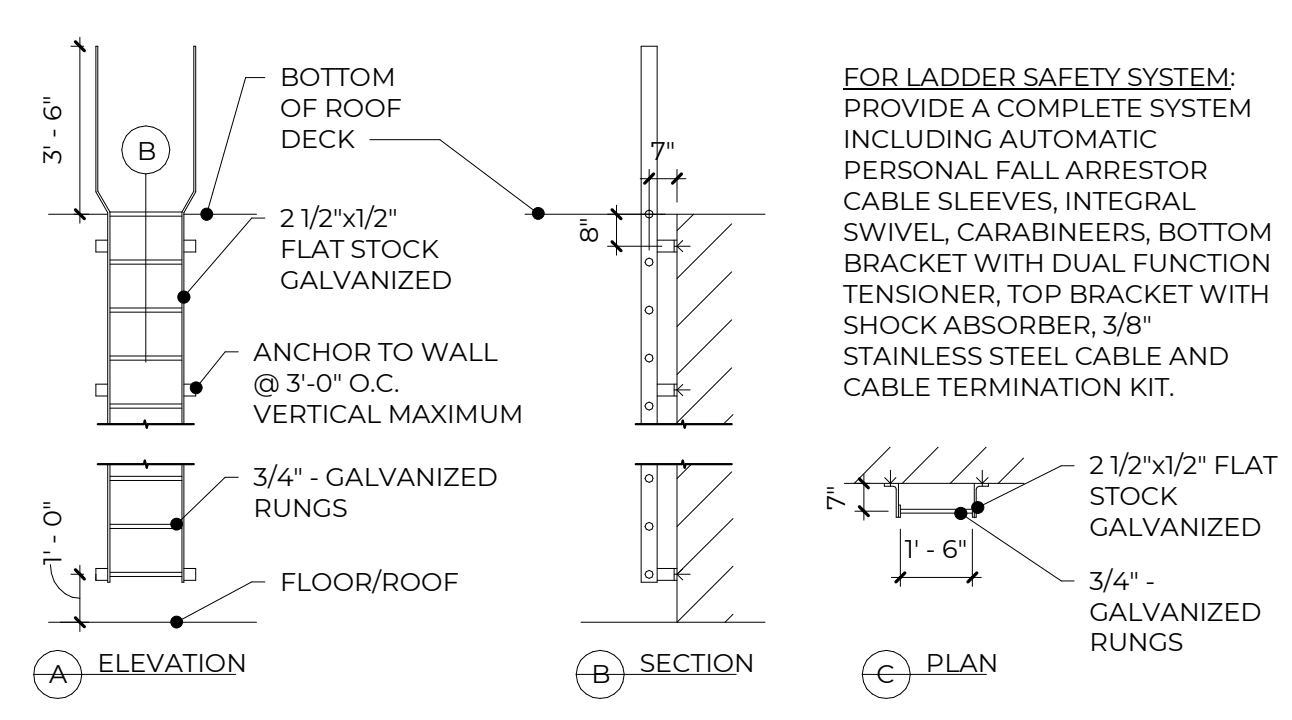


3 ROOF LADDER DETAIL WITH EXTENDED SIDE RAIL
1/4" = 1'-0"

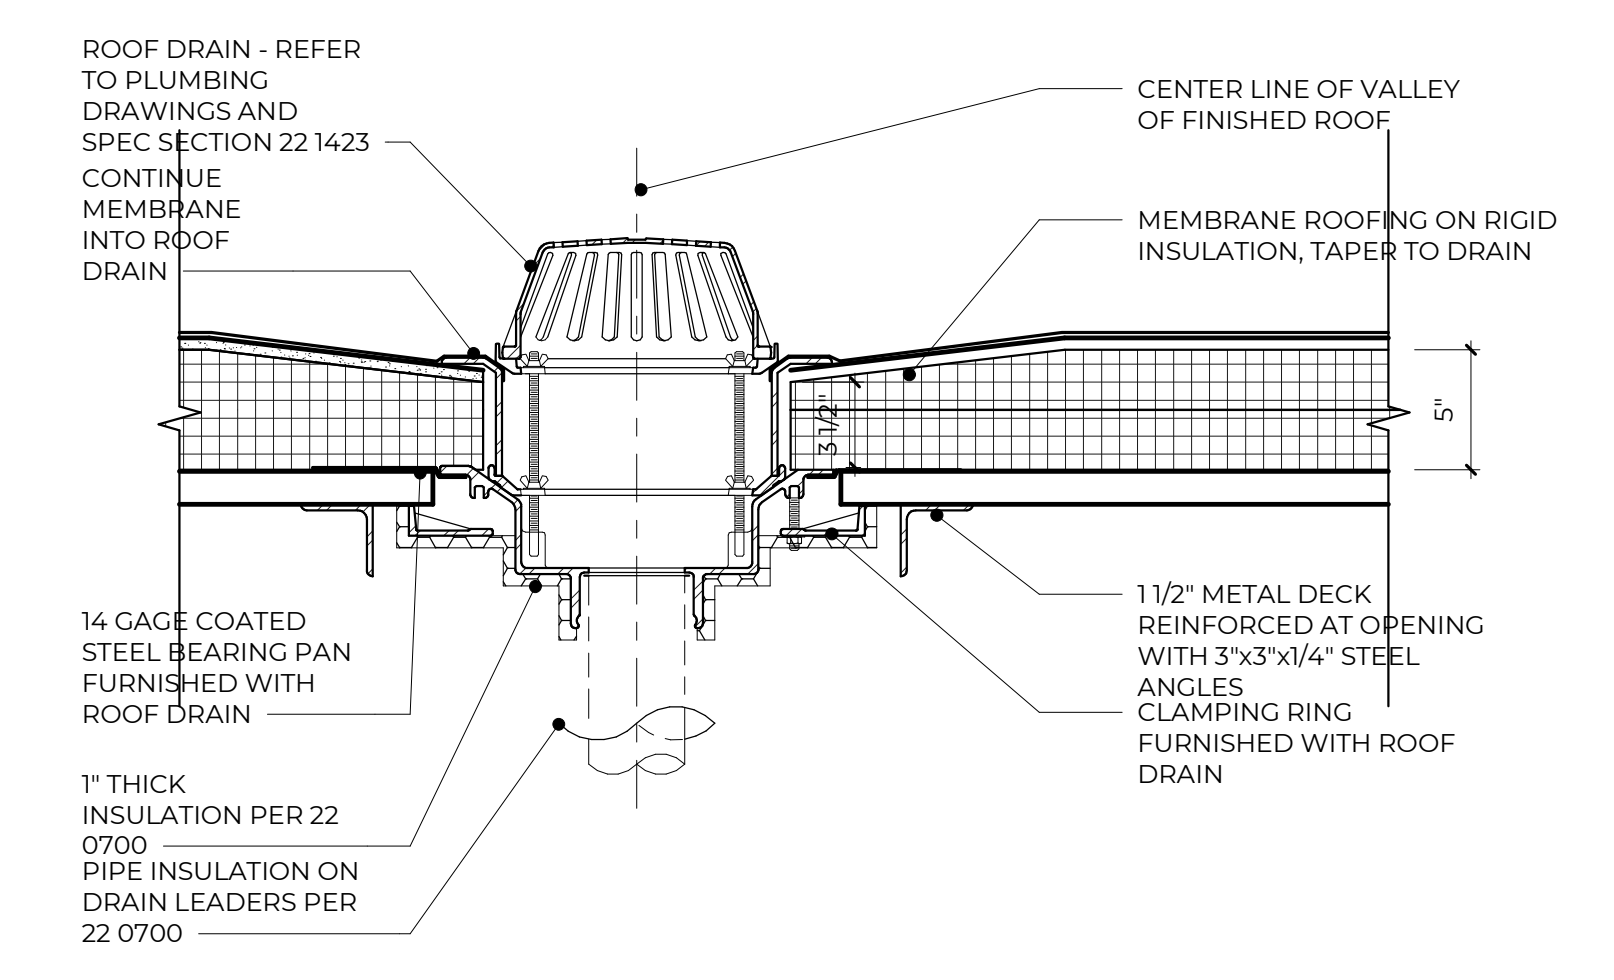


2 ROOF DRAIN DETAIL
1 1/2" = 1'-0"

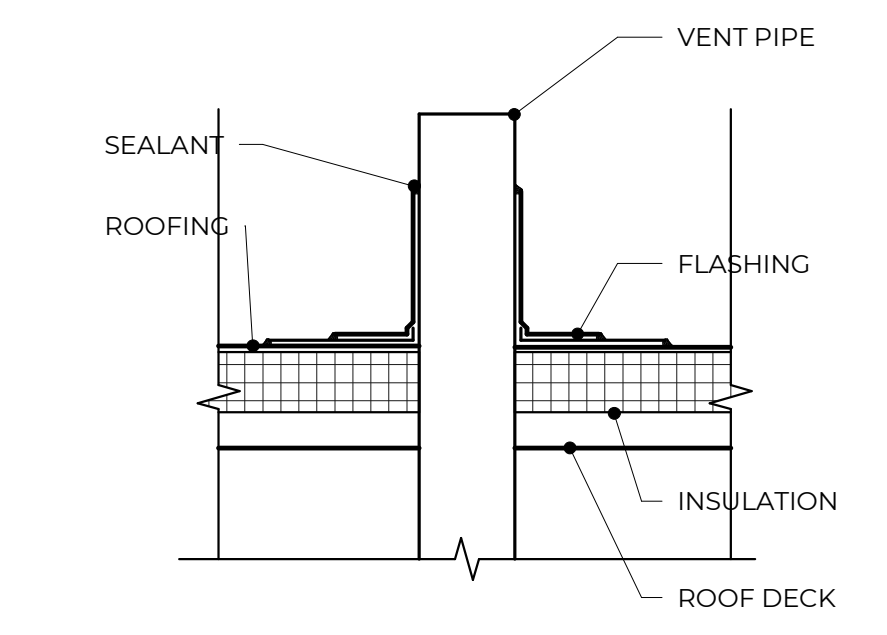


1 TYPICAL ROOF PENETRATION
1 1/2" = 1'-0"

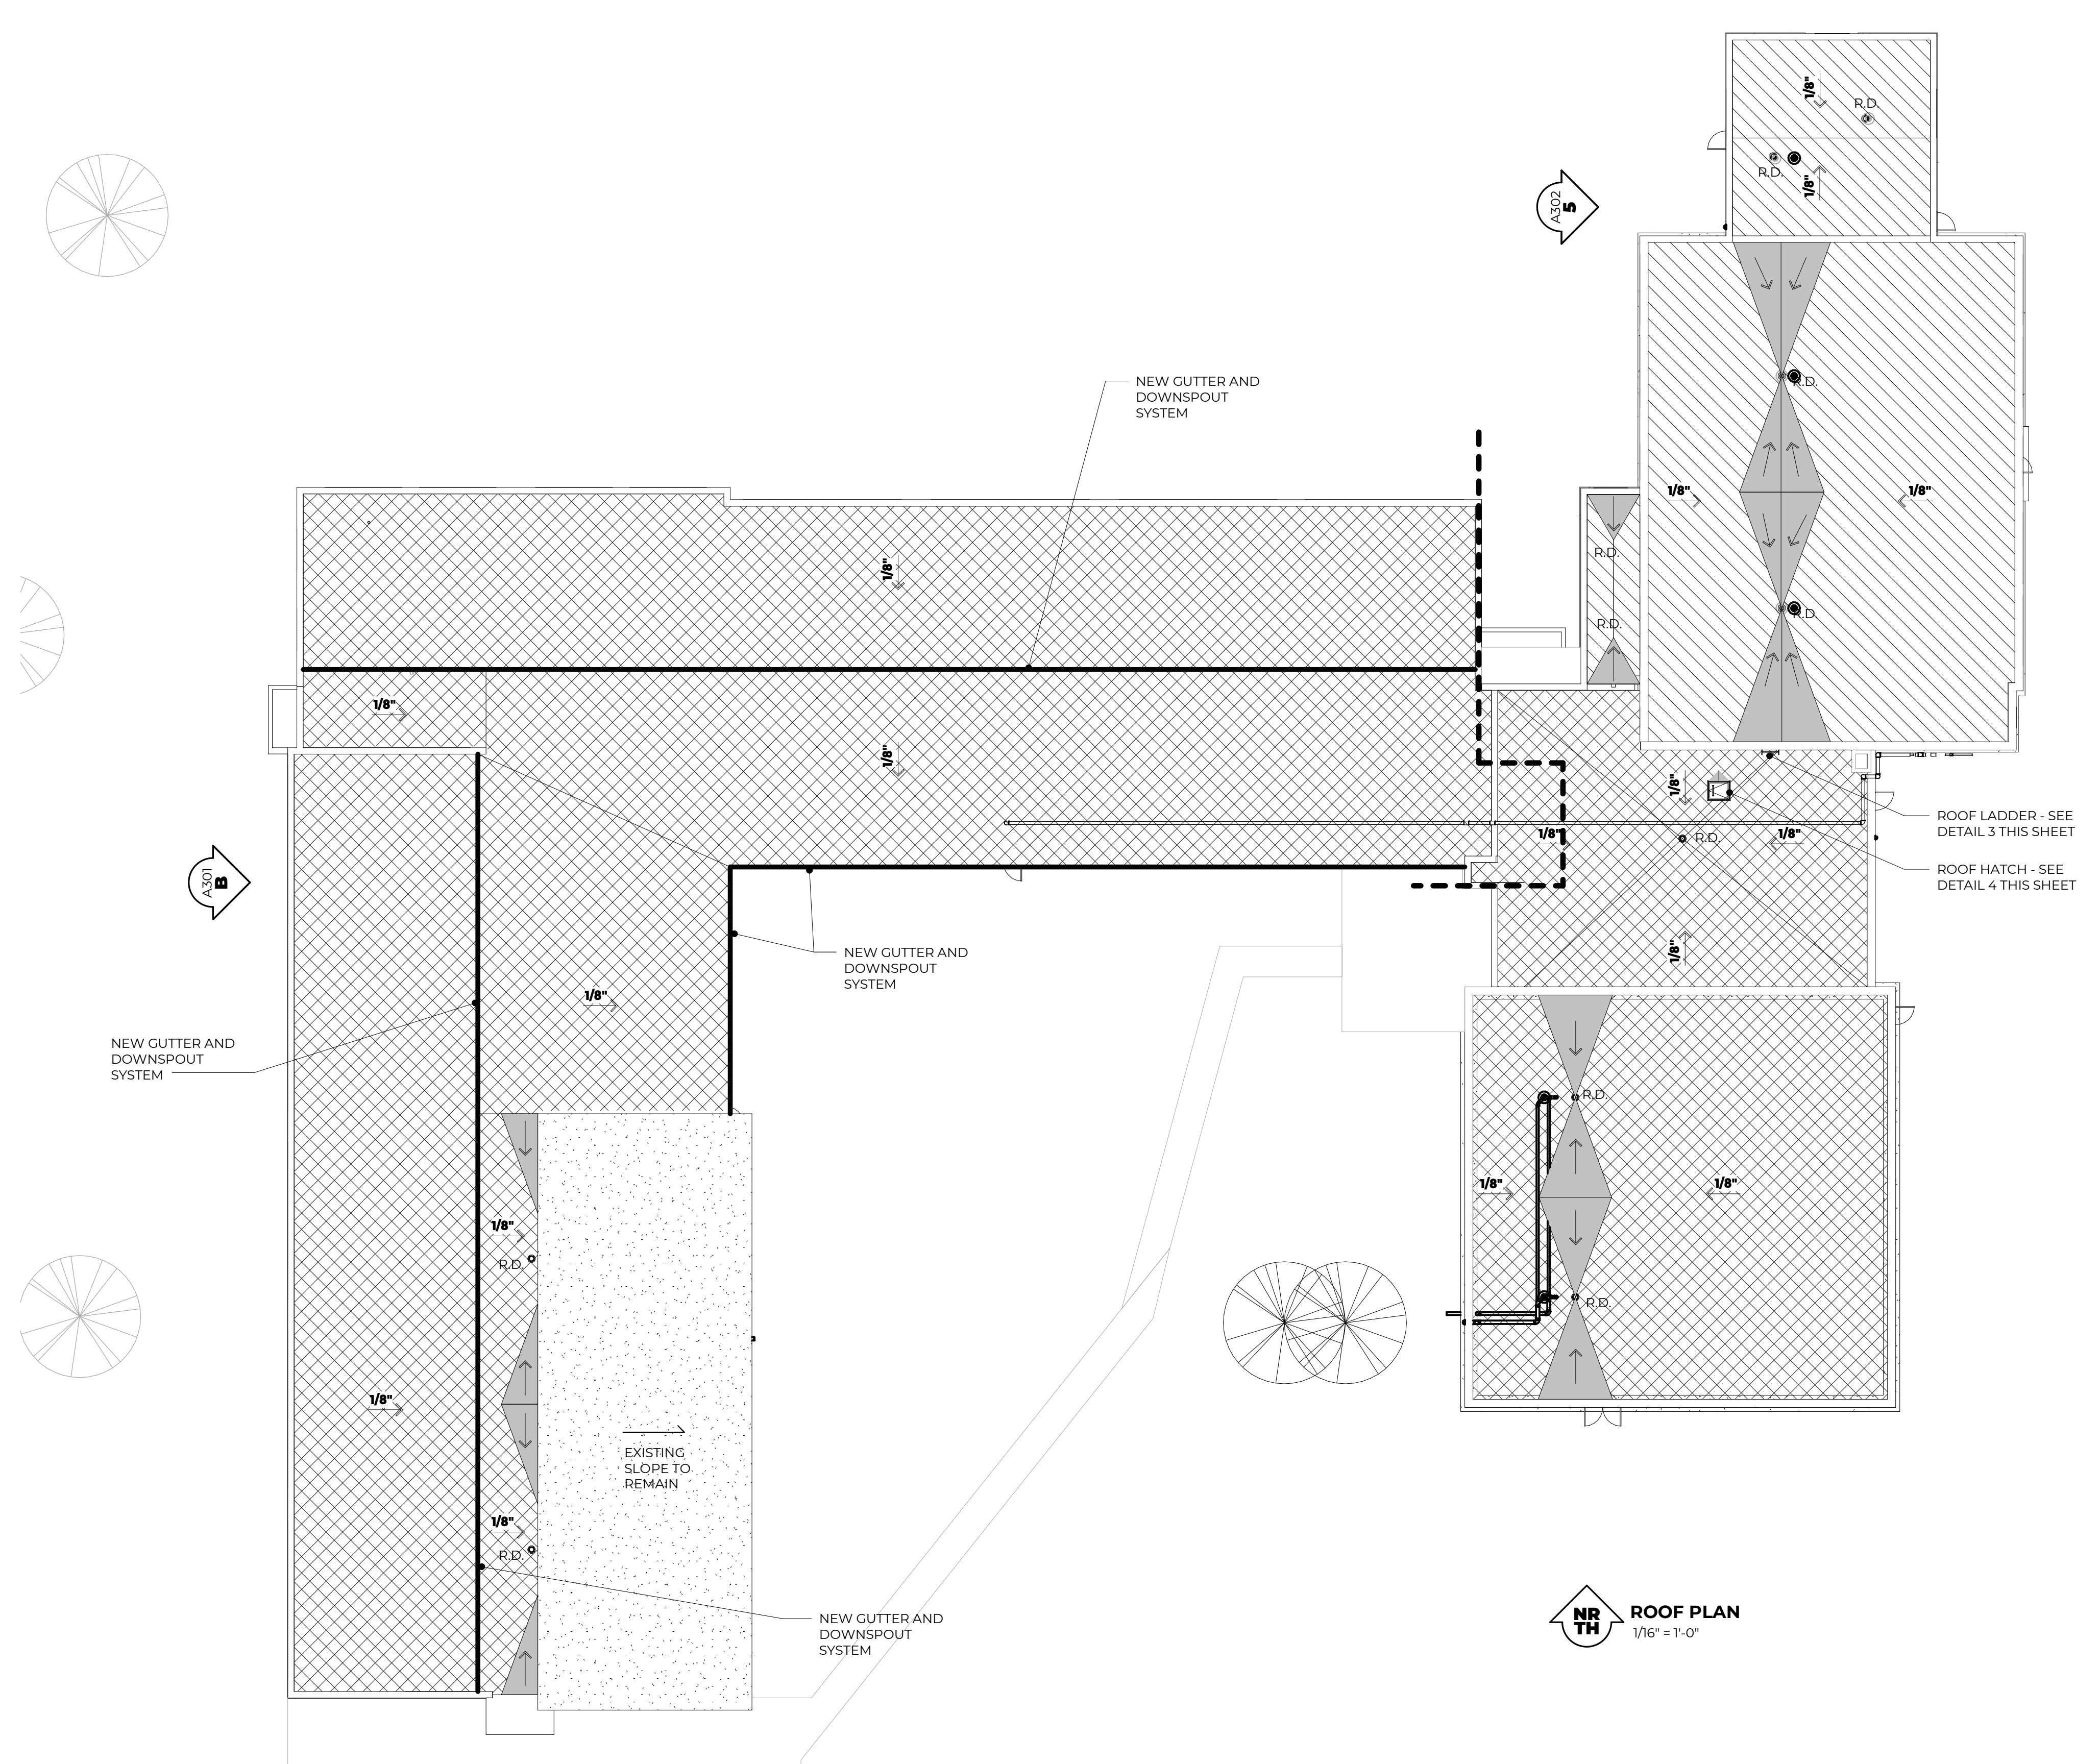


ROOF PLAN
1/16" = 1'-0"

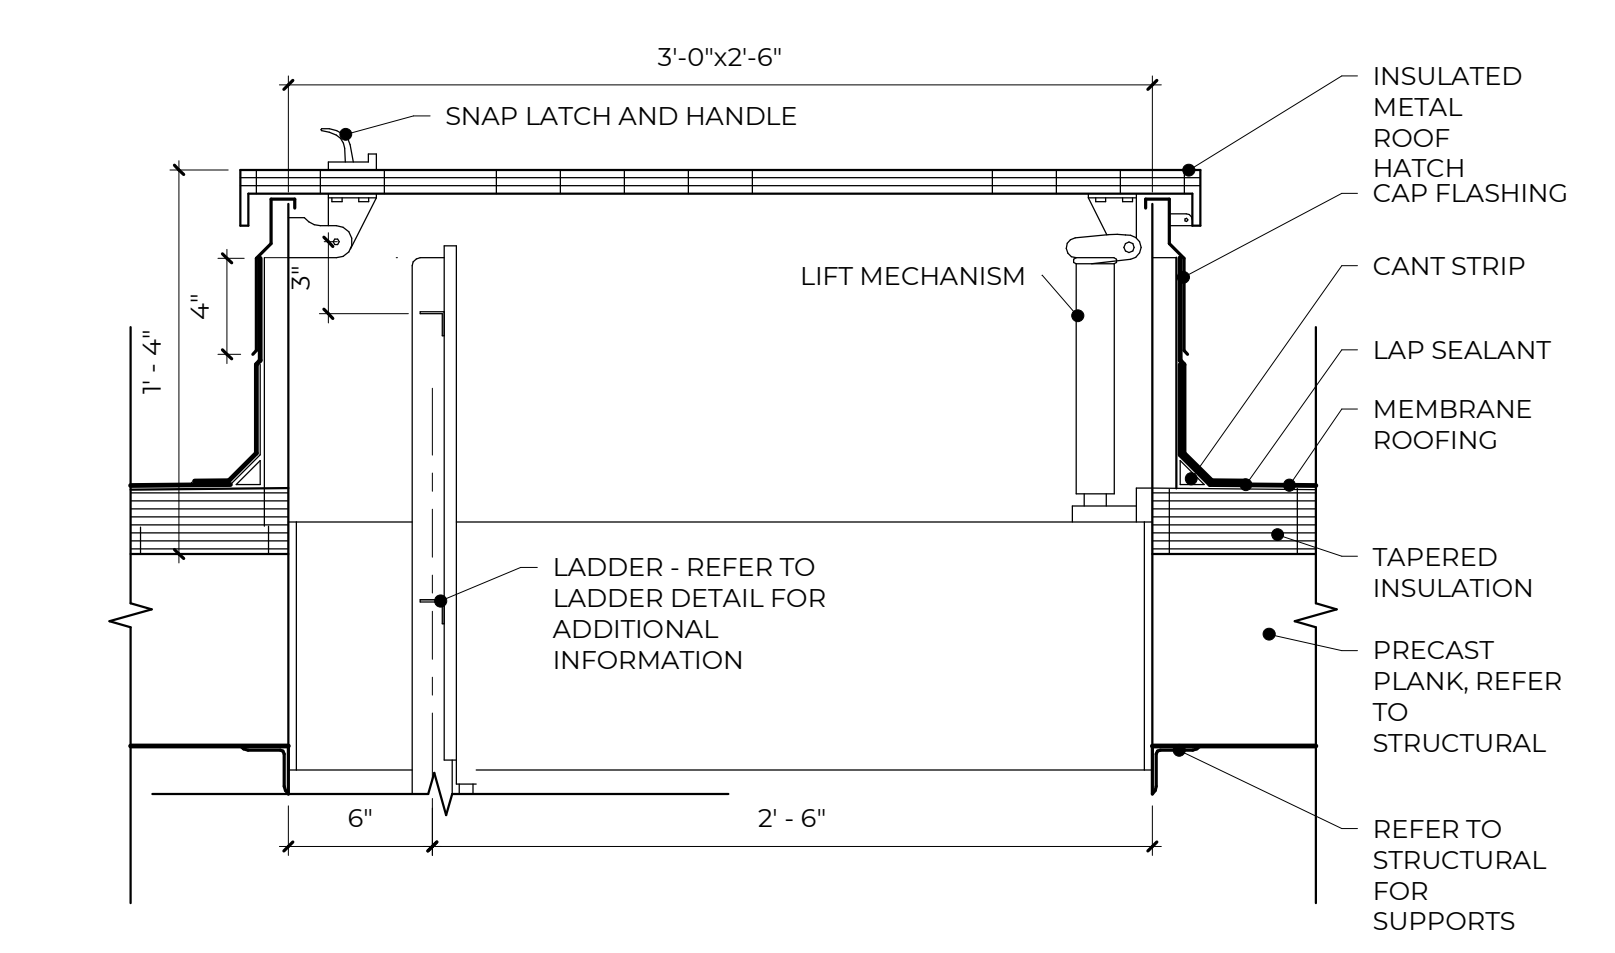

4 ROOF HATCH DETAIL
1 1/2" = 1'-0"

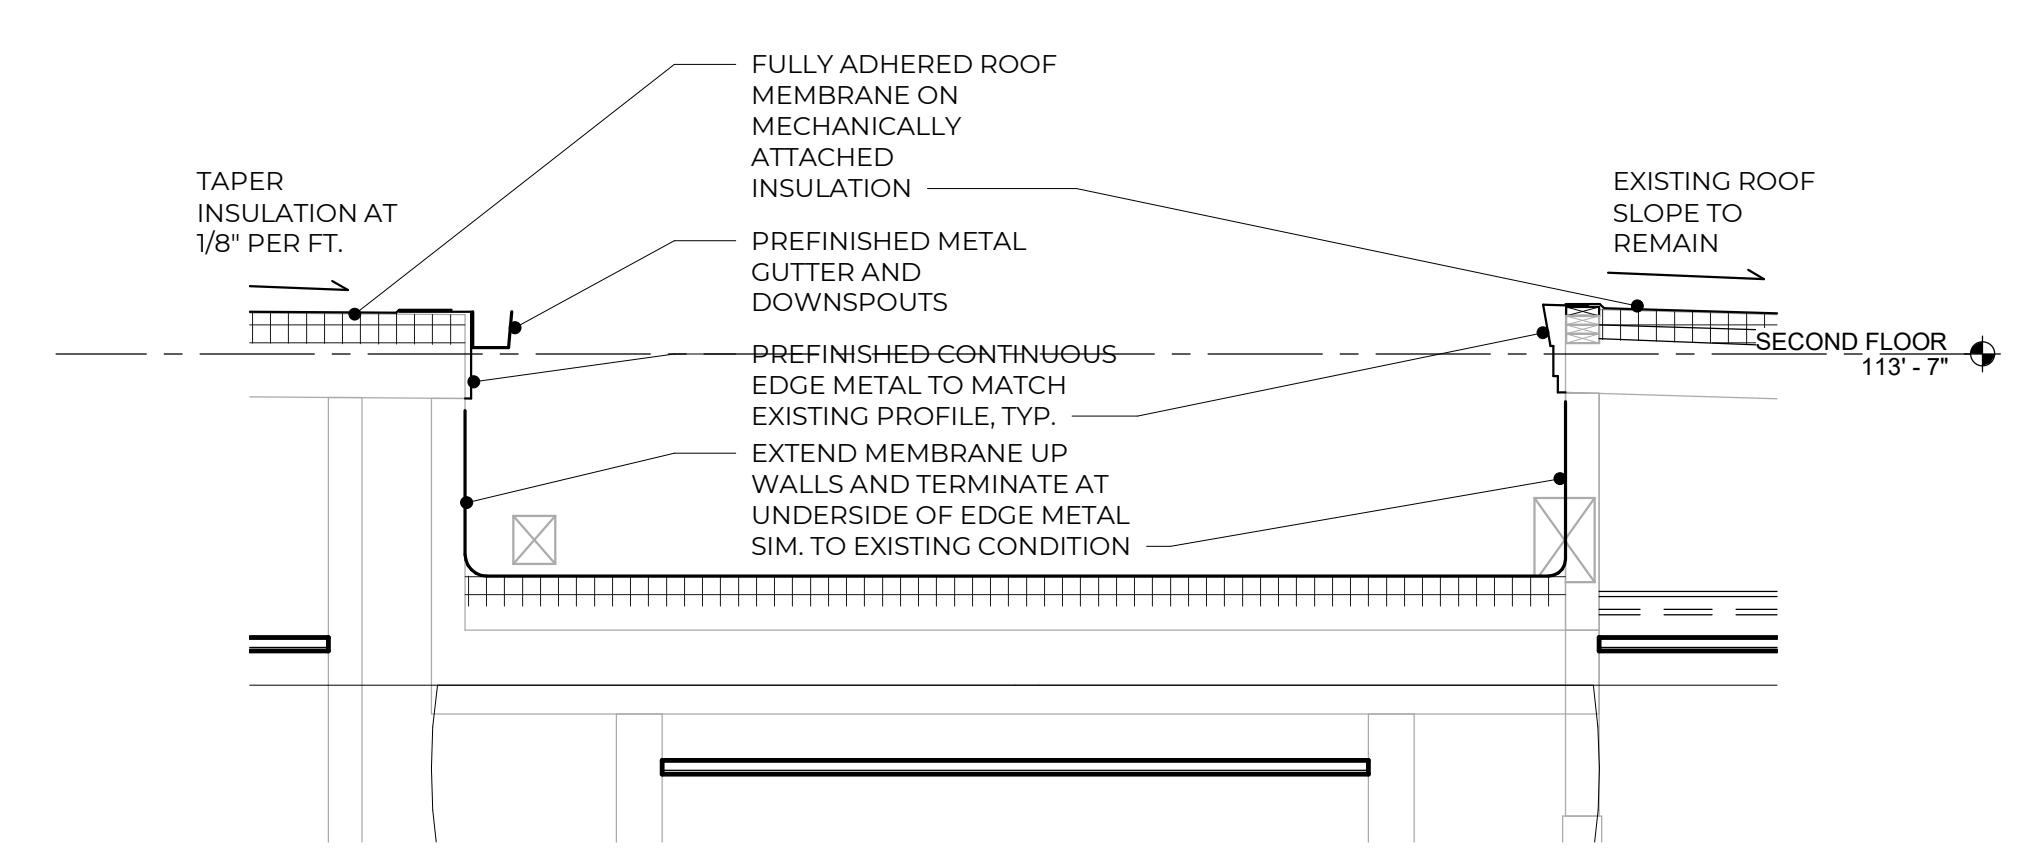

5 ROOF SECTION
3/8" = 1'-0"

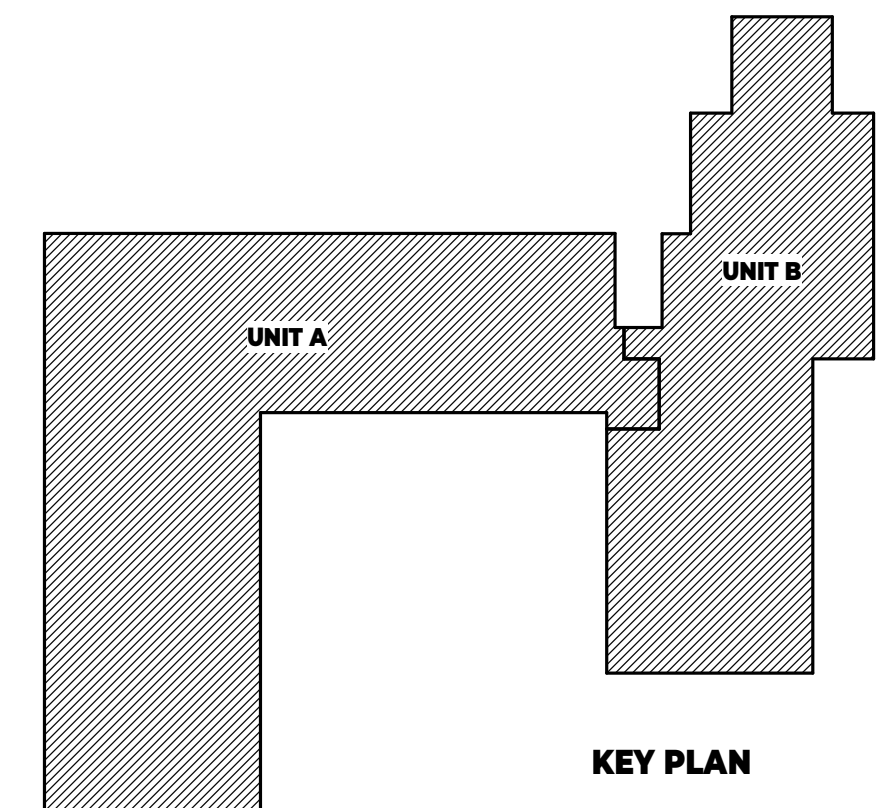

KEY PLAN





FLOOR PLAN LEGEND

ROOM TAG
ROOM NUMBER
ROOM NAME
EXPOSED CEILING


DOOR TAG
DOOR TAG NUMBER
CORRESPONDS TO THE ROOM IN WHICH IT IS USED
THE DECIMAL NUMBER REFERS TO DIFFERENT DOORS IN THE SAME ROOM

WALL TAG
WALL TYPE
WALL FIRE RATING

- FLOOR PLAN KEYED NOTES**
- INFILL WALL MATCH EXISTING.
 - REFER TO INTERIOR DRAWINGS FOR SCOPE OF FINISHES AT CLASSROOM RESTROOMS.
 - LOUVER, COORDINATE WITH VUV LOCATIONS.
 - CLASSROOM EGRESS WINDOW. REFER TO FRAME ELEVATIONS FOR CLEARANCE DIMENSIONS.
 - WALL MOUNTED LADDER TO ROOF WITH ROOF HATCH ABOVE - REFERENCE ROOF PLAN FOR DETAILS
 - INFILL EXISTING OPENING, MATCH EXISTING. - REFERENCE IMAGE ON SHEET A101B
 - INFILL EXISTING HUV MASONRY LOUVER OPENING WITH 6" CMU FLUSH WITH INTERIOR FACE OF EXISTING CMU WALL WITH SPRAY APPLIED INSULATION IN CAVITY. FURR OUT INTERIOR SIDE WITH HAT CHANNELS AND GYPSUM BOARD FLUSH WITH EXISTING. PROVIDE BLANK-OFF PANEL AT REAR FACE OF EXISTING LOUVER EXISTING. LOUVER TO BE PAINTED TO MATCH WINDOW FRAMING. ENTIRE FACE OF INTERIOR WALL TO BE PAINTED TO MATCH ADJACENT WALLS
 - PAINT ENTIRE WALL WHERE MECHANICAL UNIT IS TO BE REMOVED TO MATCH ADJACENT WALLS, TYP.
 - PAINT EXISTING EIFS TO MATCH ADJACENT STOREFRONT SYSTEM

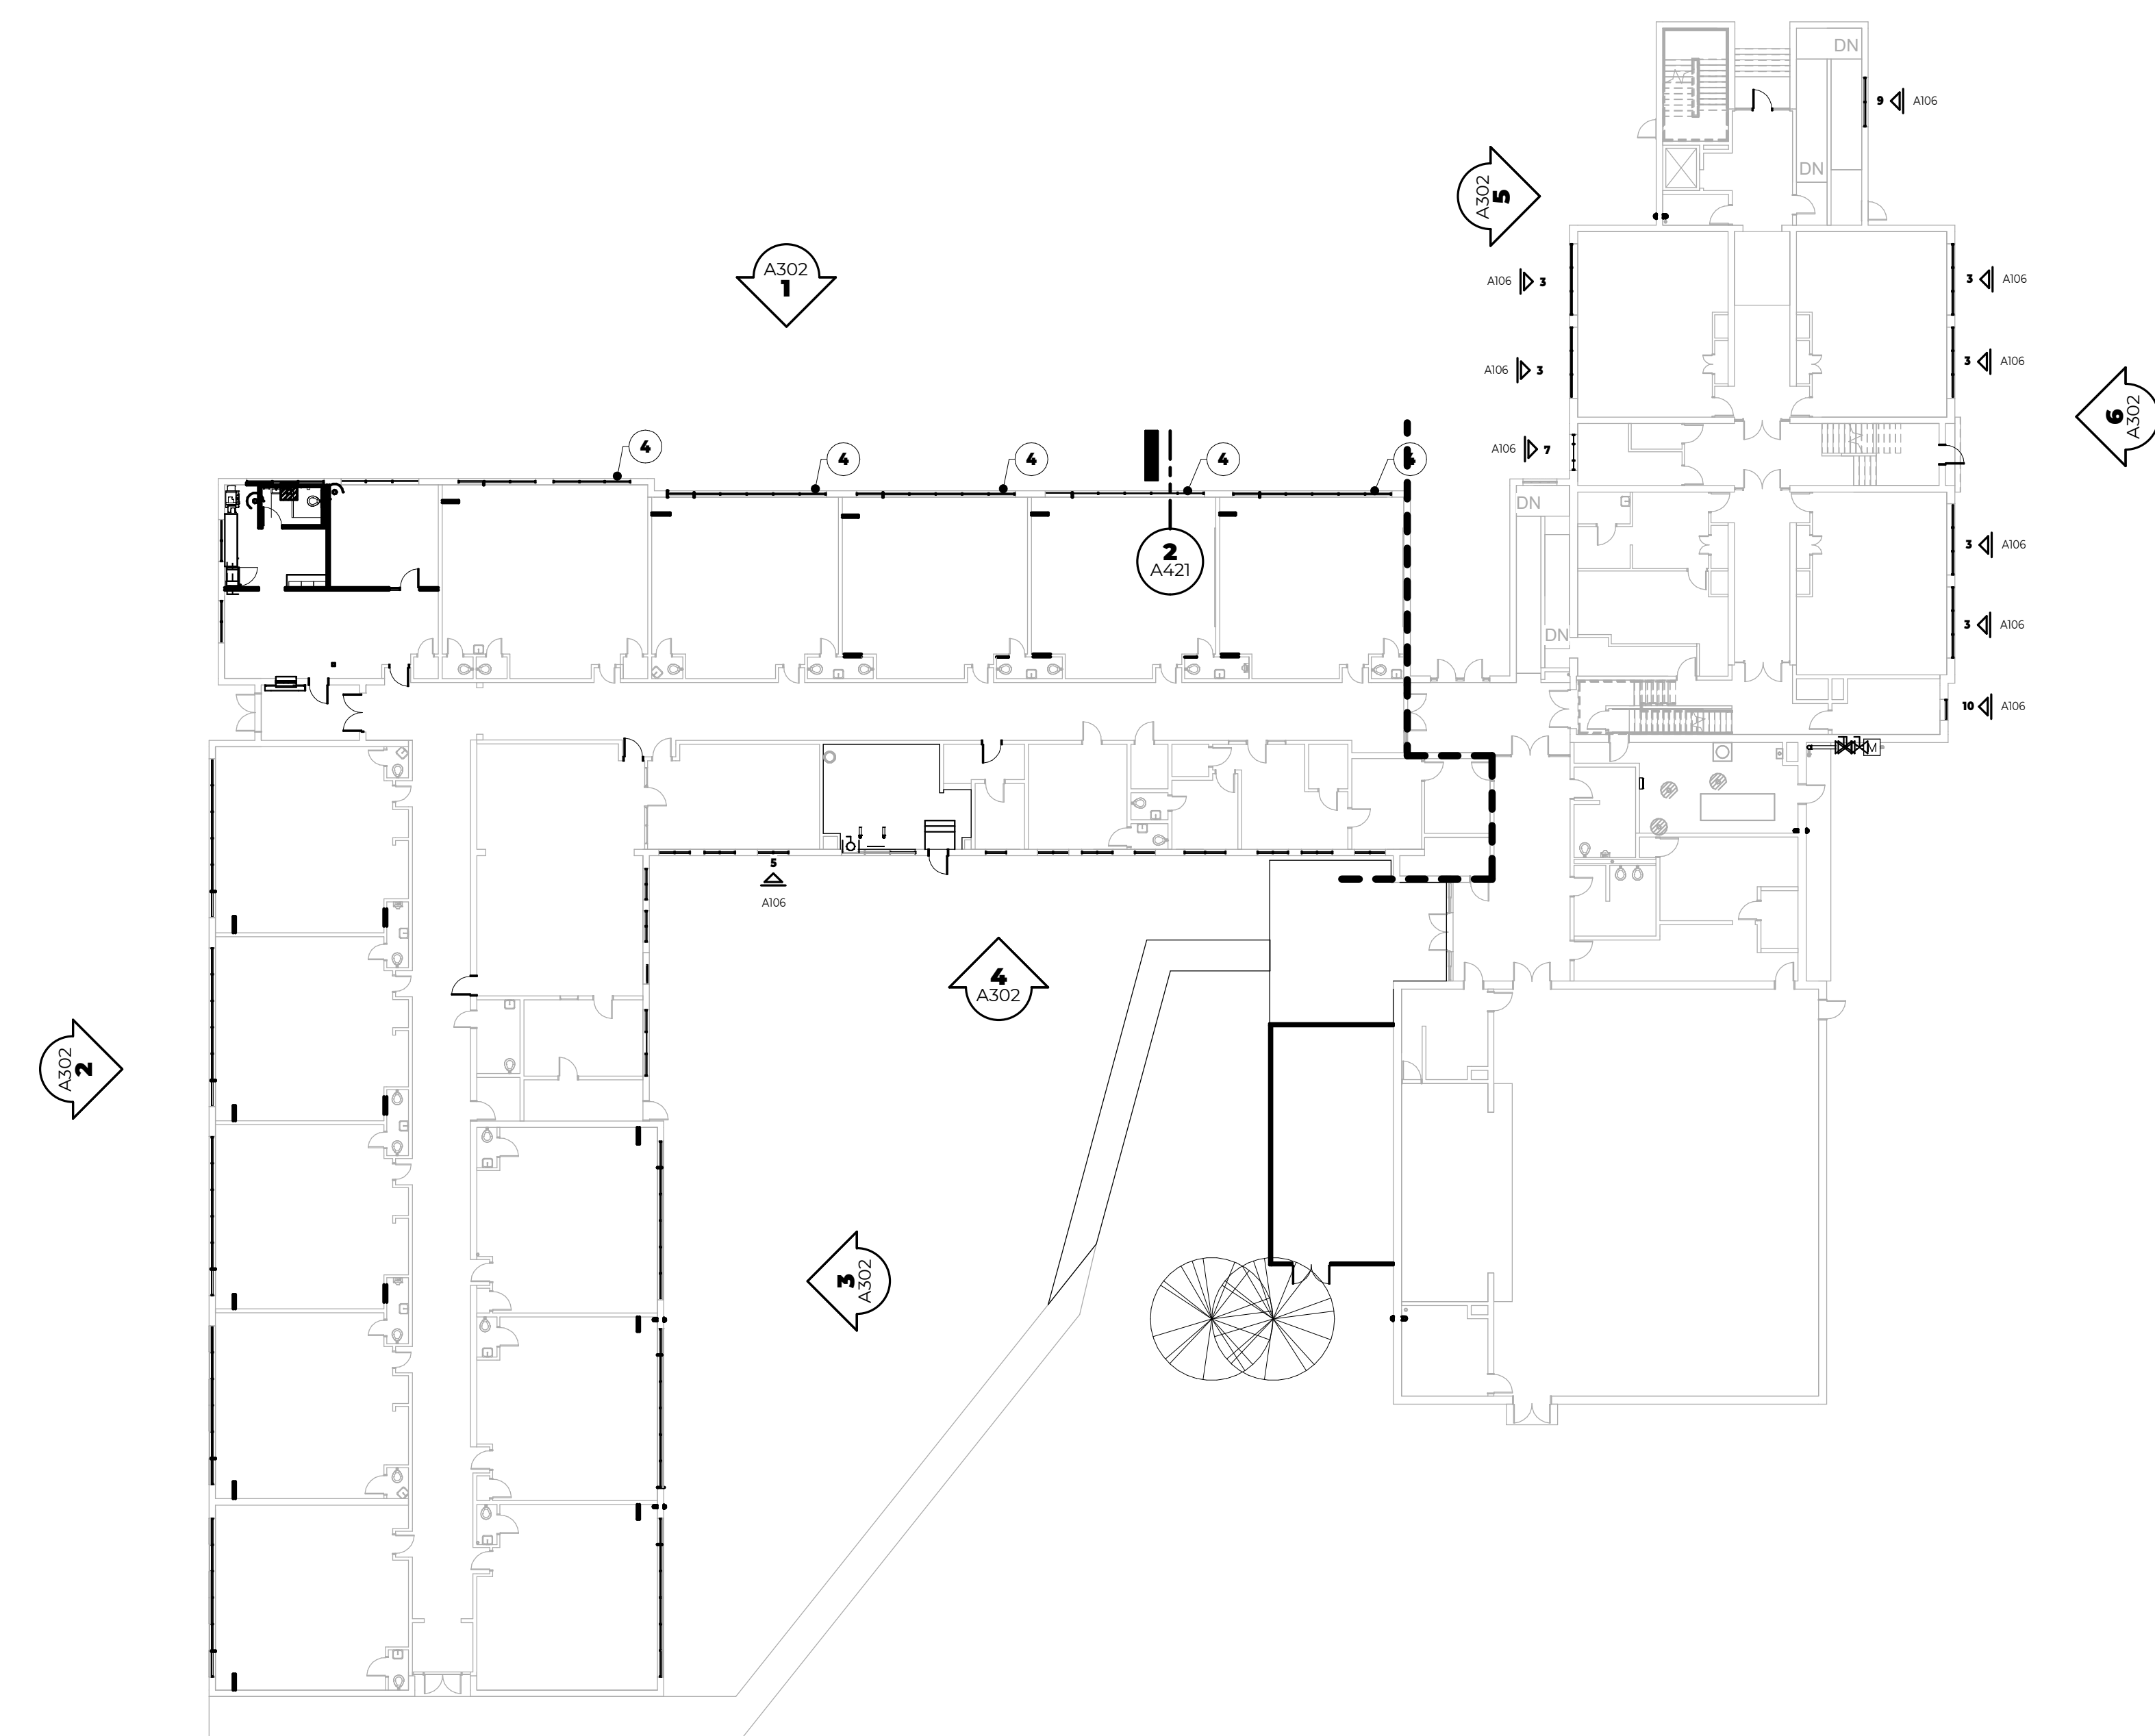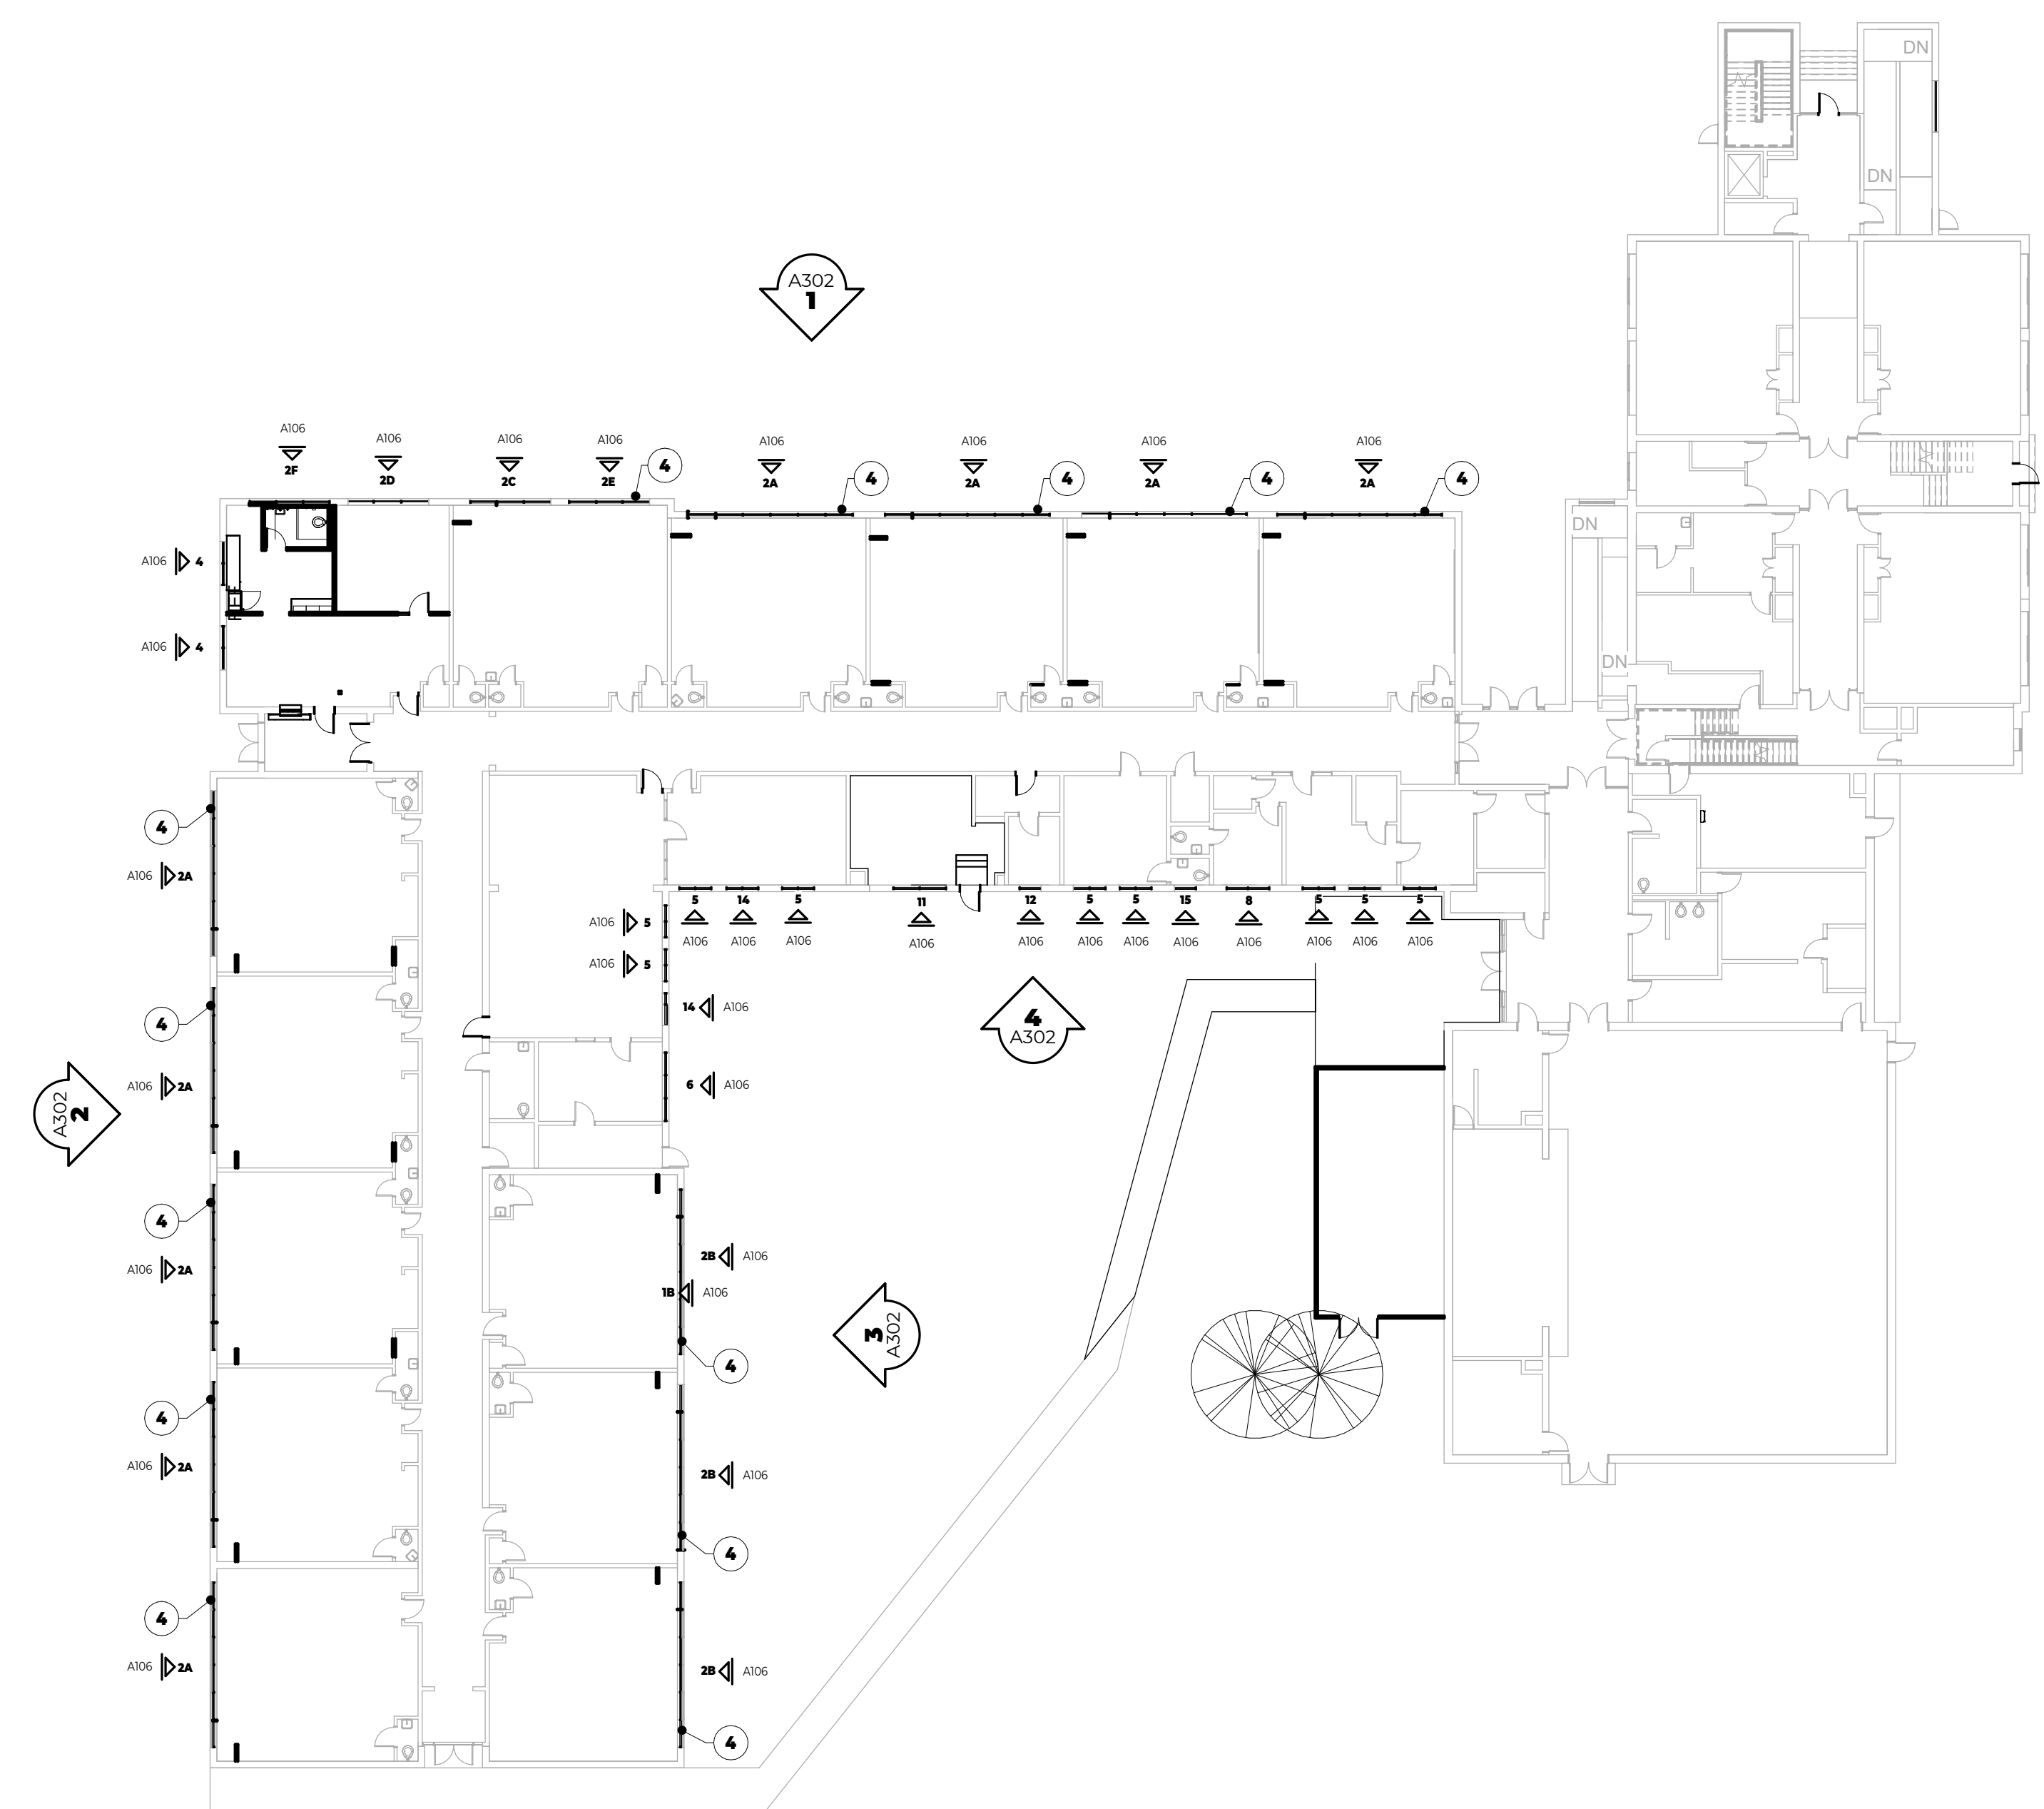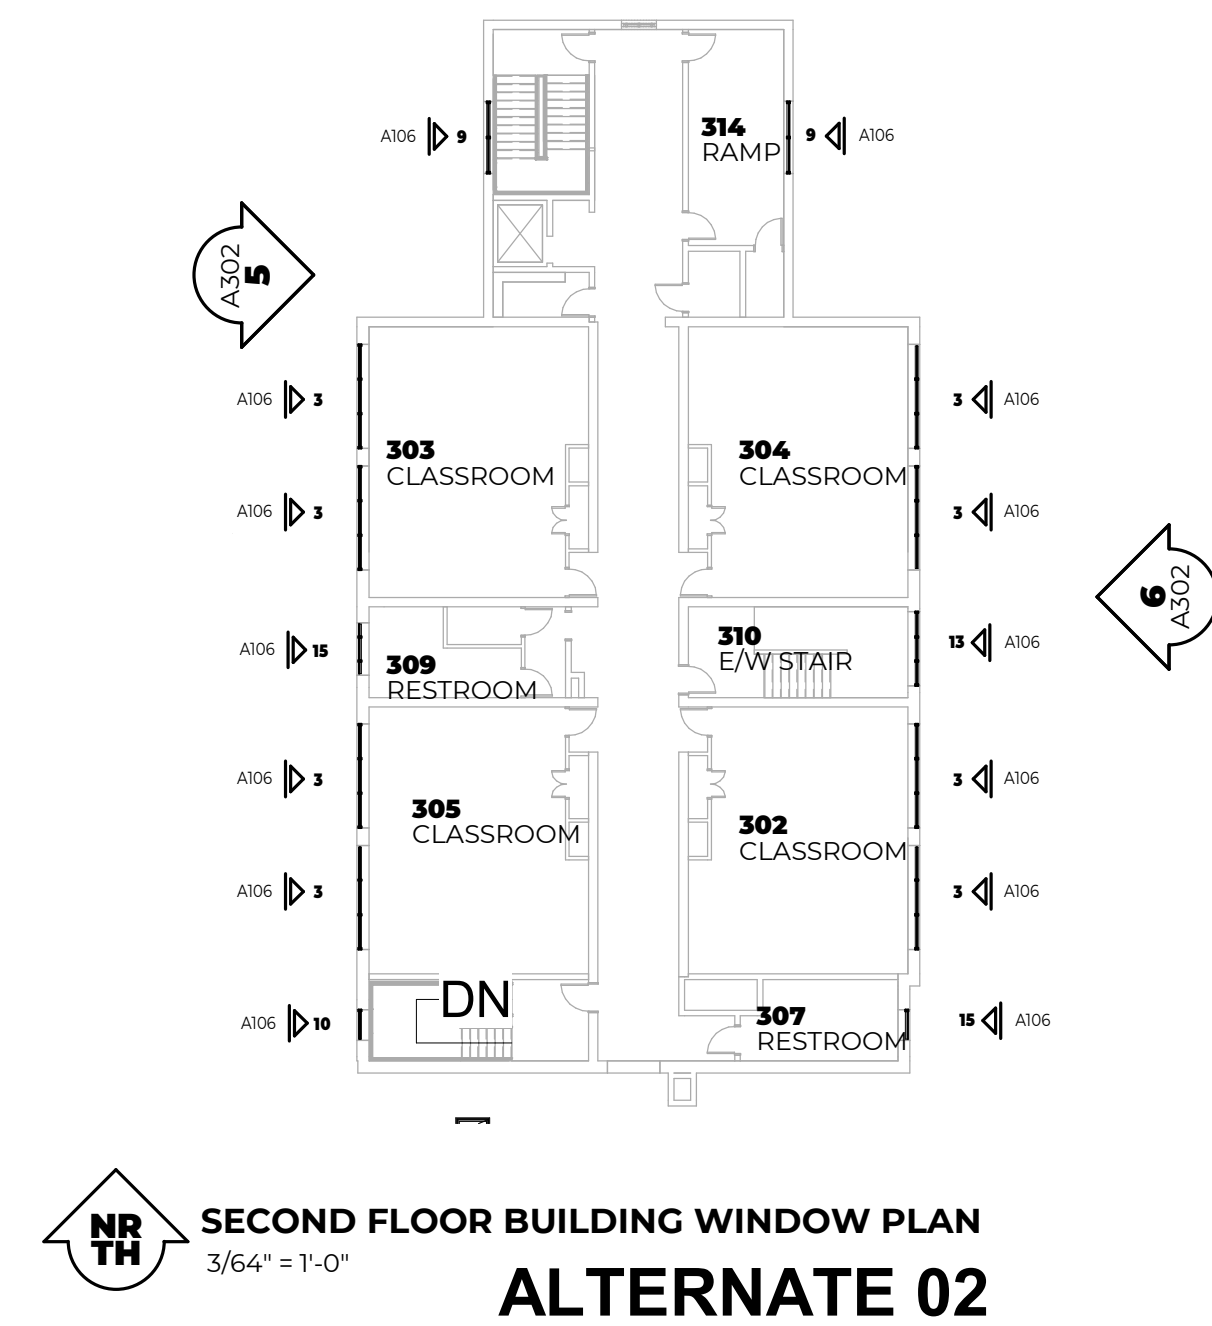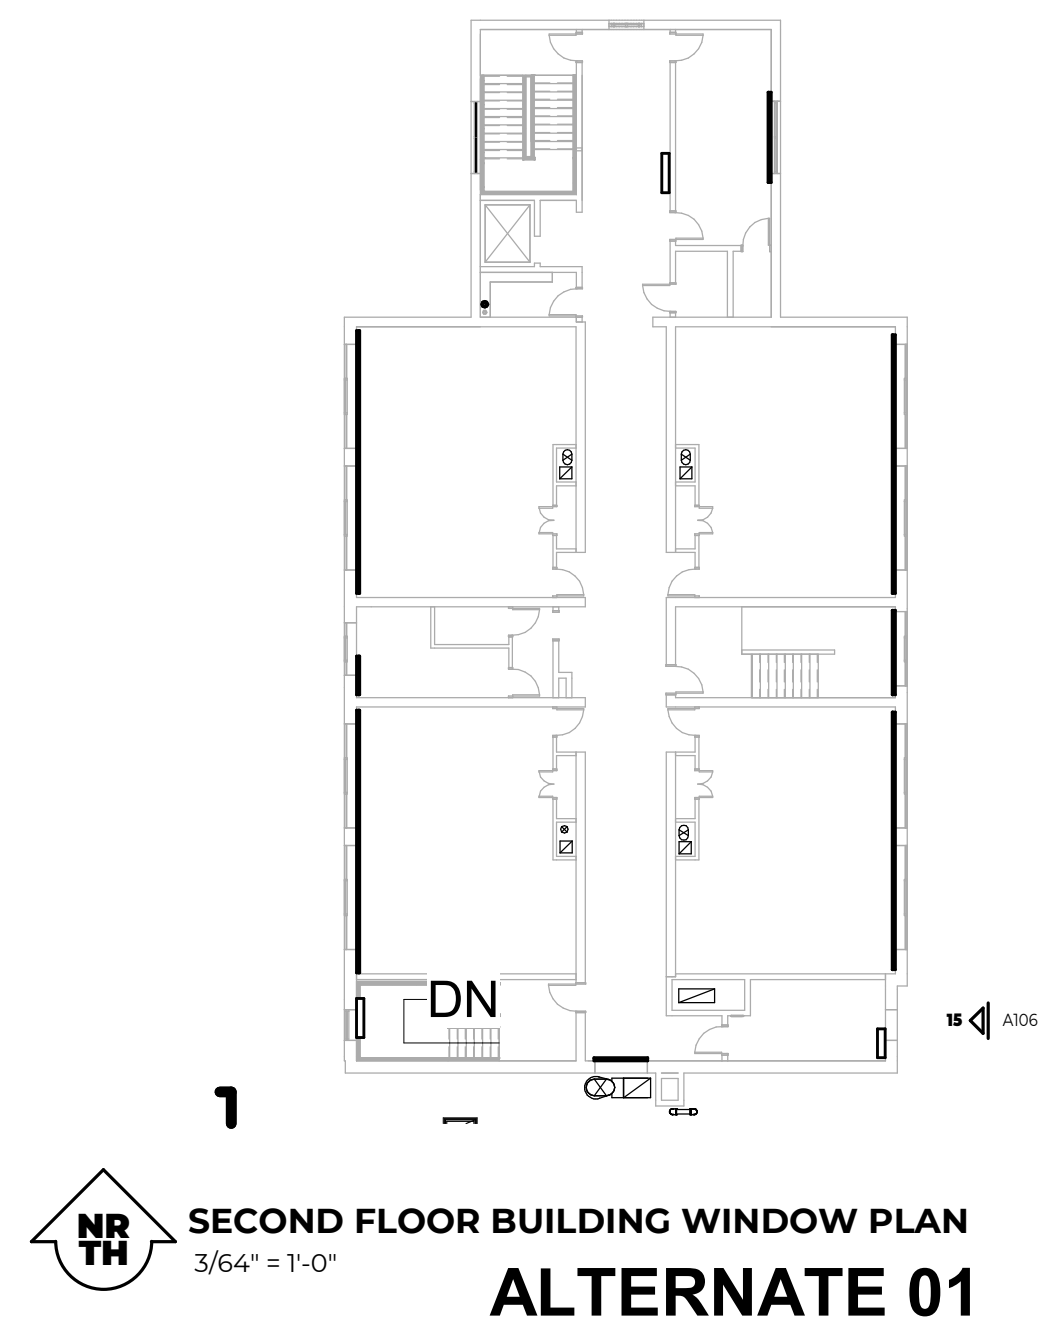


ALTERNATE 02 IS IN ADDITION TO ALTERNATE 01.

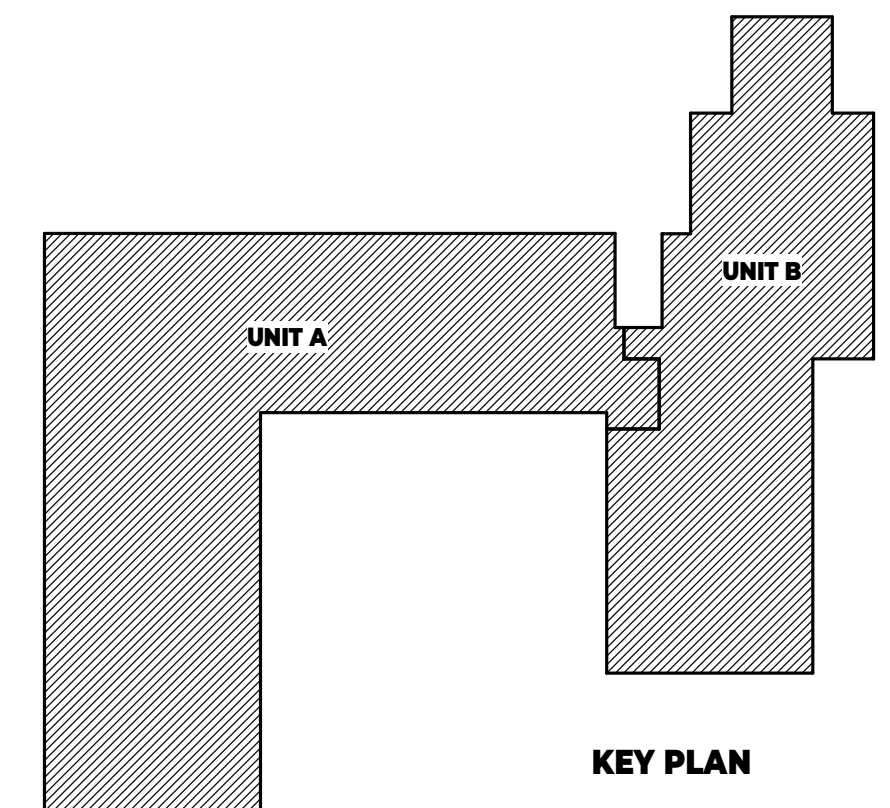


| REVISIONS | | |
|--|------------|------------|
| SYM | DATE | ISSUED FOR |
| | 03.08.2024 | |
| ISSUE DATE | | |
| SHEET NAME | | |
| BUILDING WINDOW PLAN - ALTERNATE 01 & ALTERNATE 02 | | |
| SHEET NUMBER | | |
| A105 | | |
| ©2022 PROJECT NO. 22.114 | | |


| GLAZING SCHEDULE | | |
|------------------|--|------|
| MARK | GLAZING DESCRIPTION | MFR. |
| IG01 | 1/4" CLEAR GLASS ON BOTH SIDES WITH 100% ARGON FILLED 1/2" AIR CAVITY WITH SUNGUARD SNX 62/27 ON SURFACE 3 | |
| IG02 | 1/4" CLEAR GLASS ON BOTH SIDES WITH 100% ARGON FILLED 1/2" AIR CAVITY WITH SUNGUARD SNR 43 ON SURFACE 2 | |
| IG03 | SIMILAR TO IG01 BUT BACKPAINTED AS SPANDREL GLASS | |
| IG04 | SIMILAR TO IG02 BUT BACKPAINTED AS SPANDREL GLASS | |
| IG05 | SIMILAR TO IG02 WITH TRANSLUCENCY TO DIFFUSE LIGHT INTO THE SPACE | |

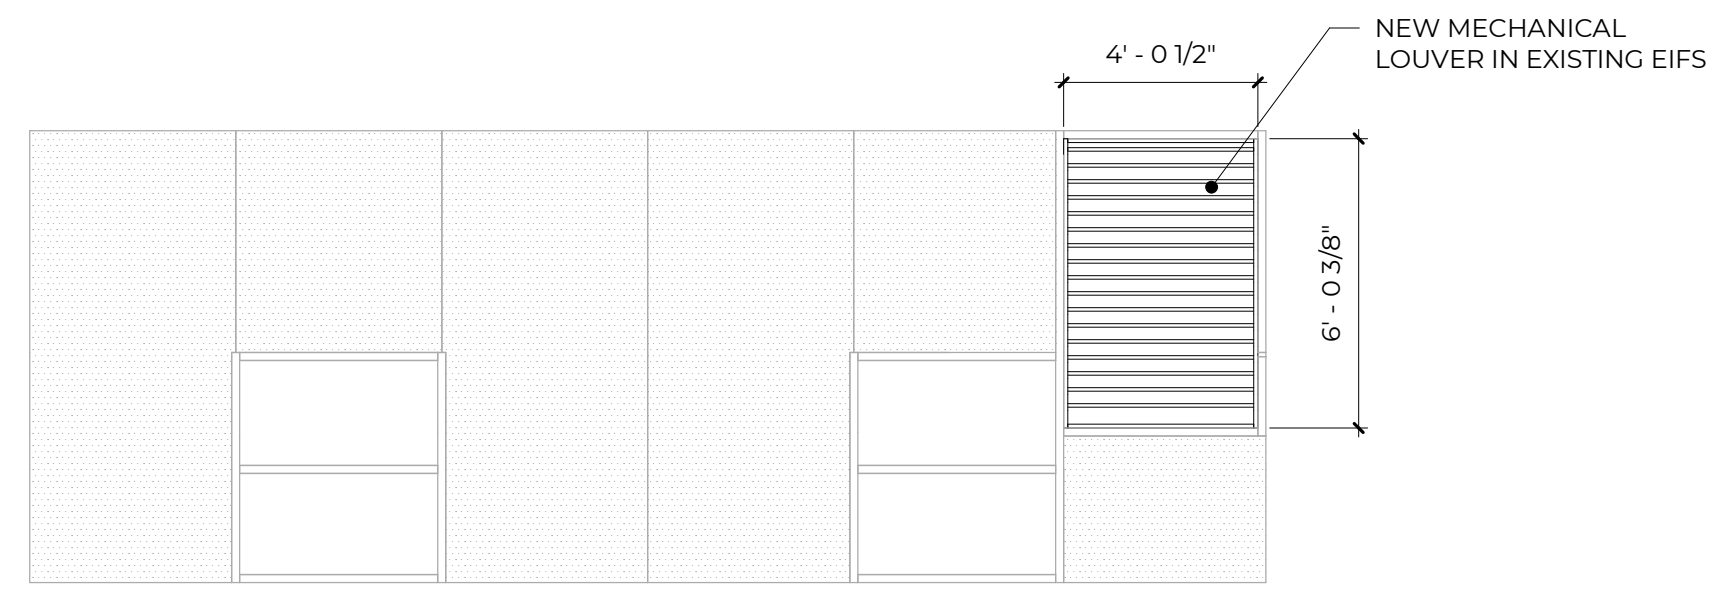


1A WINDOW BAY INTERVENTION TYPE 1A
1/4" = 1'-0"

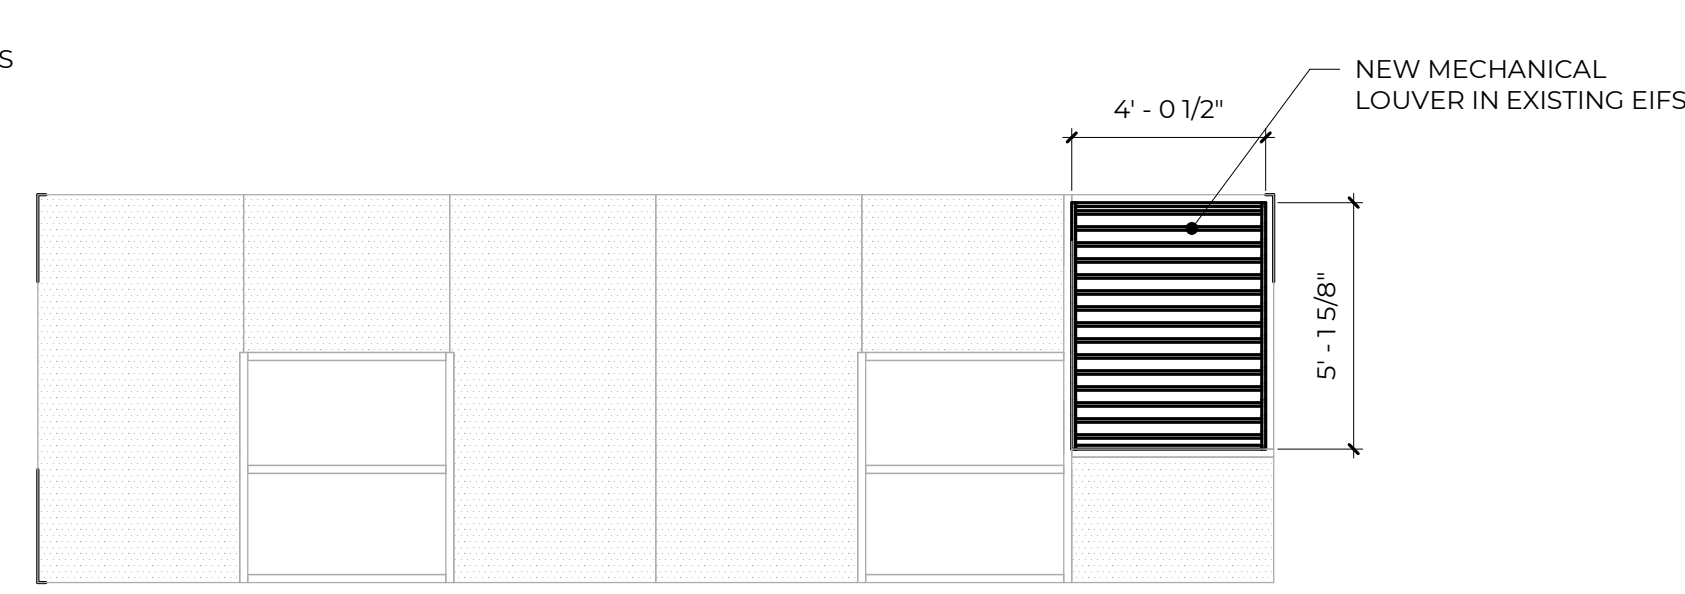


1B WINDOW BAY INTERVENTION TYPE 1B
1/4" = 1'-0"

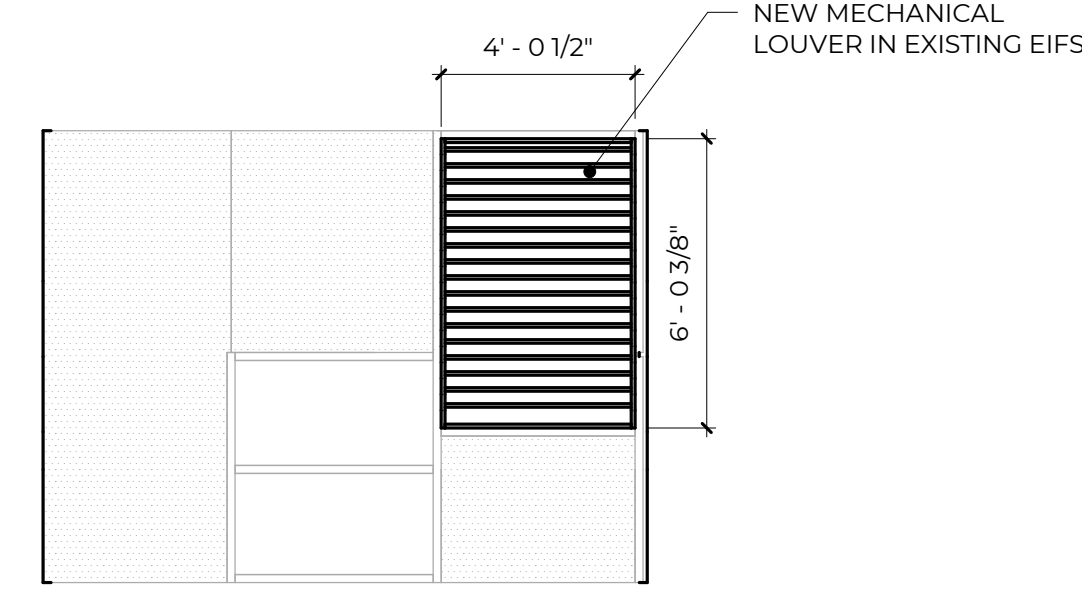


1C WINDOW BAY INTERVENTION TYPE 1C
1/4" = 1'-0"

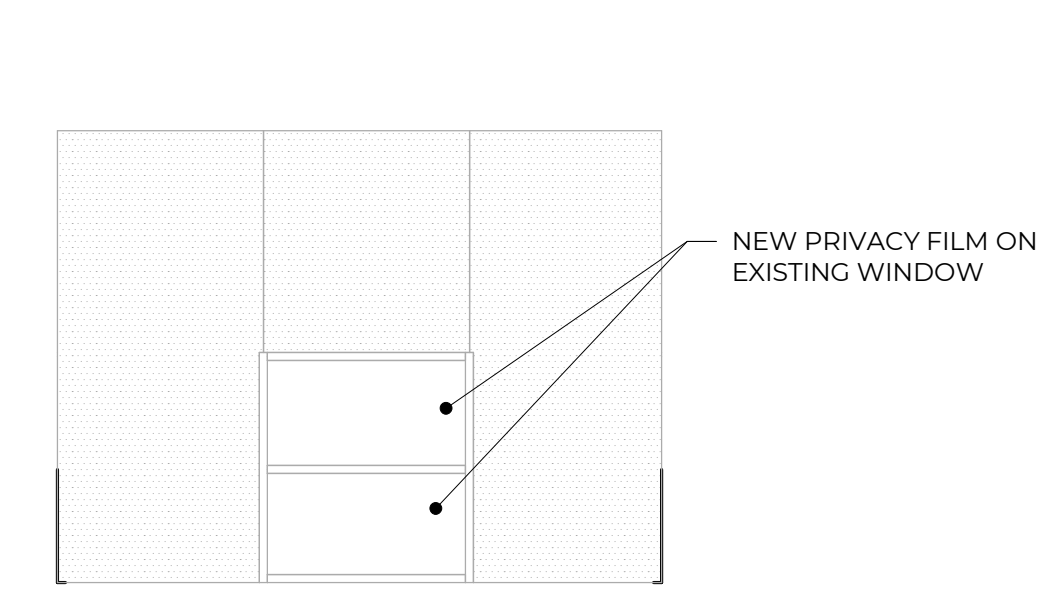


1D WINDOW BAY INTERVENTION TYPE 1D
1/4" = 1'-0"

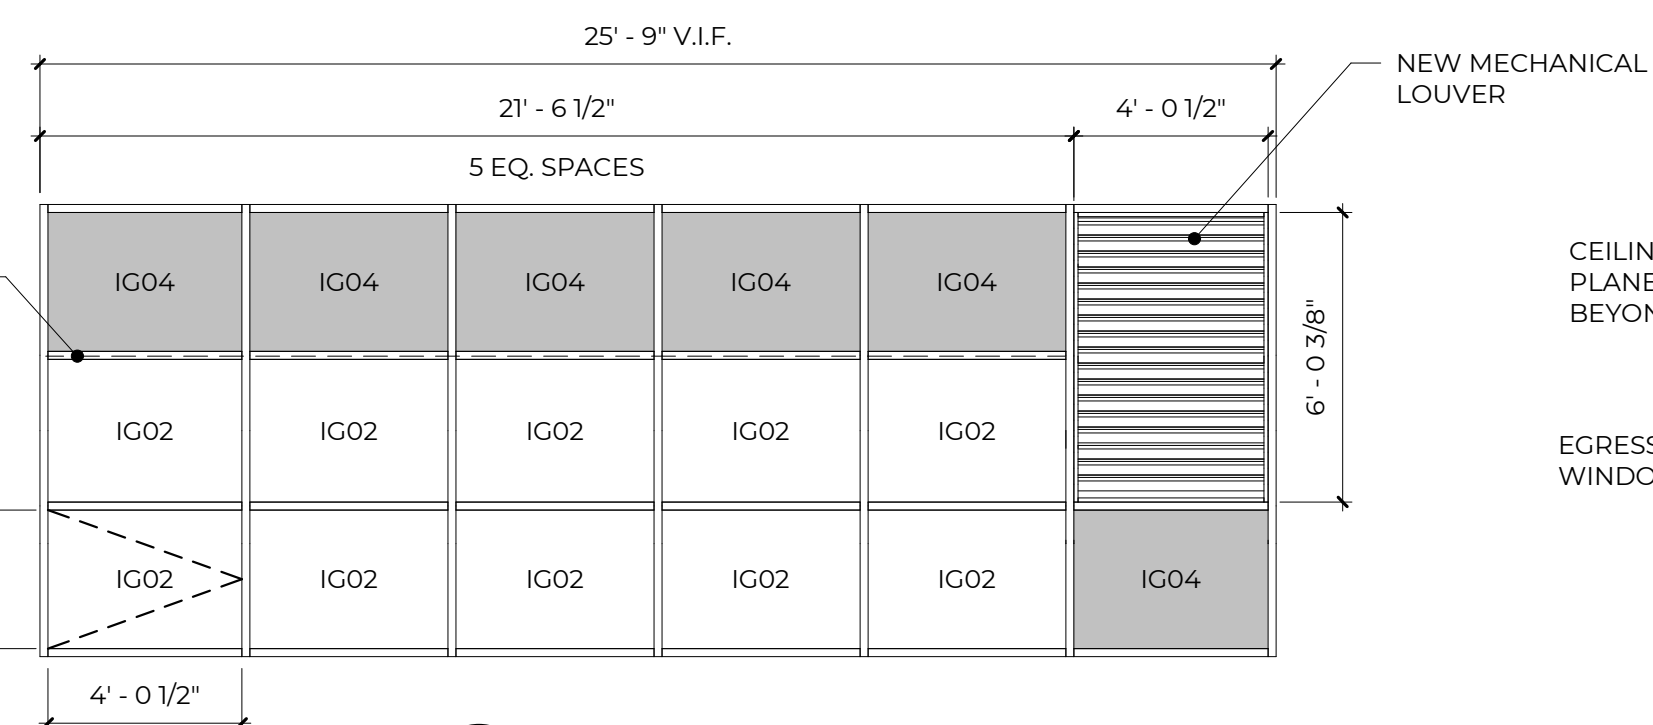


2A WINDOW BAY INTERVENTION TYPE 2A
1/4" = 1'-0"

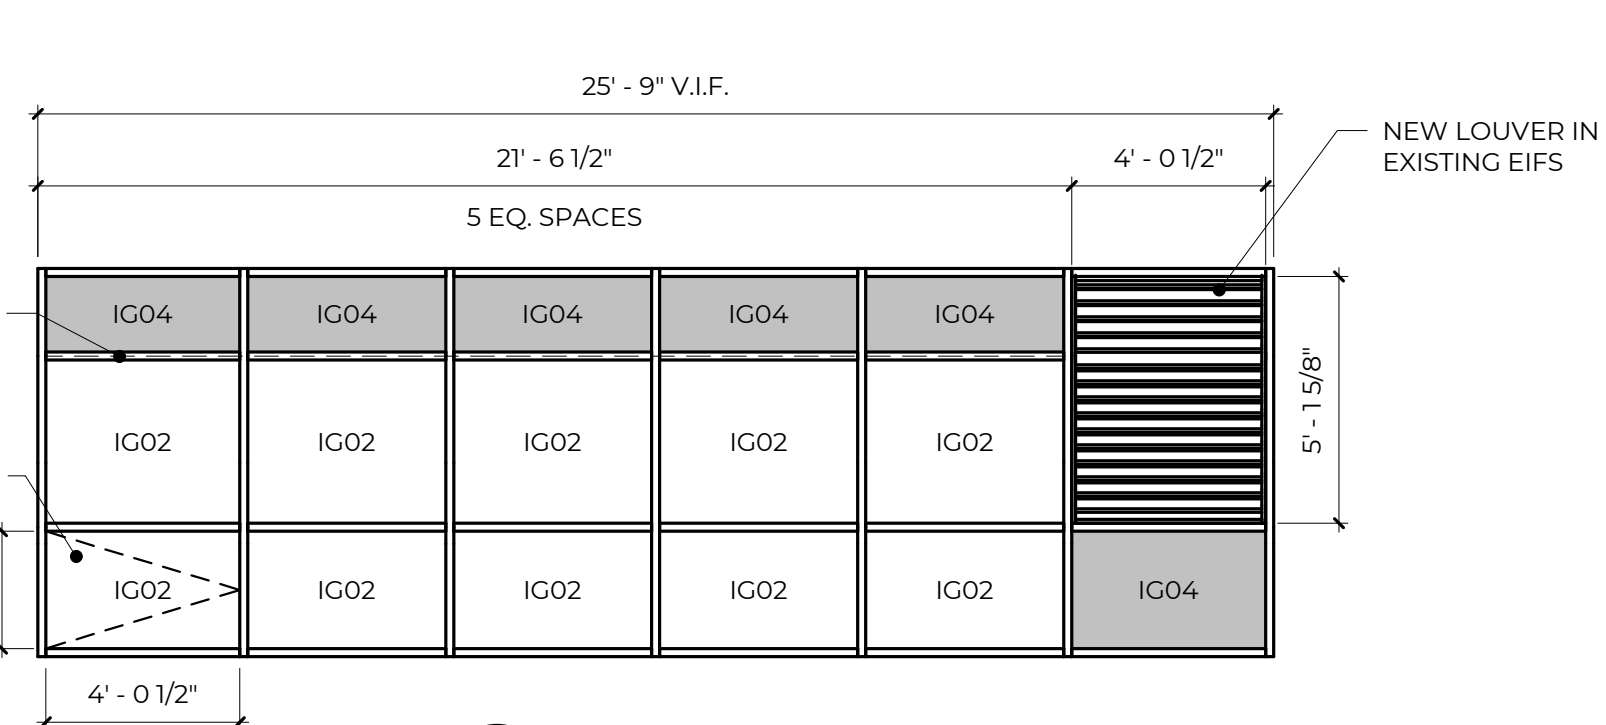


2B WINDOW BAY INTERVENTION TYPE 2B
1/4" = 1'-0"

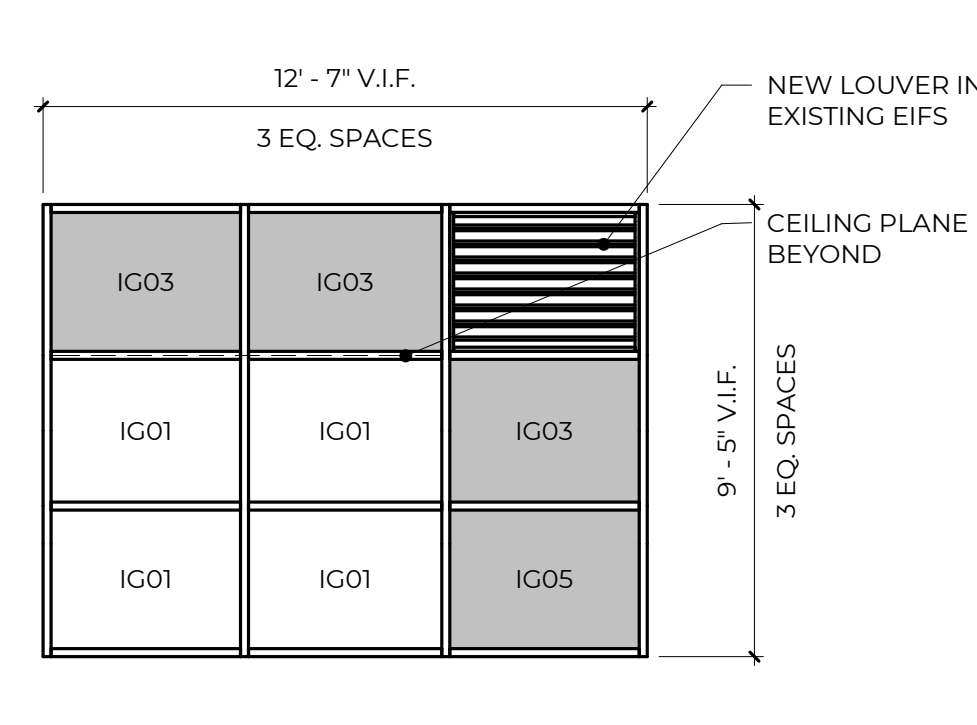


2C WINDOW INTERVENTION TYPE 2C
1/4" = 1'-0"

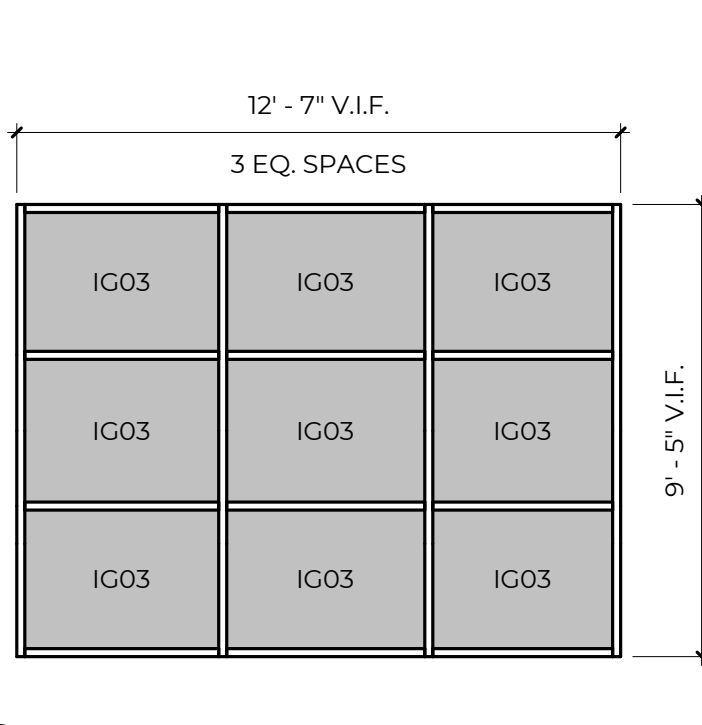


2D WINDOW INTERVENTION TYPE 2D
1/4" = 1'-0"

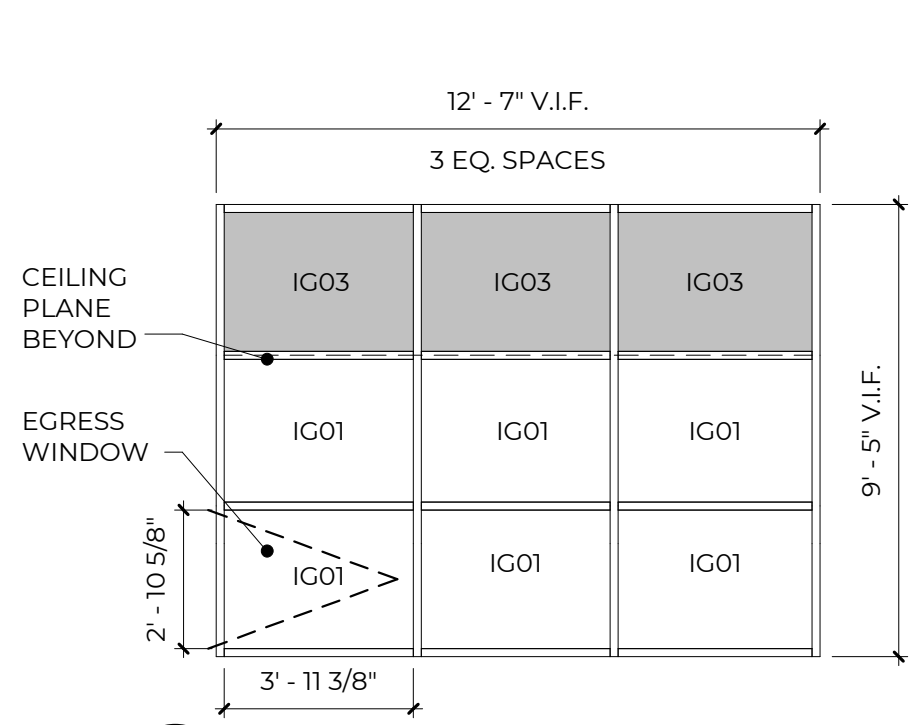


2E WINDOW INTERVENTION TYPE 2E
1/4" = 1'-0"

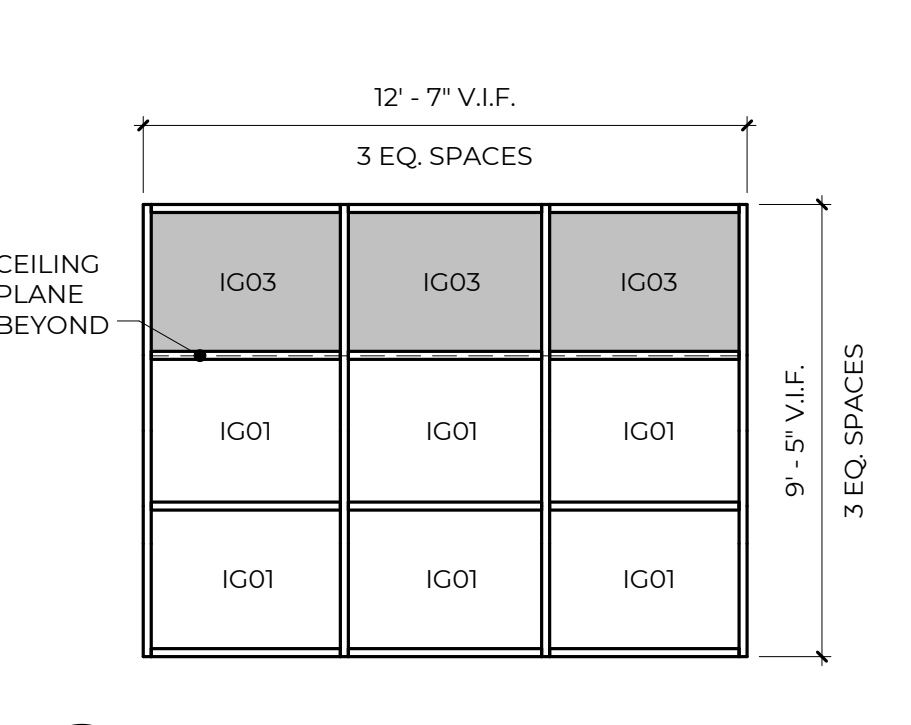


2F WINDOW BAY INTERVENTION TYPE 2F
1/4" = 1'-0"

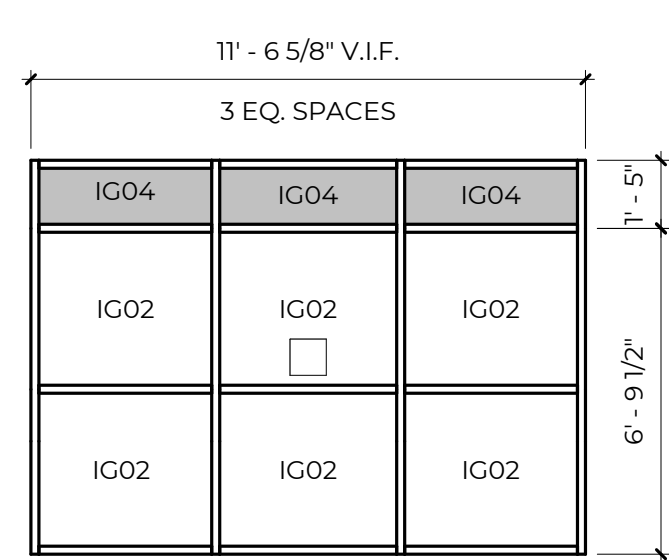


3 WINDOW BAY INTERVENTION TYPE 3
1/4" = 1'-0"

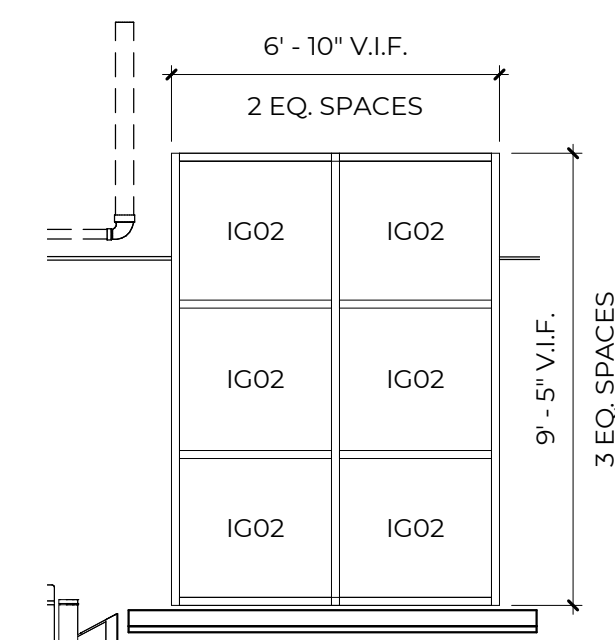


4 WINDOW BAY INTERVENTION TYPE 4
1/4" = 1'-0"

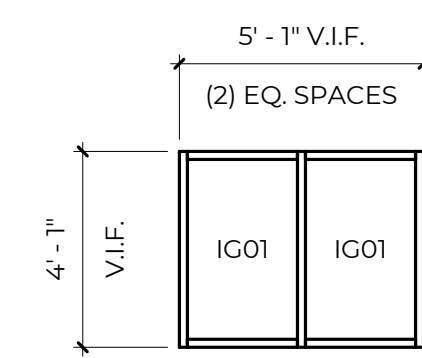


5 WINDOW BAY INTERVENTION TYPE 5
1/4" = 1'-0"

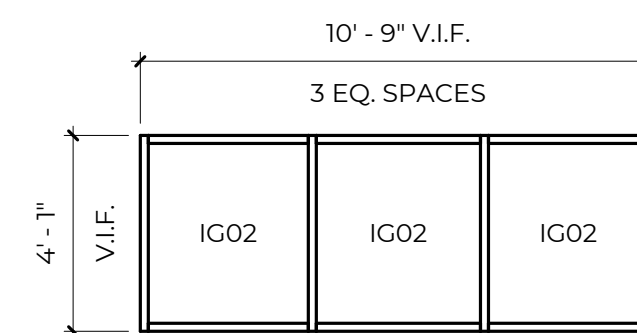


6 WINDOW BAY INTERVENTION TYPE 6
1/4" = 1'-0"

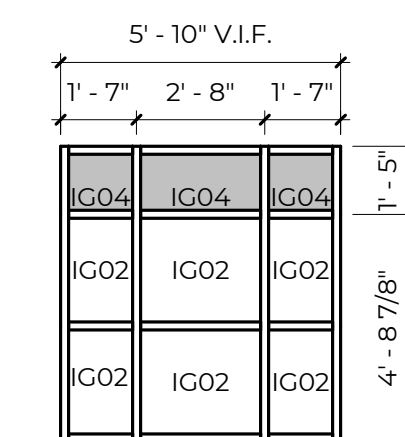


7 WINDOW BAY INTERVENTION TYPE 7
1/4" = 1'-0"

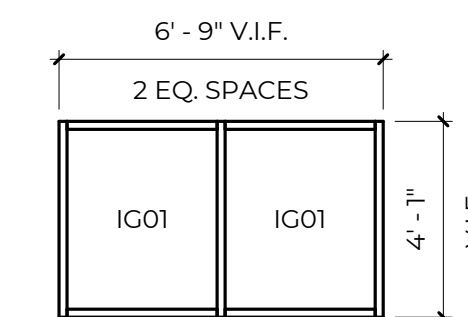


8 WINDOW BAY INTERVENTION TYPE 8
1/4" = 1'-0"

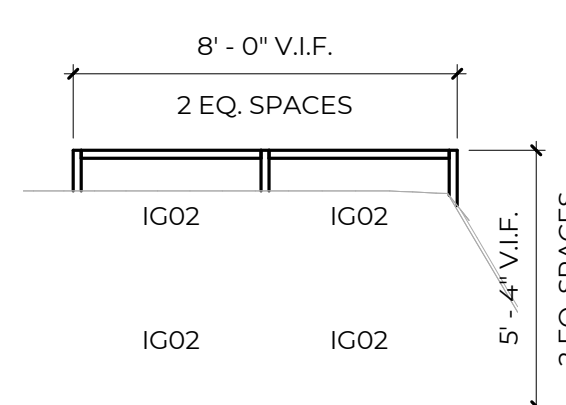


9 WINDOW BAY INTERVENTION TYPE 9
1/4" = 1'-0"

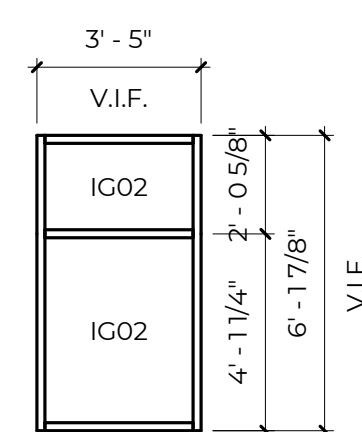


10 WINDOW BAY INTERVENTION TYPE 10
1/4" = 1'-0"

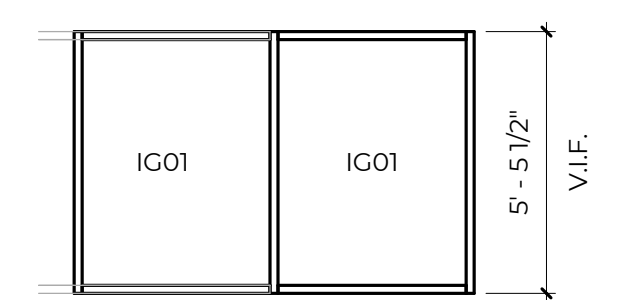


11 WINDOW BAY INTERVENTION TYPE 11
1/4" = 1'-0"

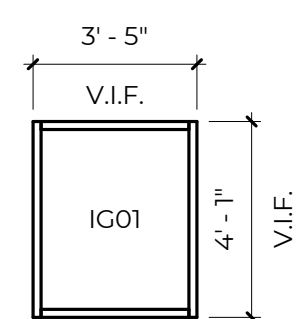


12 WINDOW BAY INTERVENTION TYPE 12
1/4" = 1'-0"

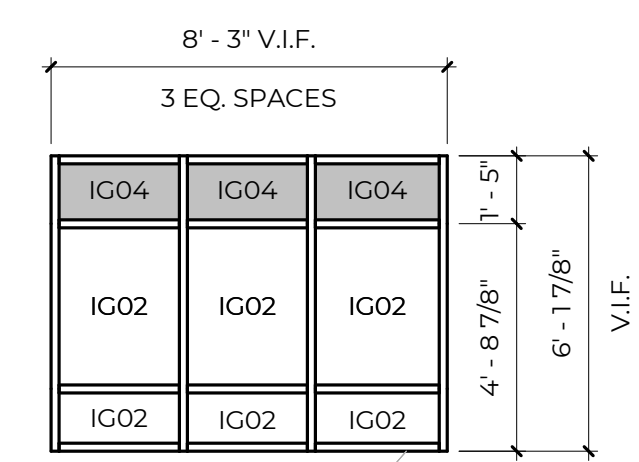

13 WINDOW BAY INTERVENTION TYPE 13
1/4" = 1'-0"

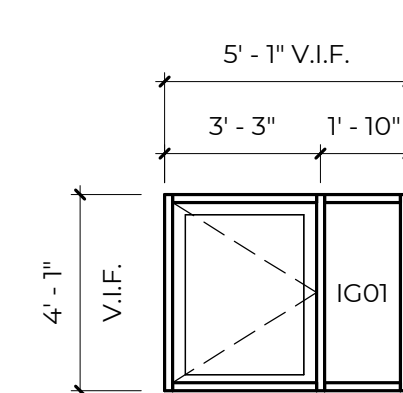


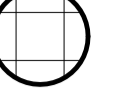
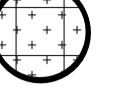
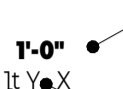


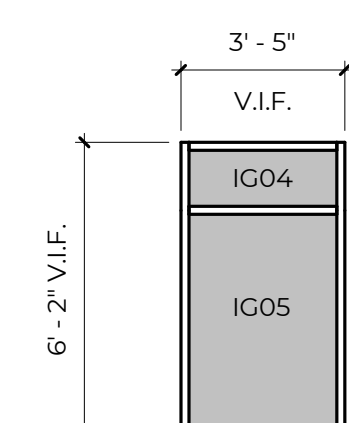14 WINDOW BAY INTERVENTION TYPE 14
1/4" = 1'-0"



15 WINDOW BAY INTERVENTION TYPE 15
1/4" = 1'-0"


MPS GLENSIDE
MUSKEGON PUBLIC SCHOOLS
1213 W Hackley Ave, Muskegon, MI 49441

LEGEND - REFLECTED CEILING


-  GYPSUM BOARD
-  ACPO1: 24" x 24" LAY-IN ACOUSTICAL TILE GRID (REFER TO MATERIAL SELECTION SCHEDULE)
-  ACPO2: 24" x 24" CLEANABLE LAY-IN ACOUSTICAL TILE GRID (REFER TO MATERIAL SELECTION SCHEDULE)
-  CEILING HEIGHT ABOVE FINISHED FLOOR
-  CEILING FINISH INSTANCE
-  CEILING FINISH TYPE

GENERAL NOTES - REFLECTED CEILINGS

1. WHERE CEILING TILE IS LESS THAN 3" AT PERIMETER OF ROOM PROVIDE A CUT 2x4 TILE IN LIEU OF FULL 2x2 TILE AND SMALL PIECE OF TILE OR DOUBLE GRID - MATCH 2x2 FOR STYLE AND COLOR.
2. AT AREAS OF EXPOSED CEILING PAINT ALL STRUCTURE, DUCTWORK, PIPING, CONDUIT, HANGERS ETC., COORDINATE WITH MECHANICAL, ELECTRICAL AND PLUMBING SPECIFICATIONS. REFER TO THE REFLECTED CEILING PLANS FOR PAINT COLORS.

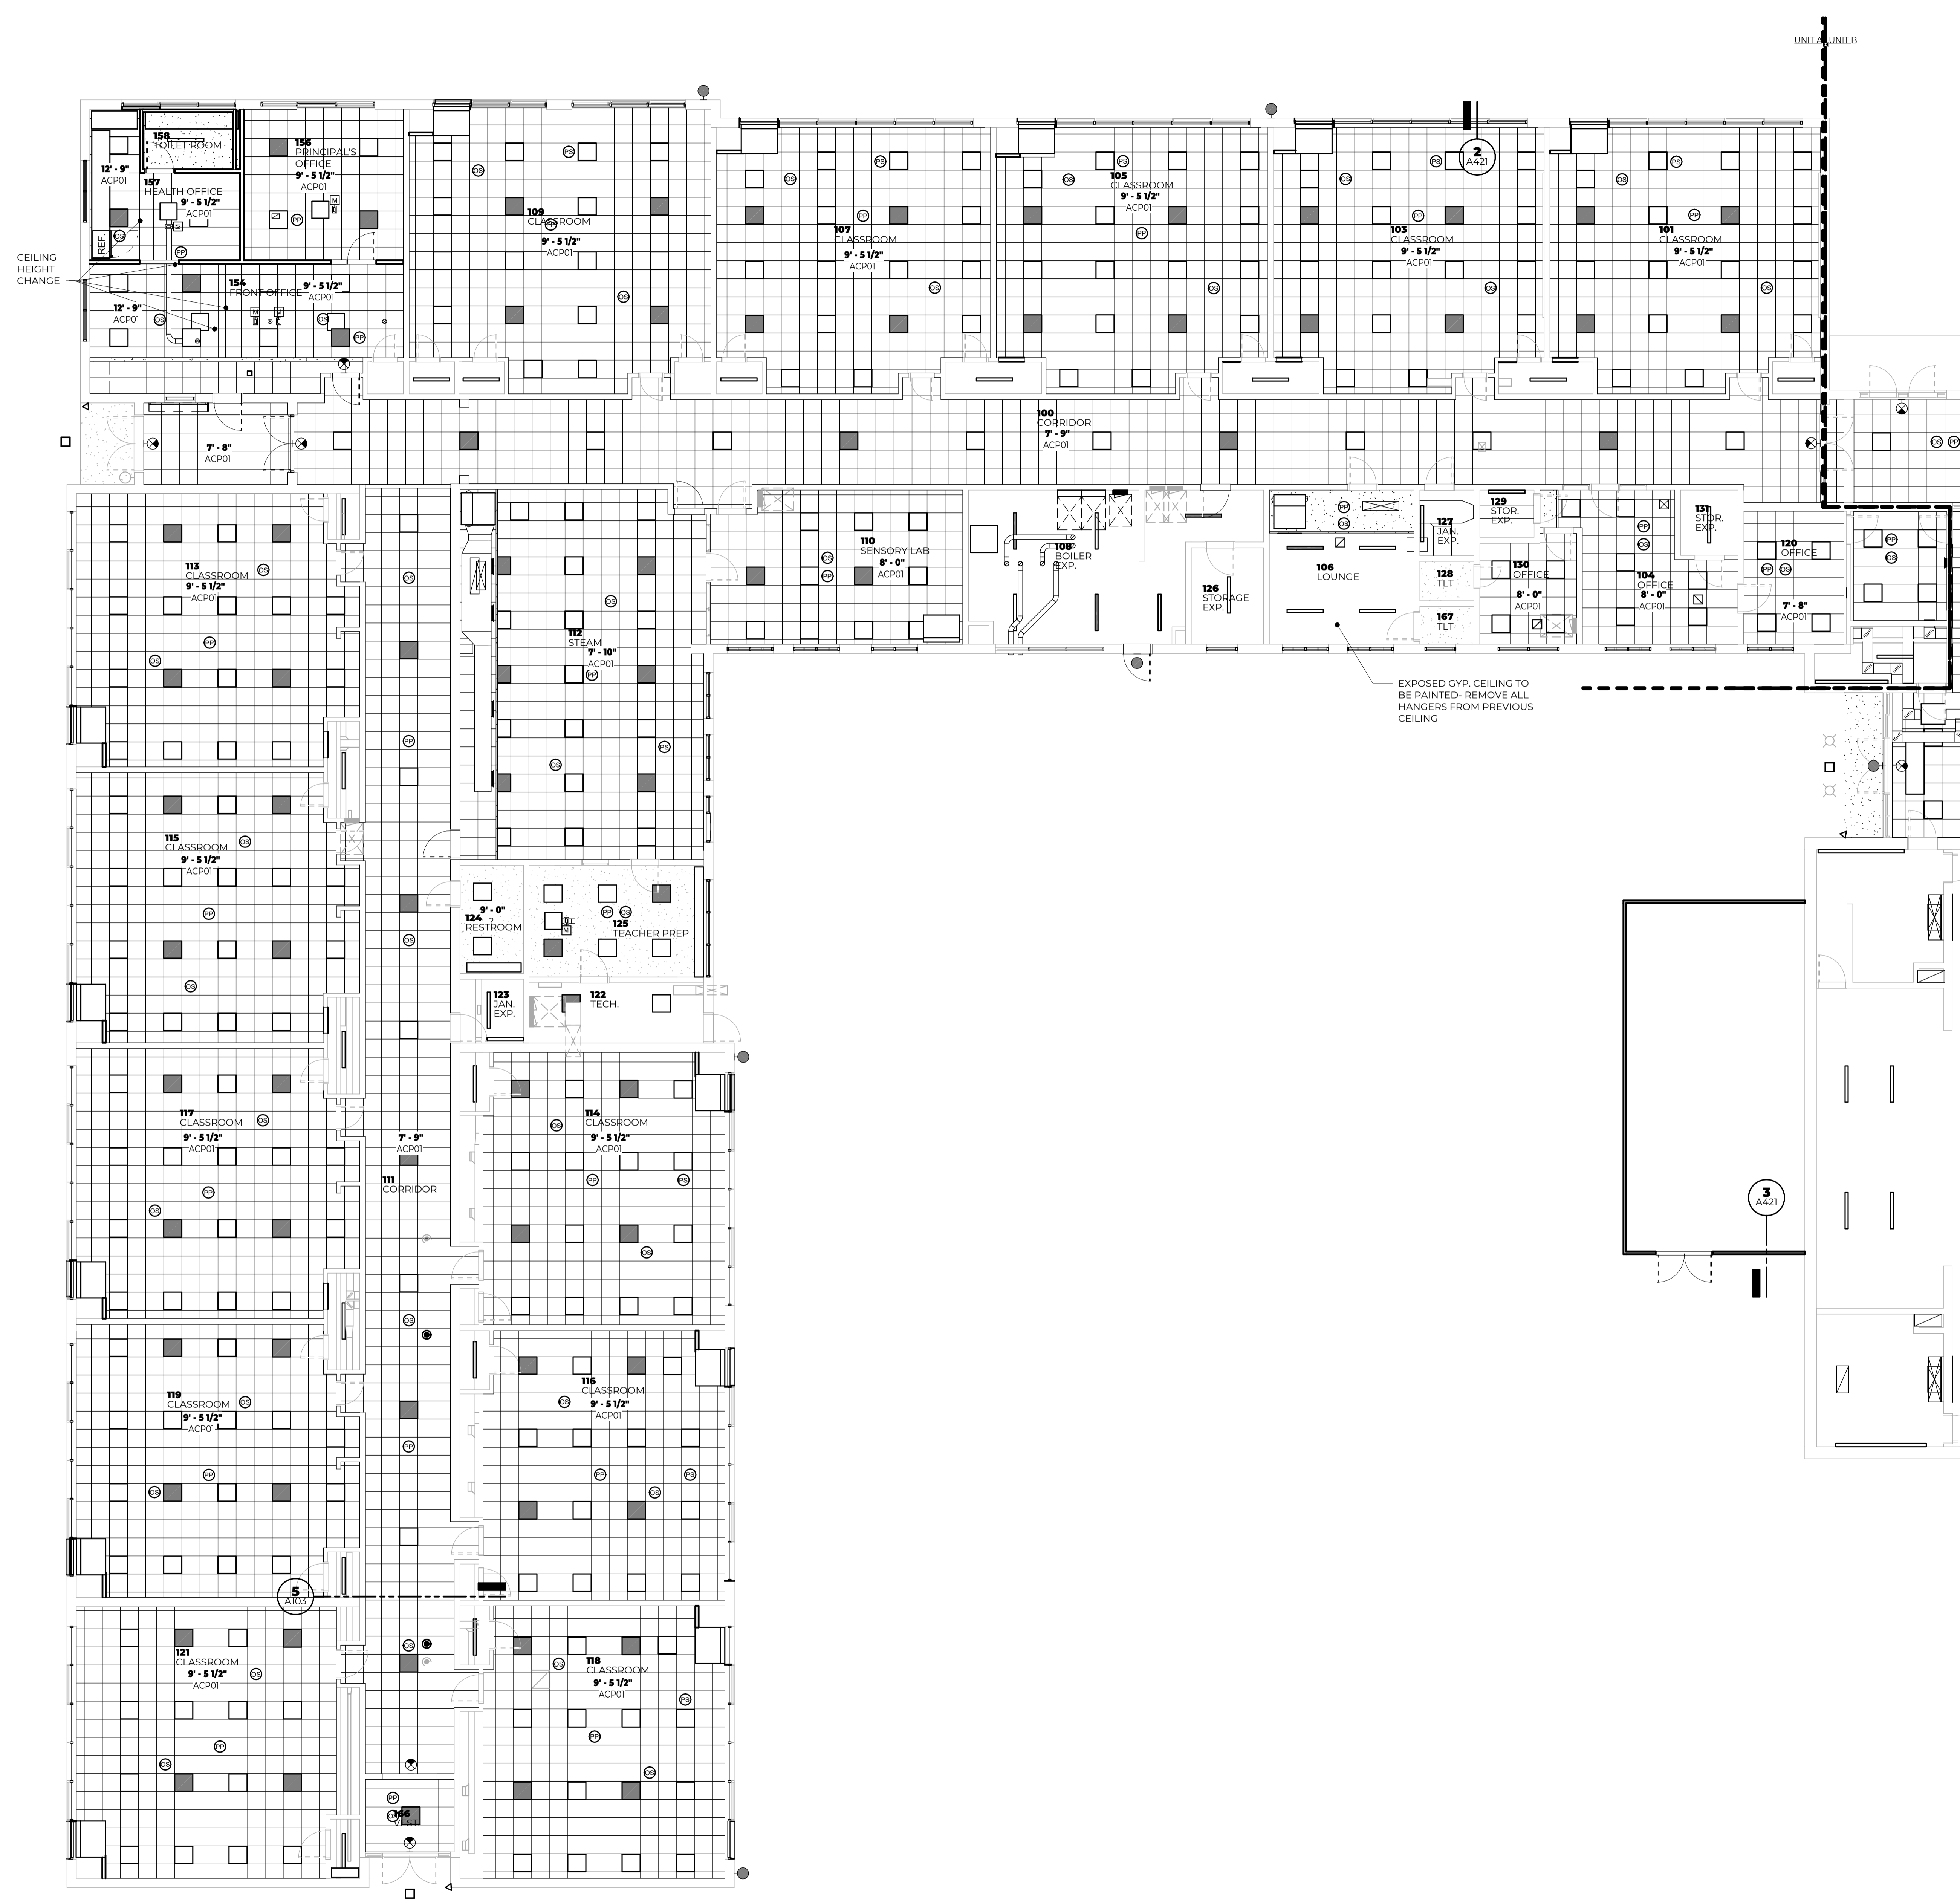

EXPOSED GYP. CEILING TO BE PAINTED- REMOVE ALL HANGERS FROM PREVIOUS CEILING

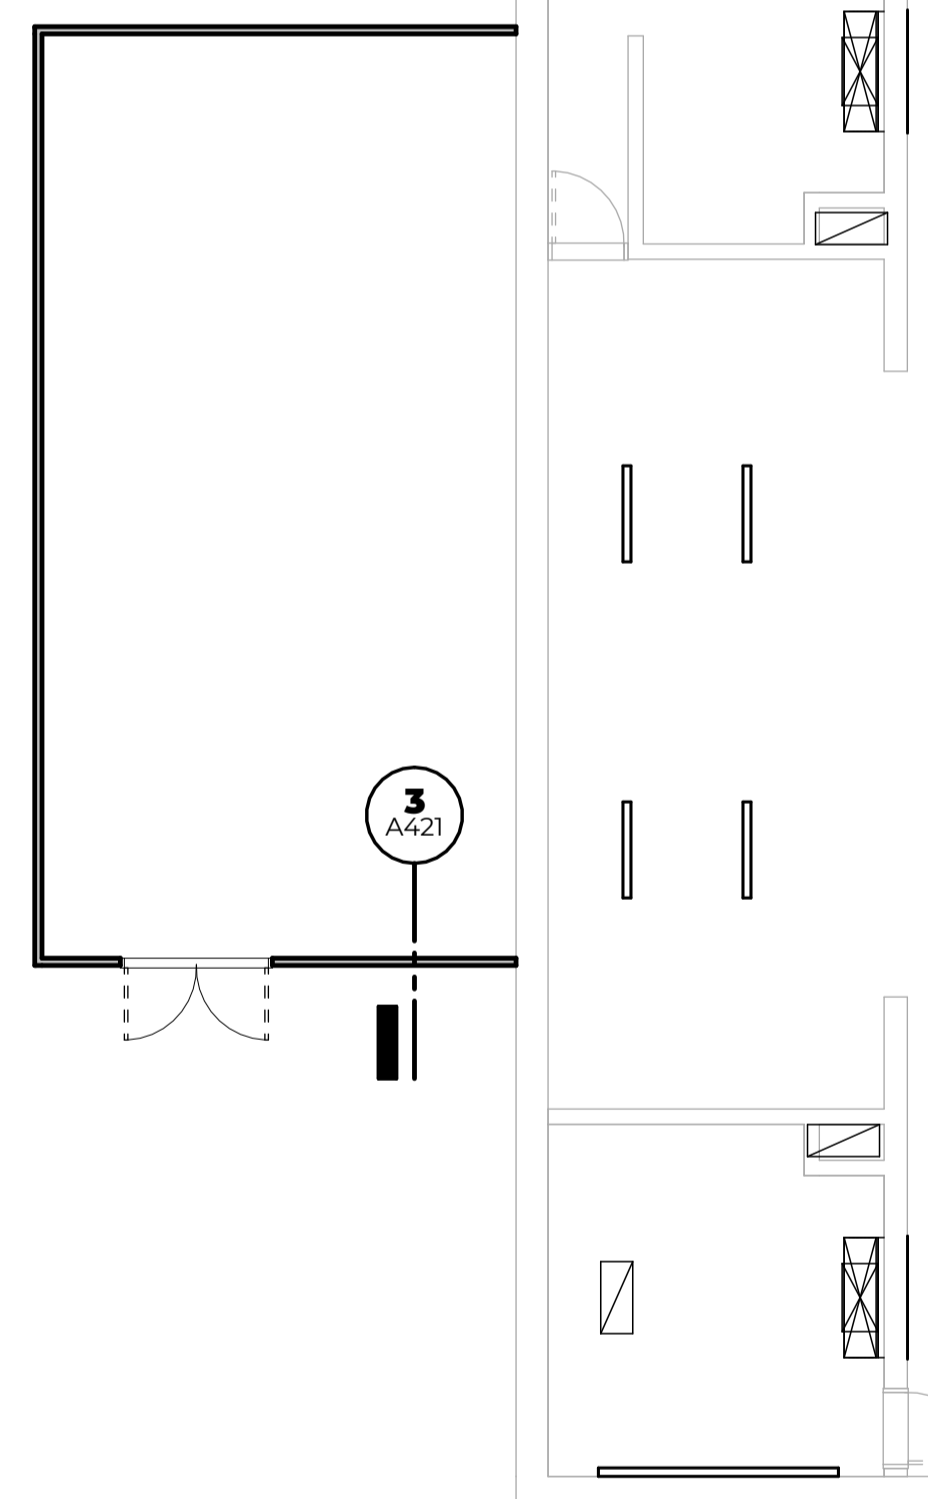

KEY PLAN

NR 14 FIRST FLOOR REFLECTED CEILING PLAN
1/8" = 1'-0"

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MUSKEGON PUBLIC SCHOOLS
1213 W Hackley Ave, Muskegon, MI 49441

REVISIONS

SYM DATE ISSUED FOR

ISSUE DATE
03.08.2024

SHEET NAME
FIRST FLOOR REFLECTED CEILING PLAN - UNIT A

SHEET NUMBER


A201A

LEGEND


REFLECTED CEILING LEGEND

- GYPSUM BOARD
- ACP01 24" x 24" LAY-IN ACOUSTICAL TILE GRID (REFER TO MATERIAL SELECTION SCHEDULE)
- ACP02 24" x 24" CLEANABLE LAY-IN ACOUSTICAL TILE GRID (REFER TO MATERIAL SELECTION SCHEDULE)
- CEILING HEIGHT ABOVE FINISHED FLOOR
- CEILING FINISH INSTANCE
- CEILING FINISH TYPE

- GENERAL NOTES - REFLECTED CEILING**
- WHERE CEILING TILE IS LESS THAN 3" AT PERIMETER OF ROOM PROVIDE A CUT 2x4 TILE IN LIEU OF FULL 2x2 TILE AND SMALL PIECE OF TILE OR DOUBLE GRID - MATCH 2x2 FOR STYLE AND COLOR.
 - AT AREAS OF EXPOSED CEILING PAINT ALL STRUCTURE, DUCTWORK, PIPING, CONDUIT, HANGERS ETC. COORDINATE WITH MECHANICAL, ELECTRICAL AND PLUMBING SPECIFICATIONS. REFER TO THE REFLECTED CEILING PLANS FOR PAINT COLORS.

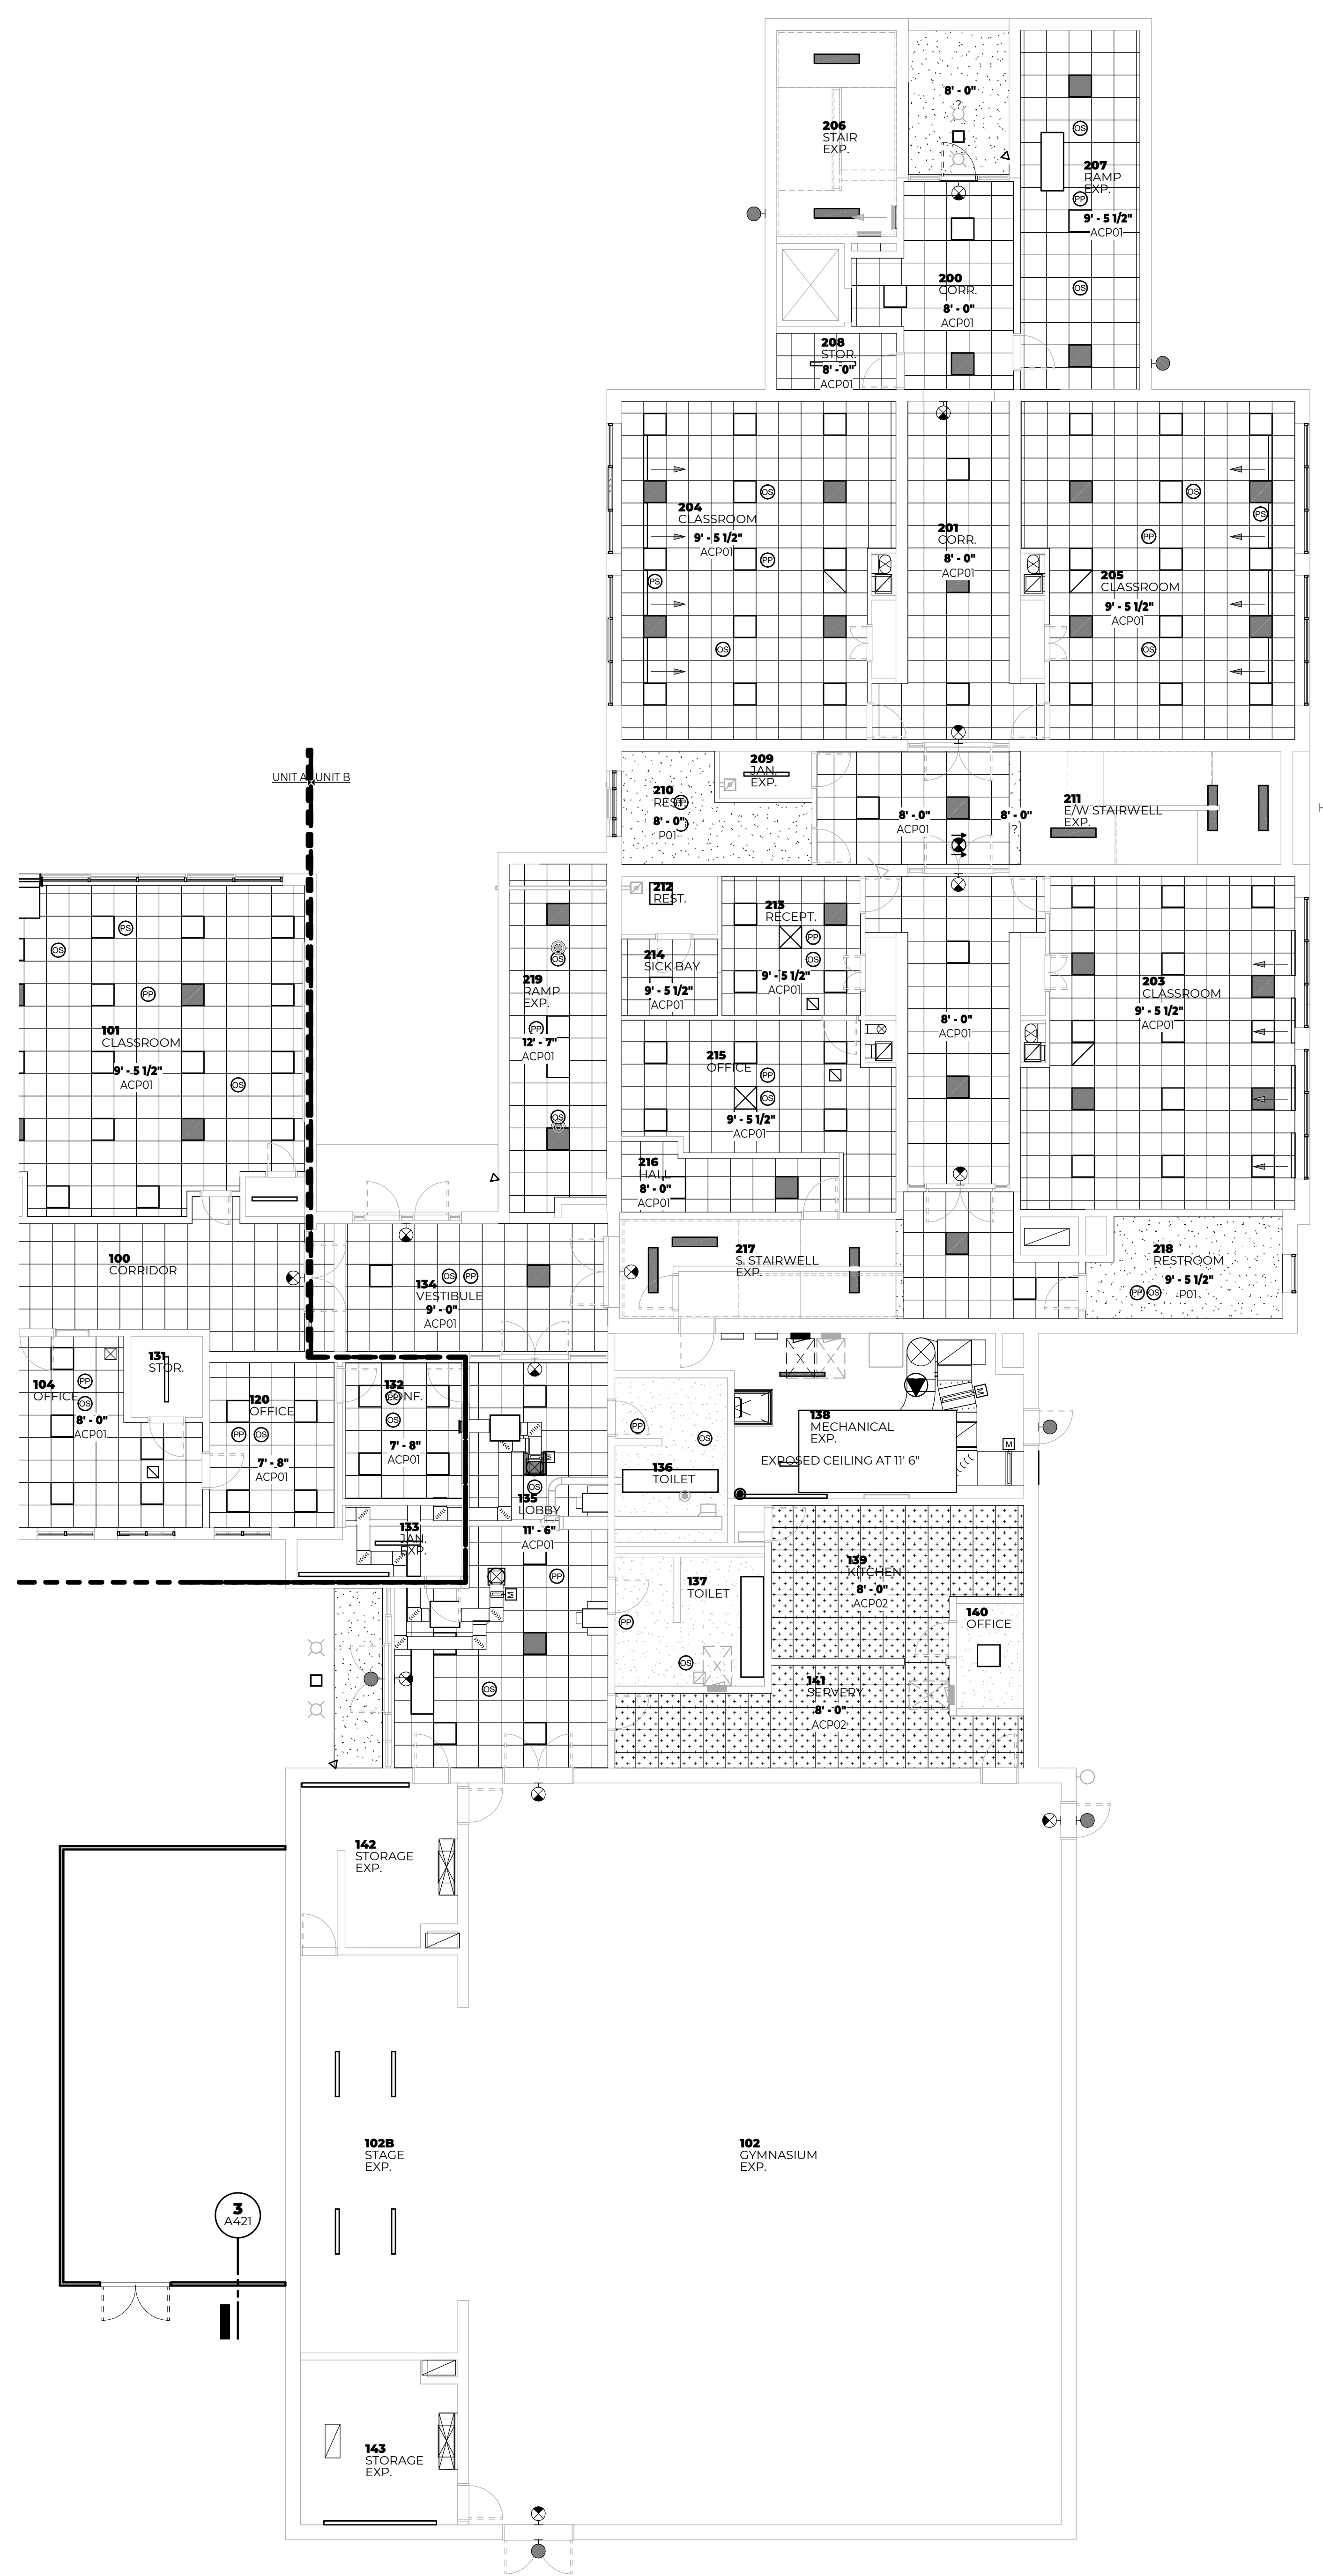


NR TH FIRST FLOOR REFLECTED CEILING PLAN - UNIT B
1/8" = 1'-0"

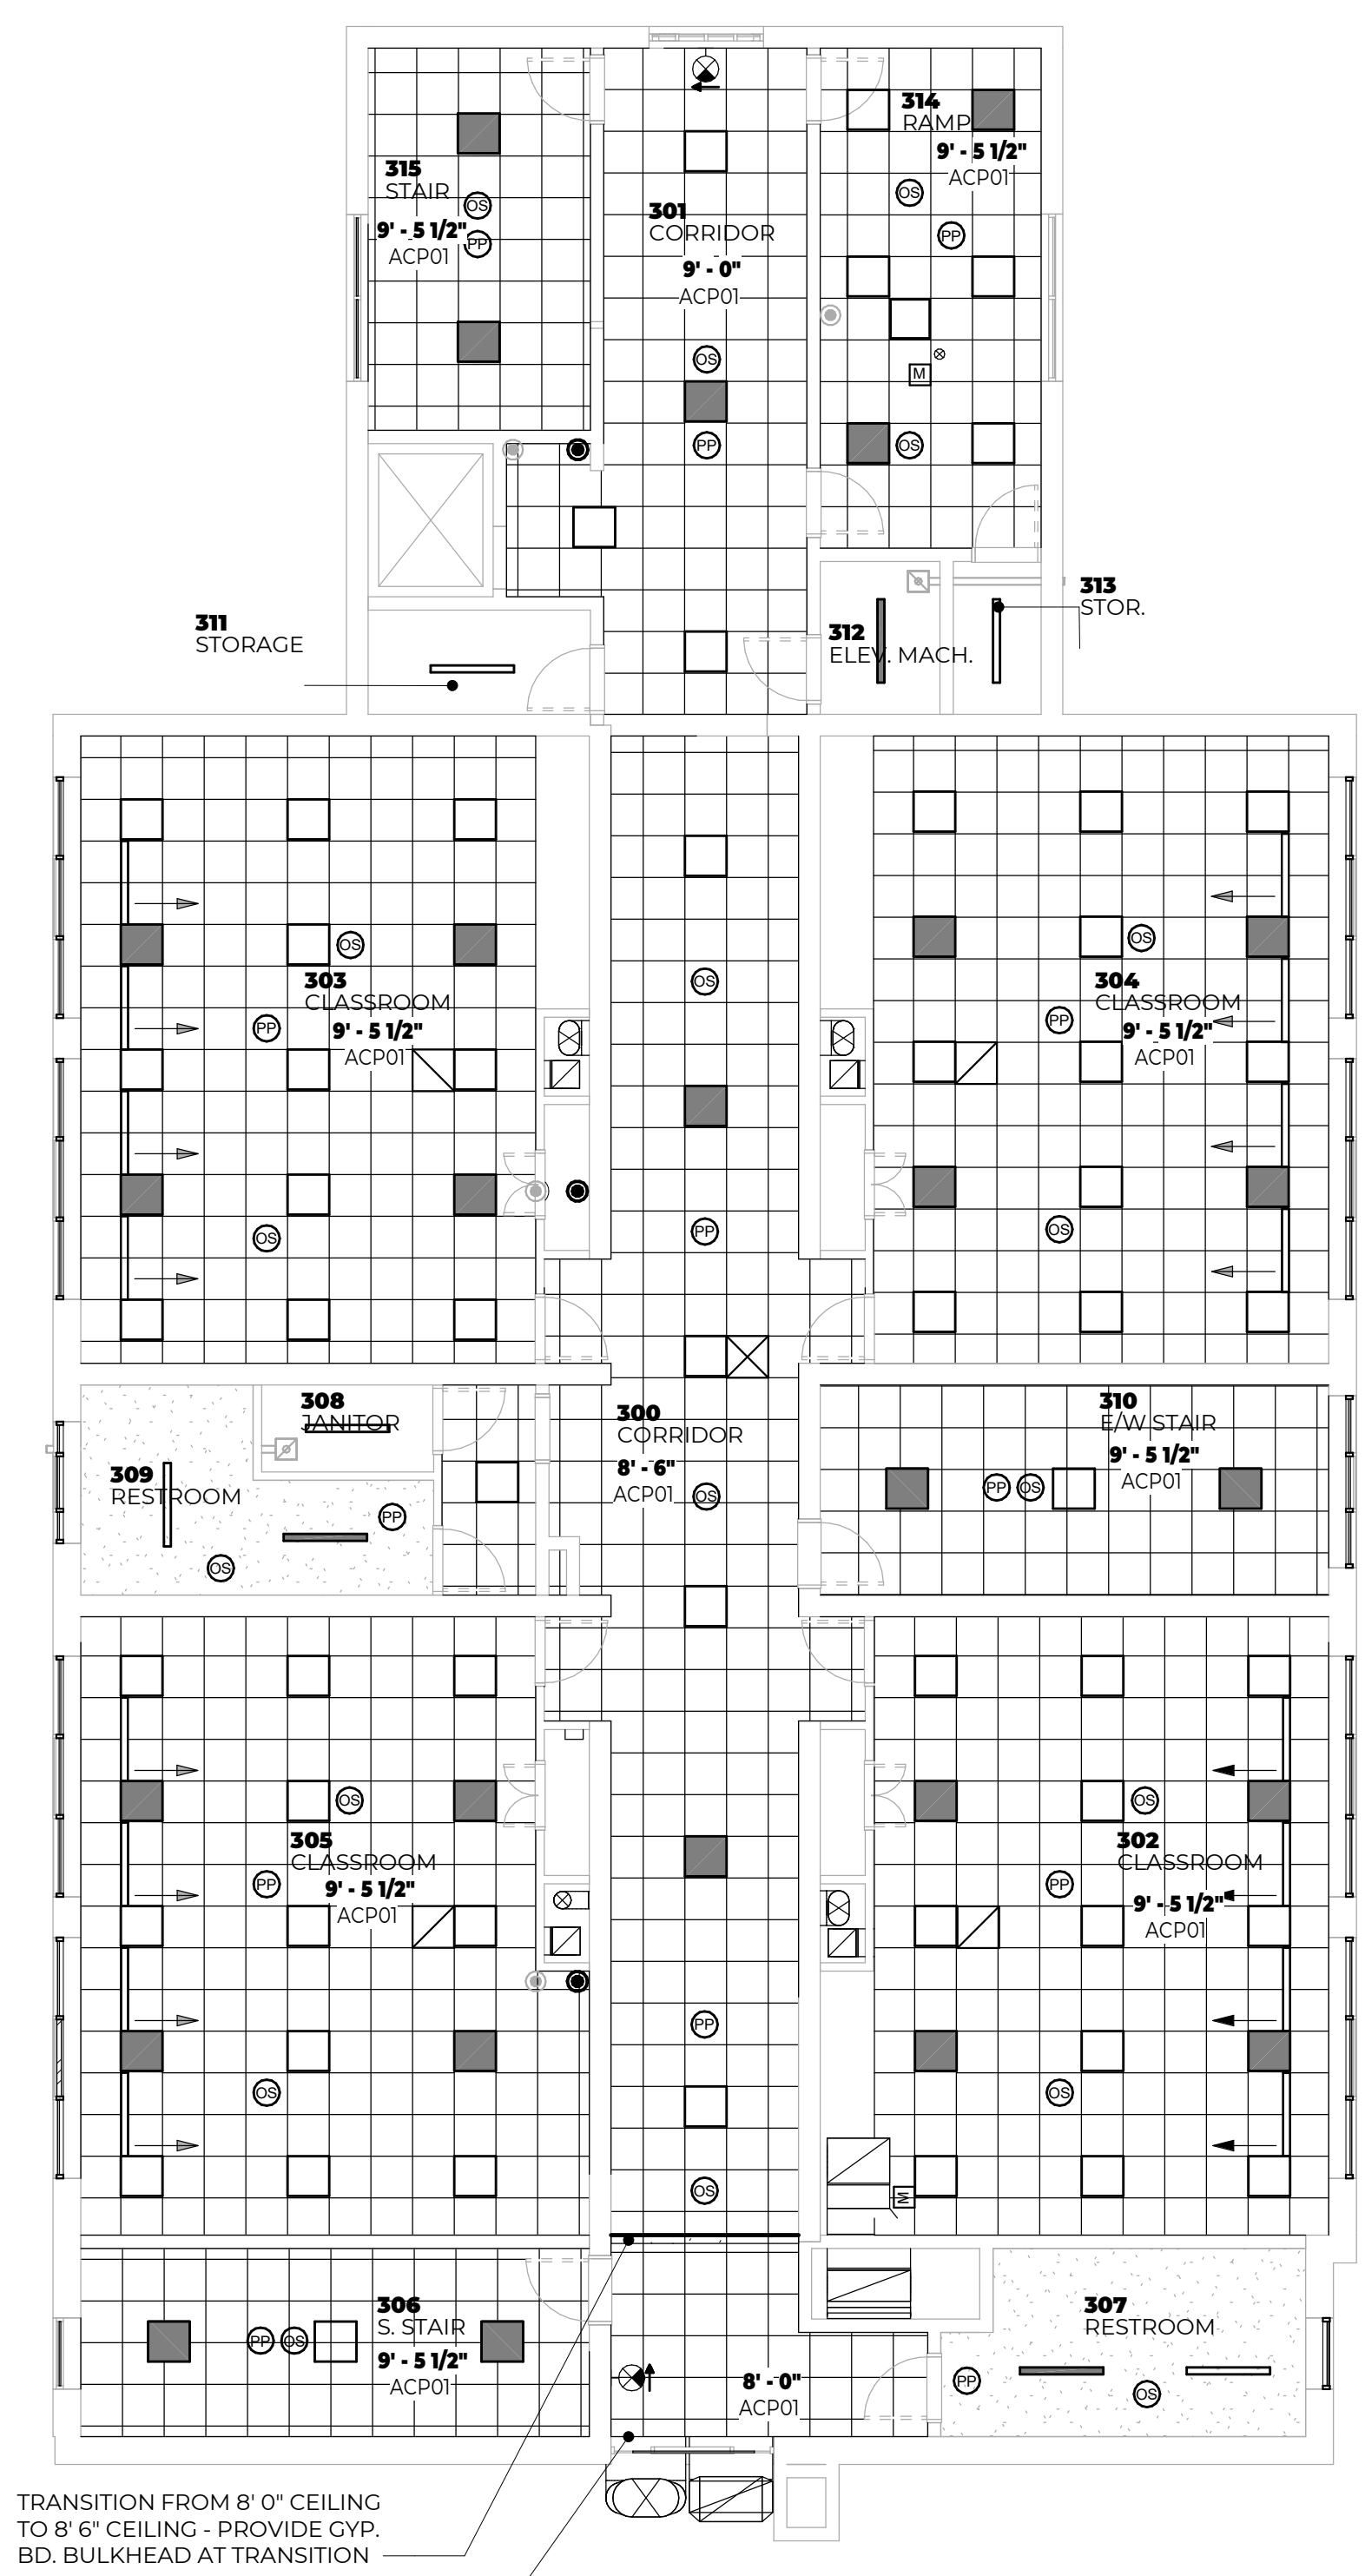

NR TH SECOND FLOOR REFLECTED CEILING PLAN
1/8" = 1'-0"

TRANSITION FROM 8' 0" CEILING TO 8' 6" CEILING - PROVIDE GYP. BD. BULKHEAD AT TRANSITION
GYP. ON METAL STUD INFILL AT THE WINDOW OPENING AROUND DUCTWORK PENETRATIONS

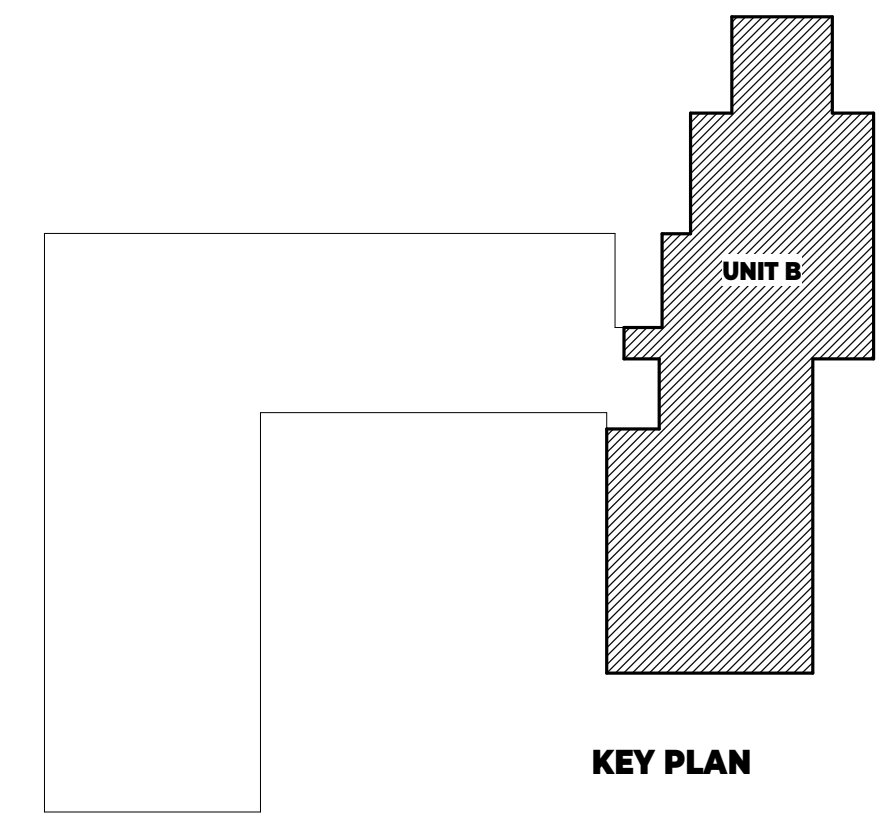

KEY PLAN

MPS GLENSIDE
MUSKEGON PUBLIC SCHOOLS
1213 W Hackley Ave, Muskegon, MI 49441

REVISIONS

| SYM | DATE | ISSUED FOR |
|-----|------------|------------|
| | 03.08.2024 | |

SHEET NAME
1ST AND 2ND FLOOR REFLECTED CEILING PLAN - UNIT B

SHEET NUMBER
A201B

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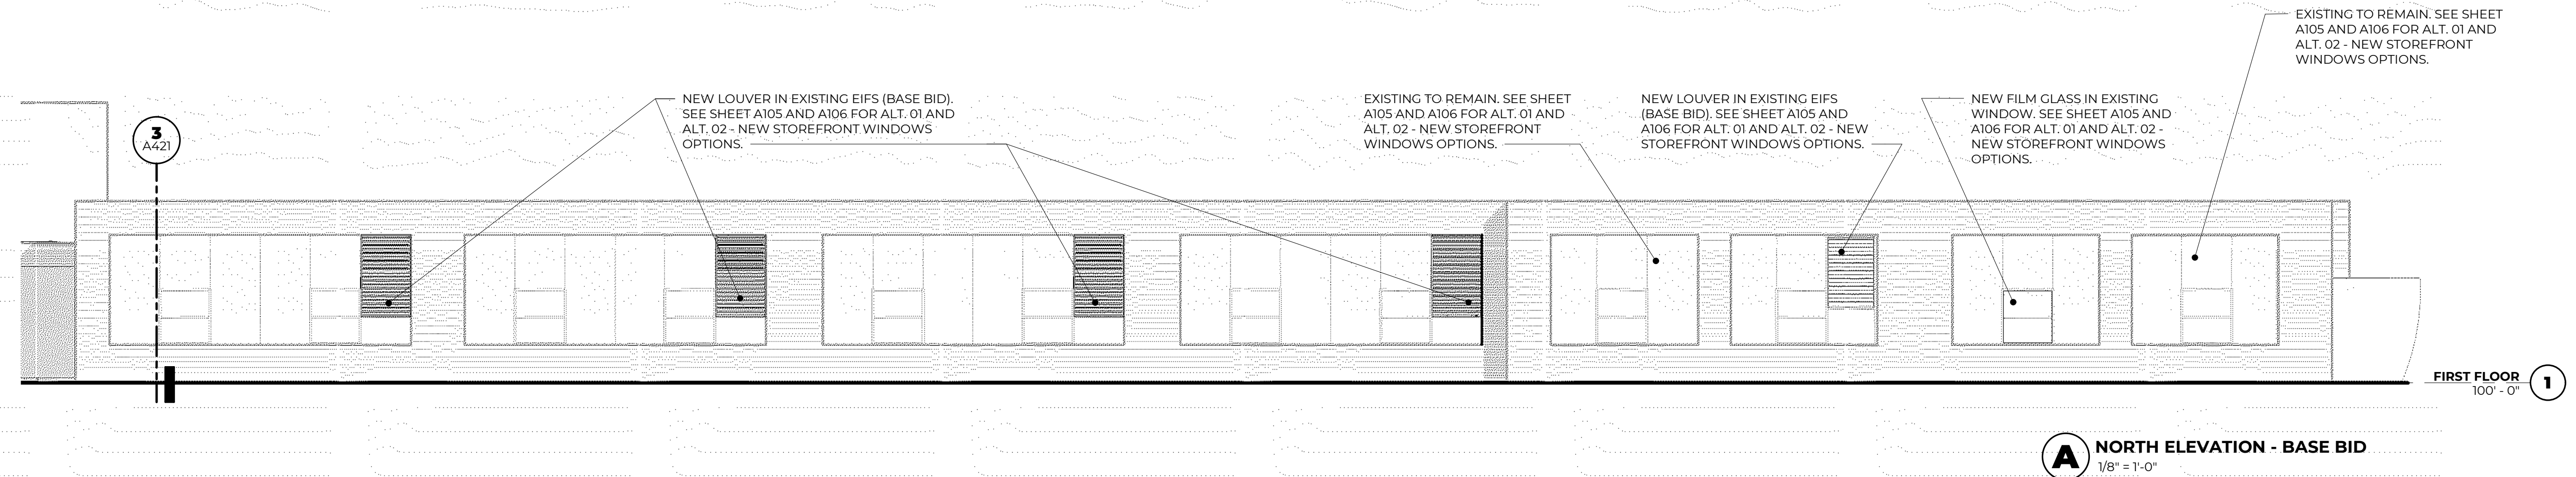
LEGEND EXTERIOR ELEVATION LEGEND

BRICK 1, COLOR:


CJ = CONTROL JOINT, COLOR:

EJ = BUILDING EXPANSION JOINT, COLOR:


SG = SPANDREL GLASS, COLOR:



A NORTH ELEVATION - BASE BID
1/8" = 1'-0"

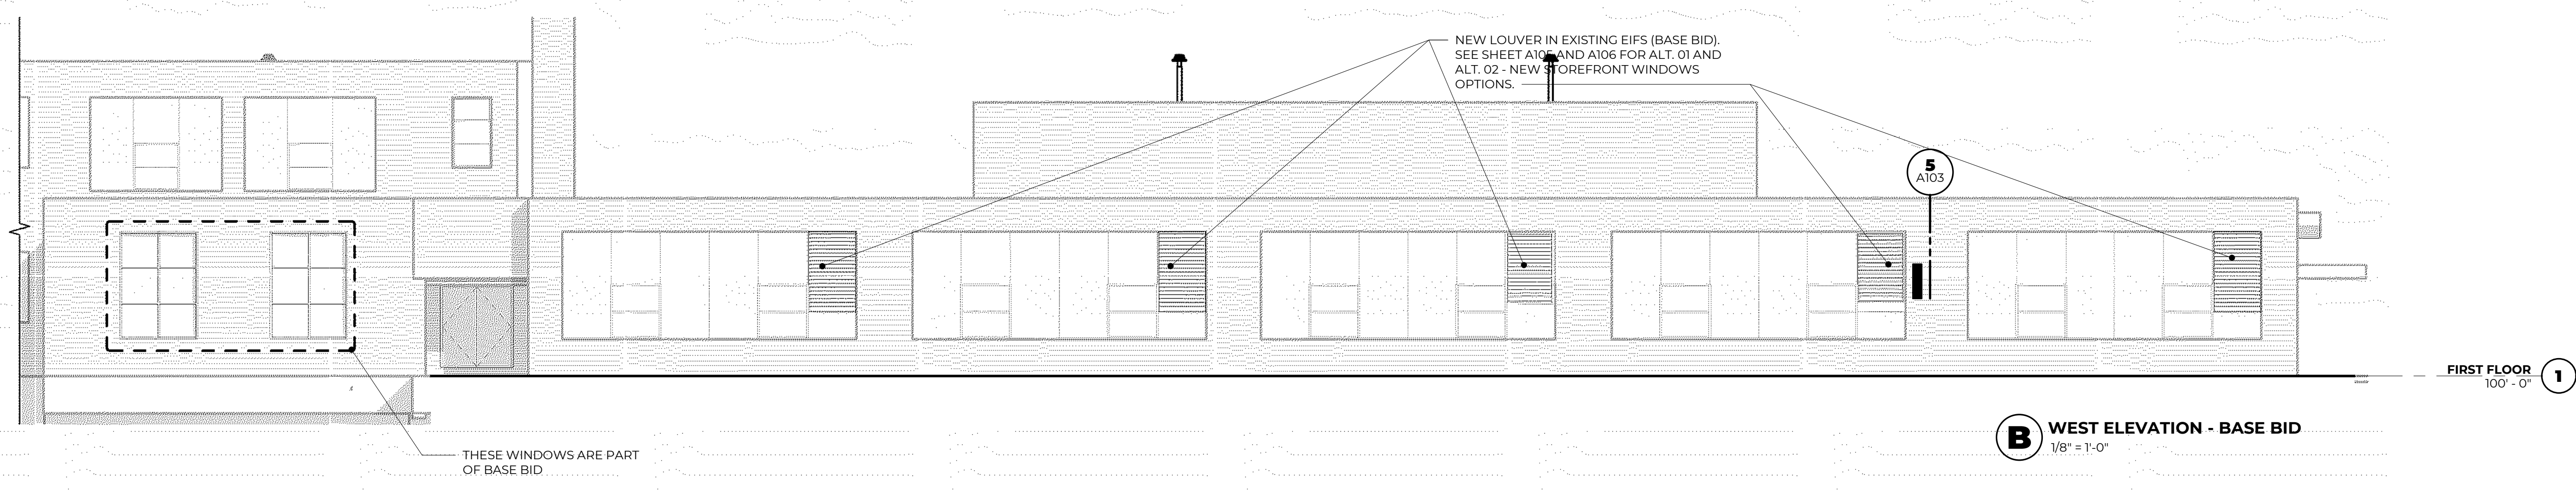

B WEST ELEVATION - BASE BID
1/8" = 1'-0"

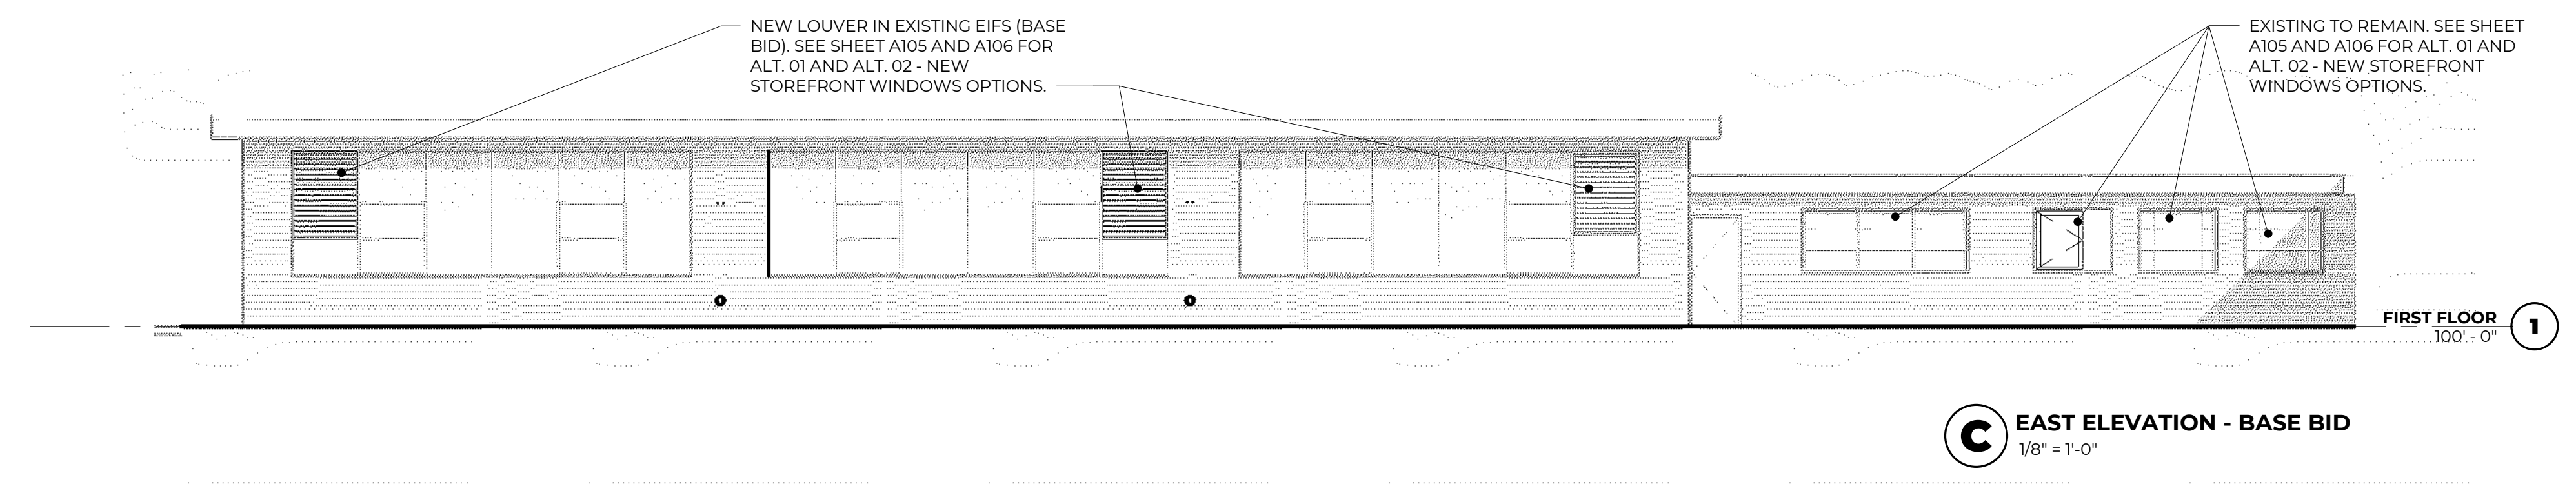

C EAST ELEVATION - BASE BID
1/8" = 1'-0"

MPS GLENESIDE
MUSKEGON PUBLIC SCHOOLS
1213 W Hackley Ave, Muskegon, MI 49441

REVISIONS

| SYM | DATE | ISSUED FOR |
|-----|------------|------------|
| | 03.08.2024 | |

ISSUE DATE

SHEET NAME

BUILDING ELEVATIONS - BASE BID

SHEET NUMBER

A301

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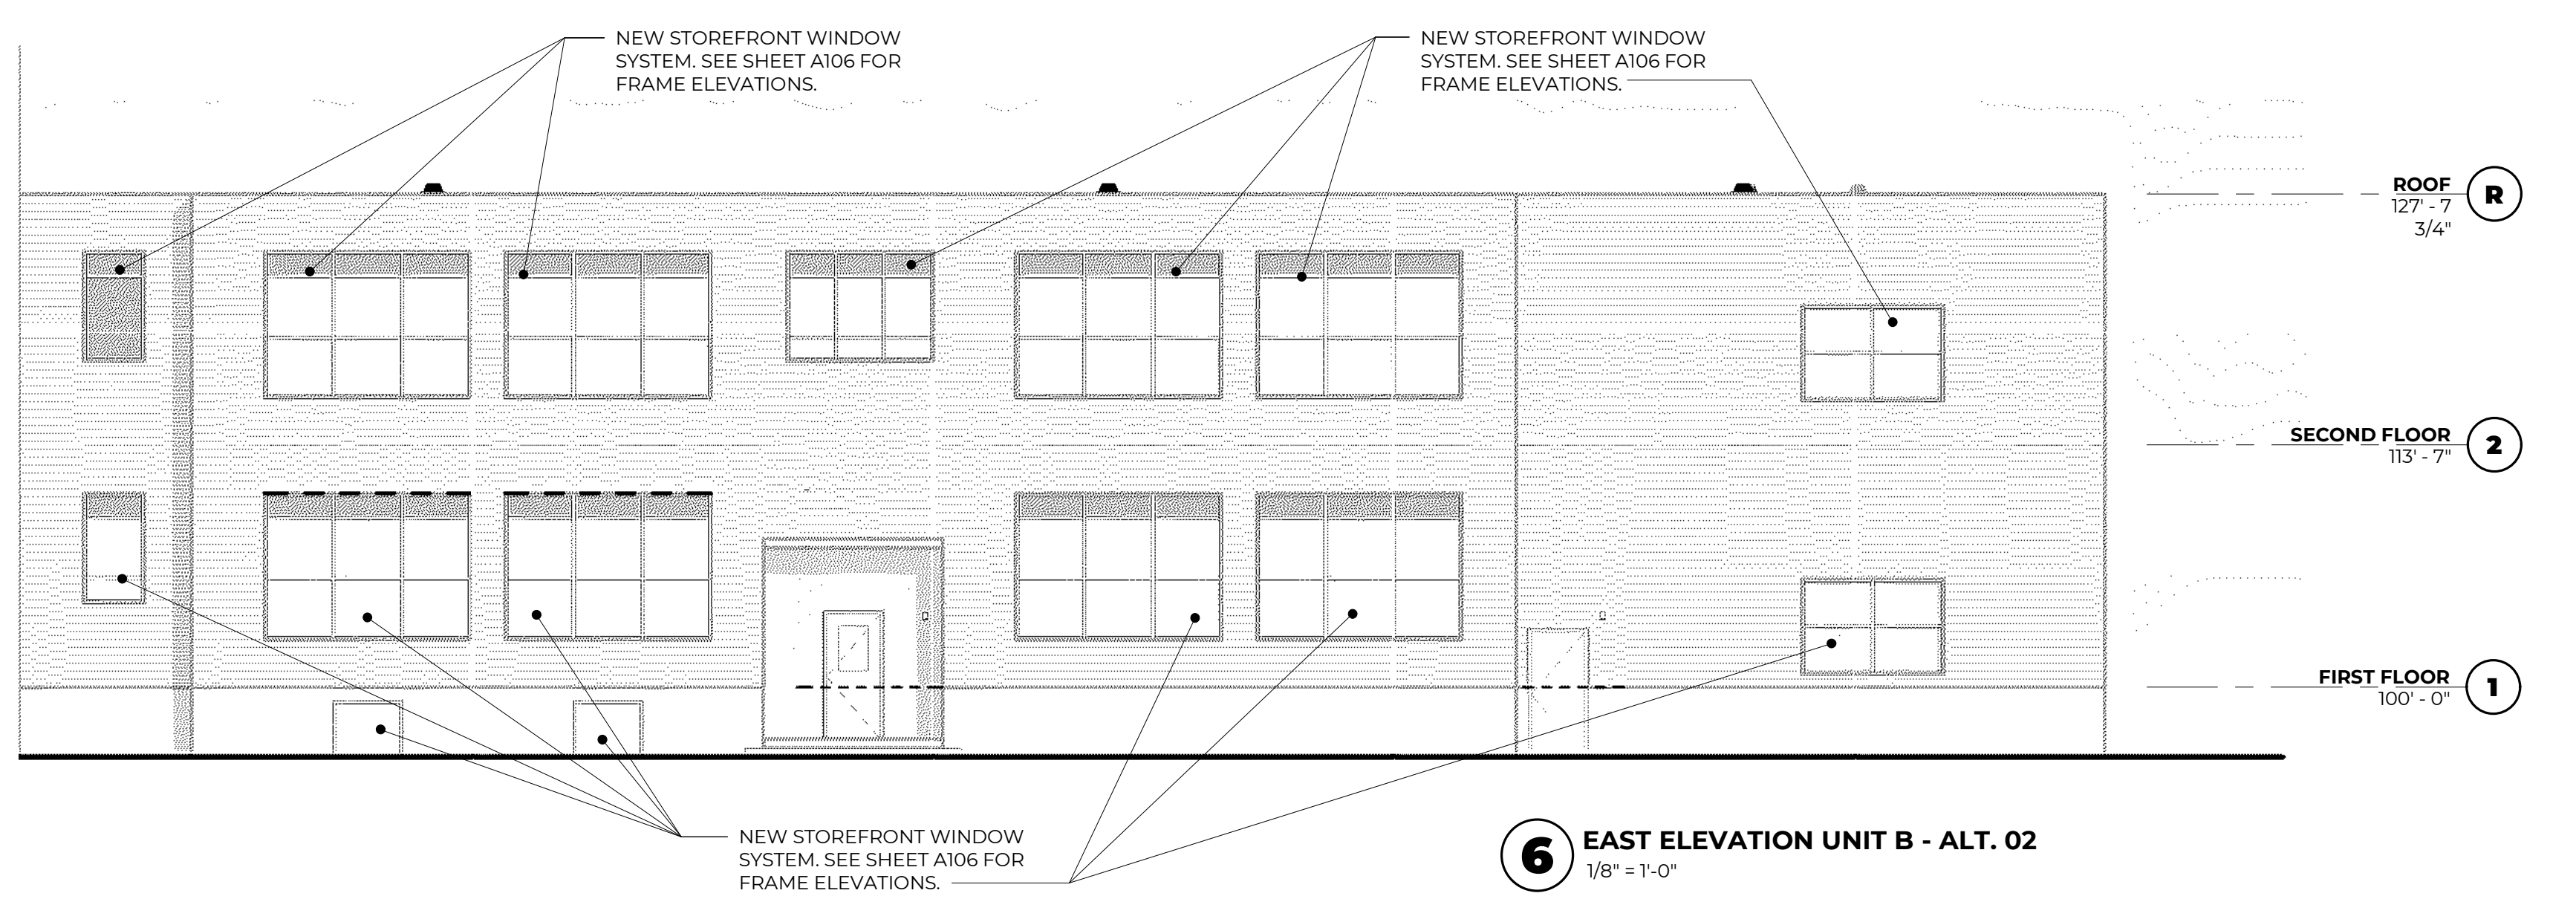
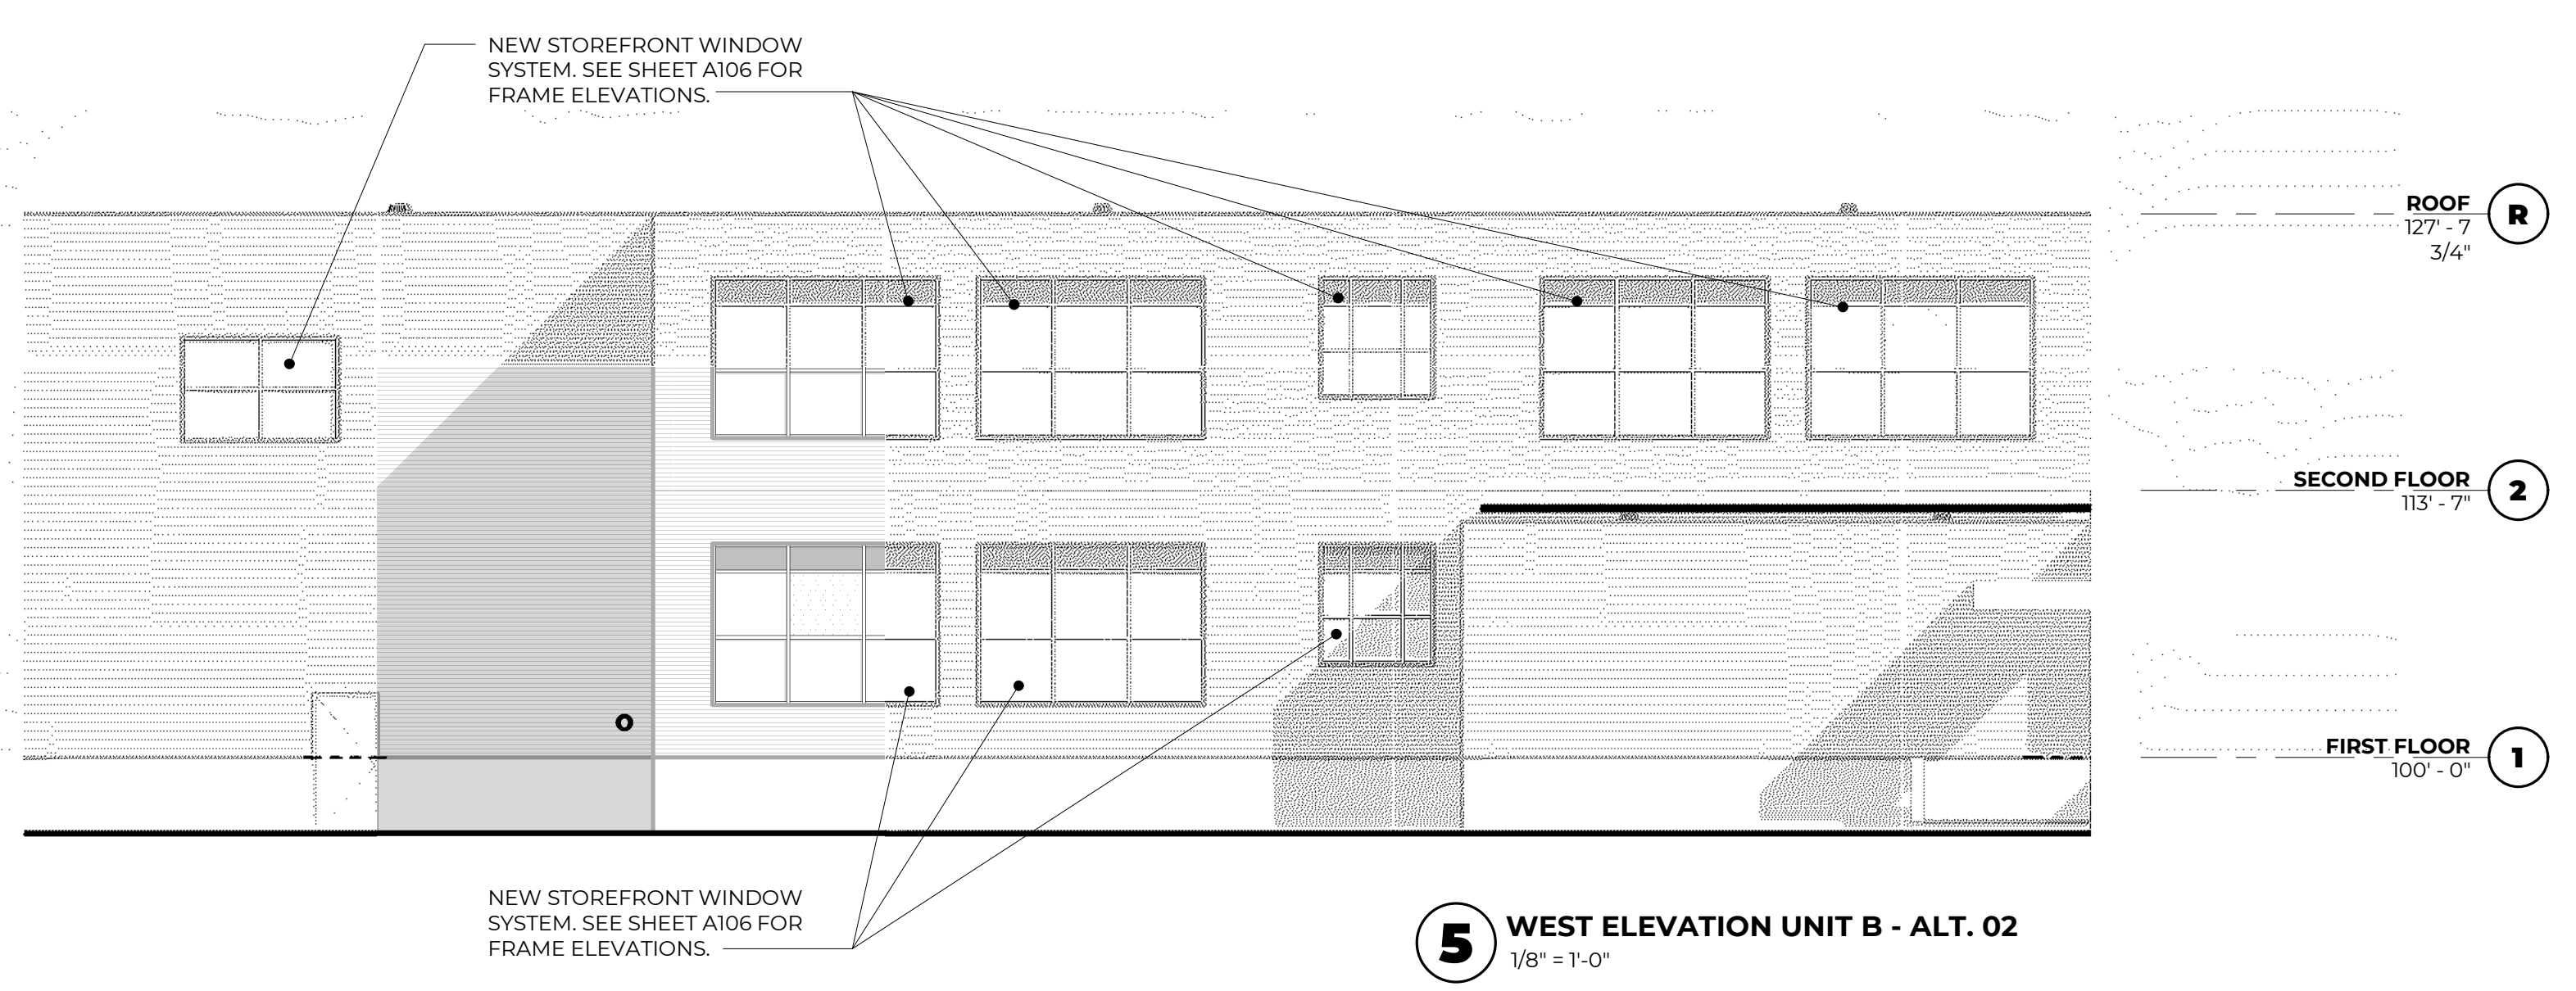
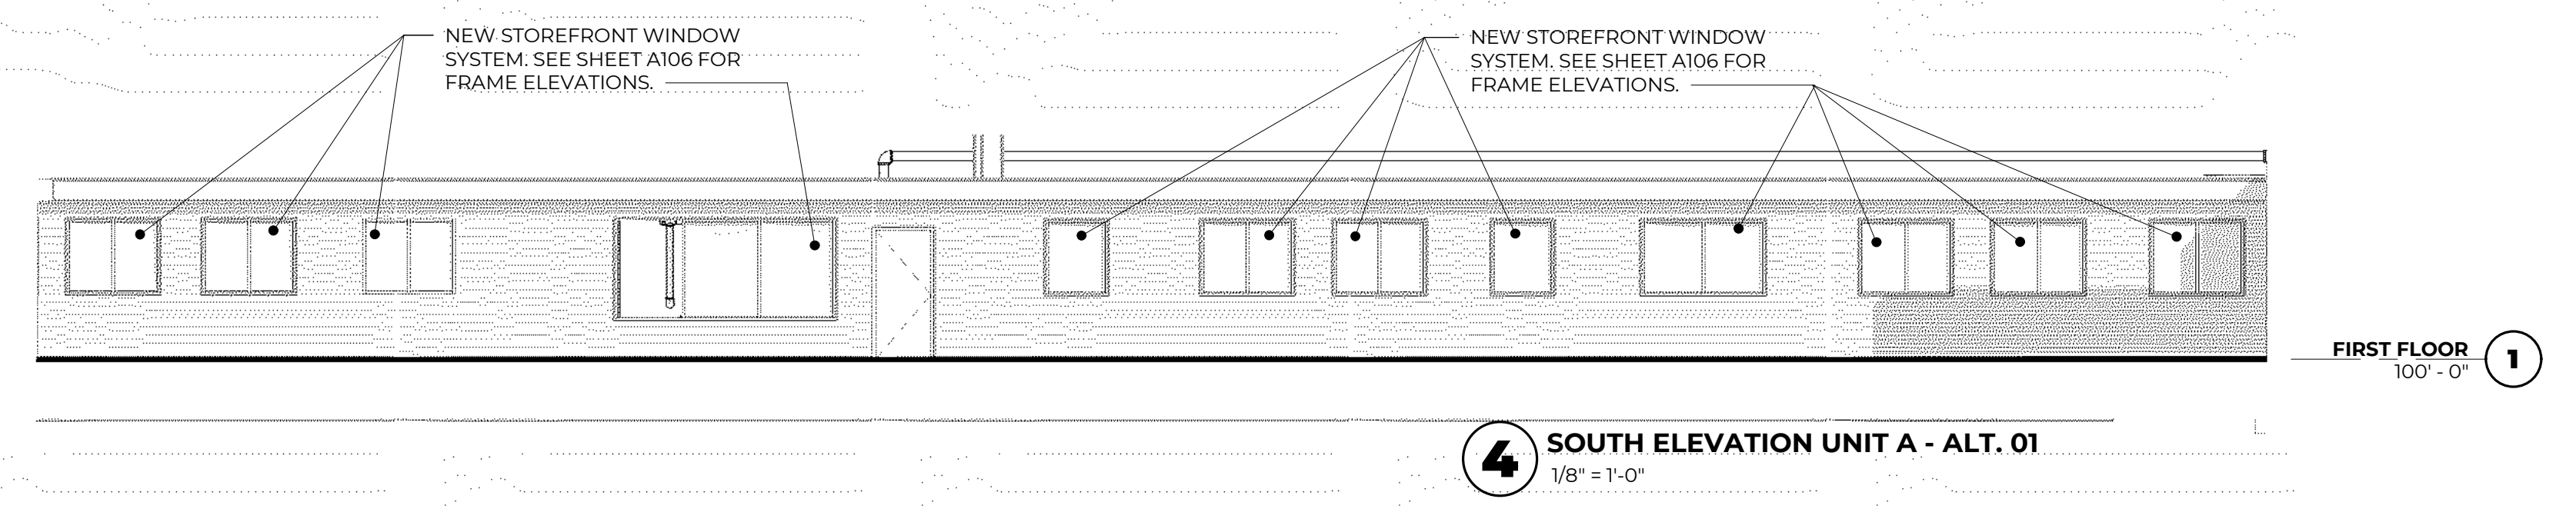
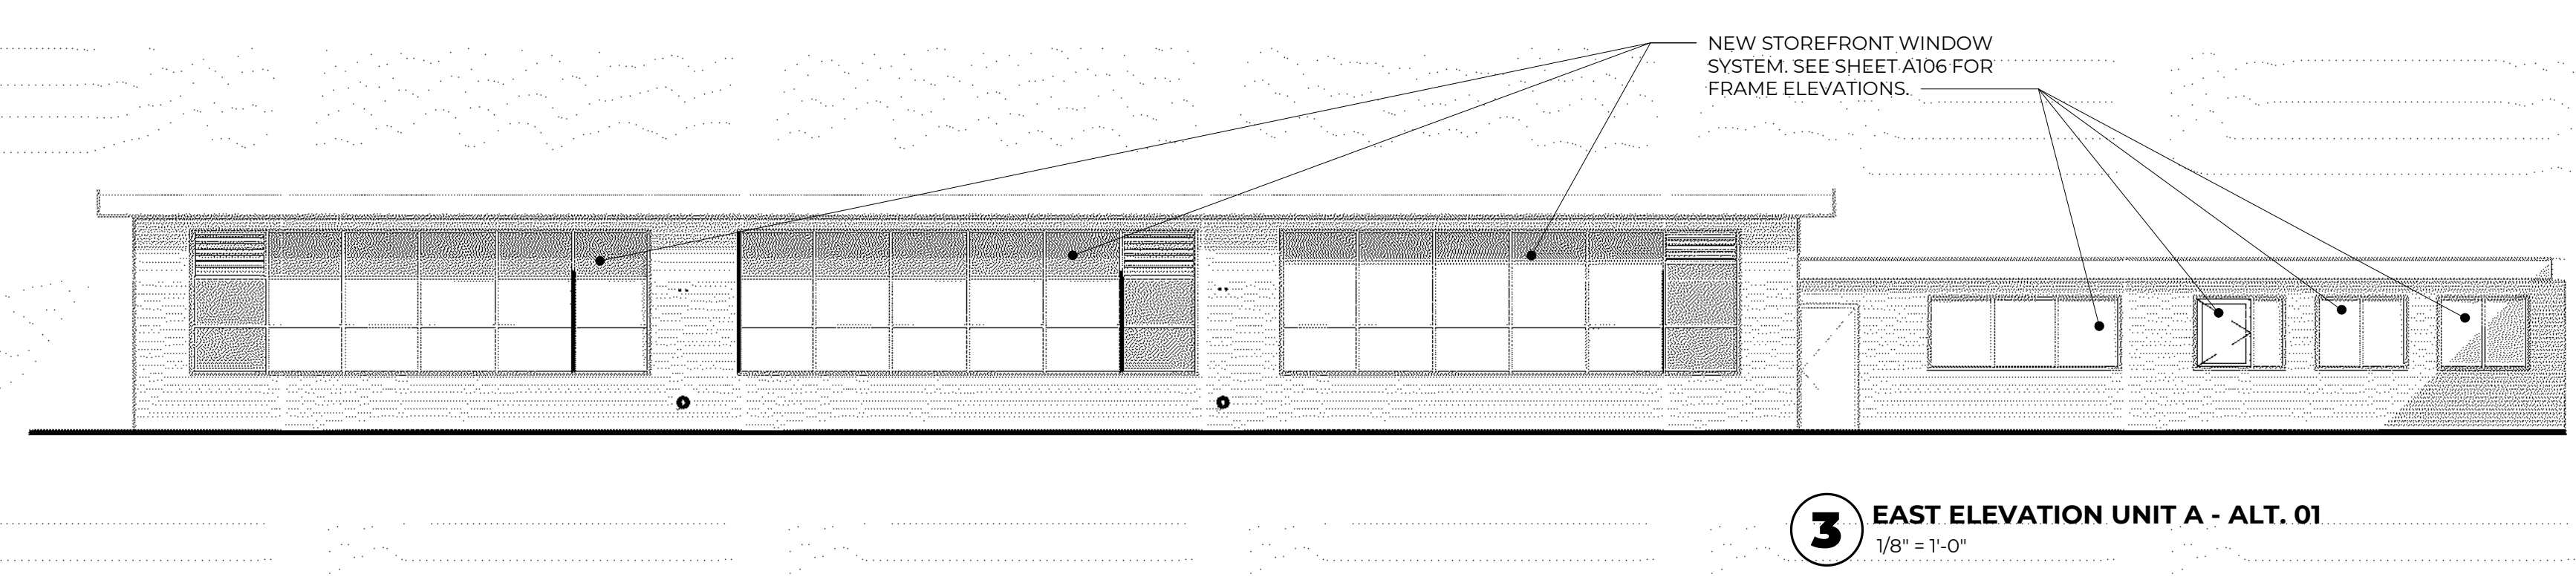
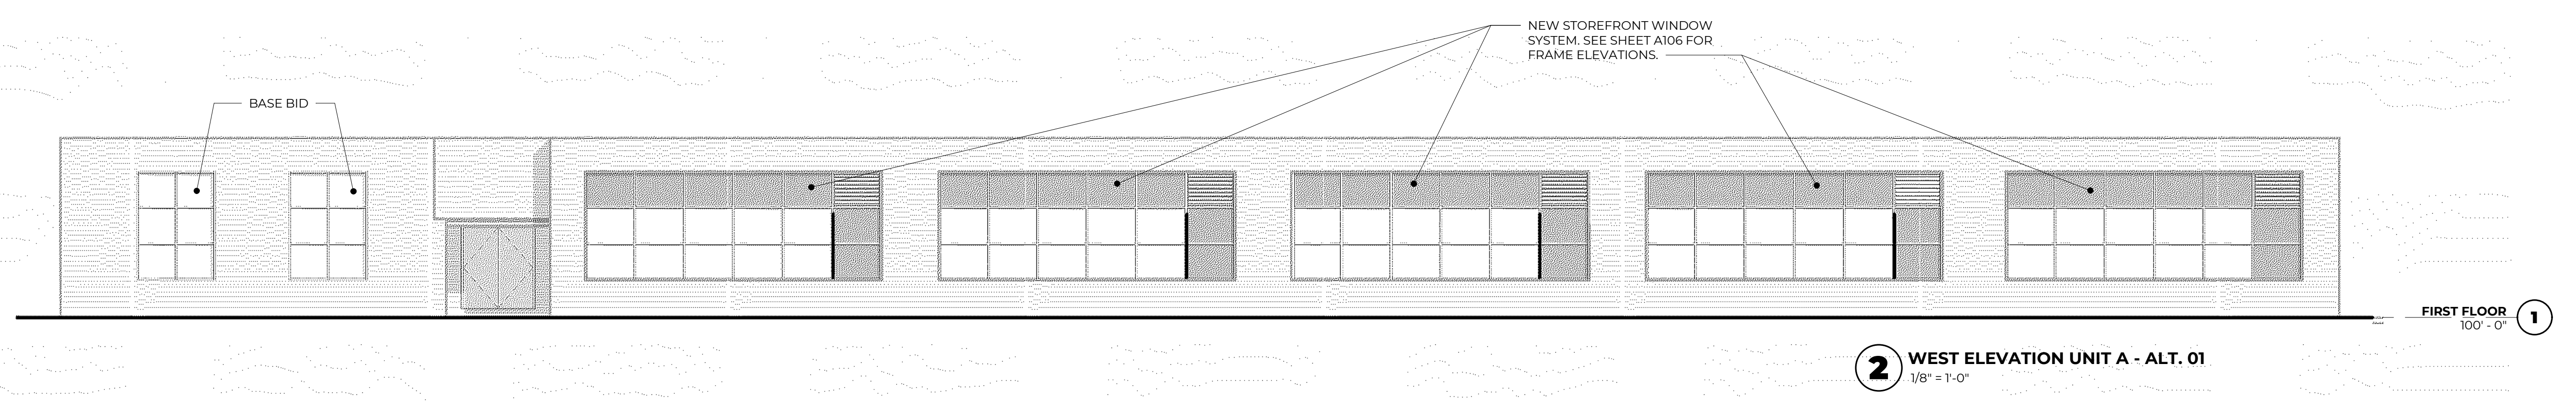
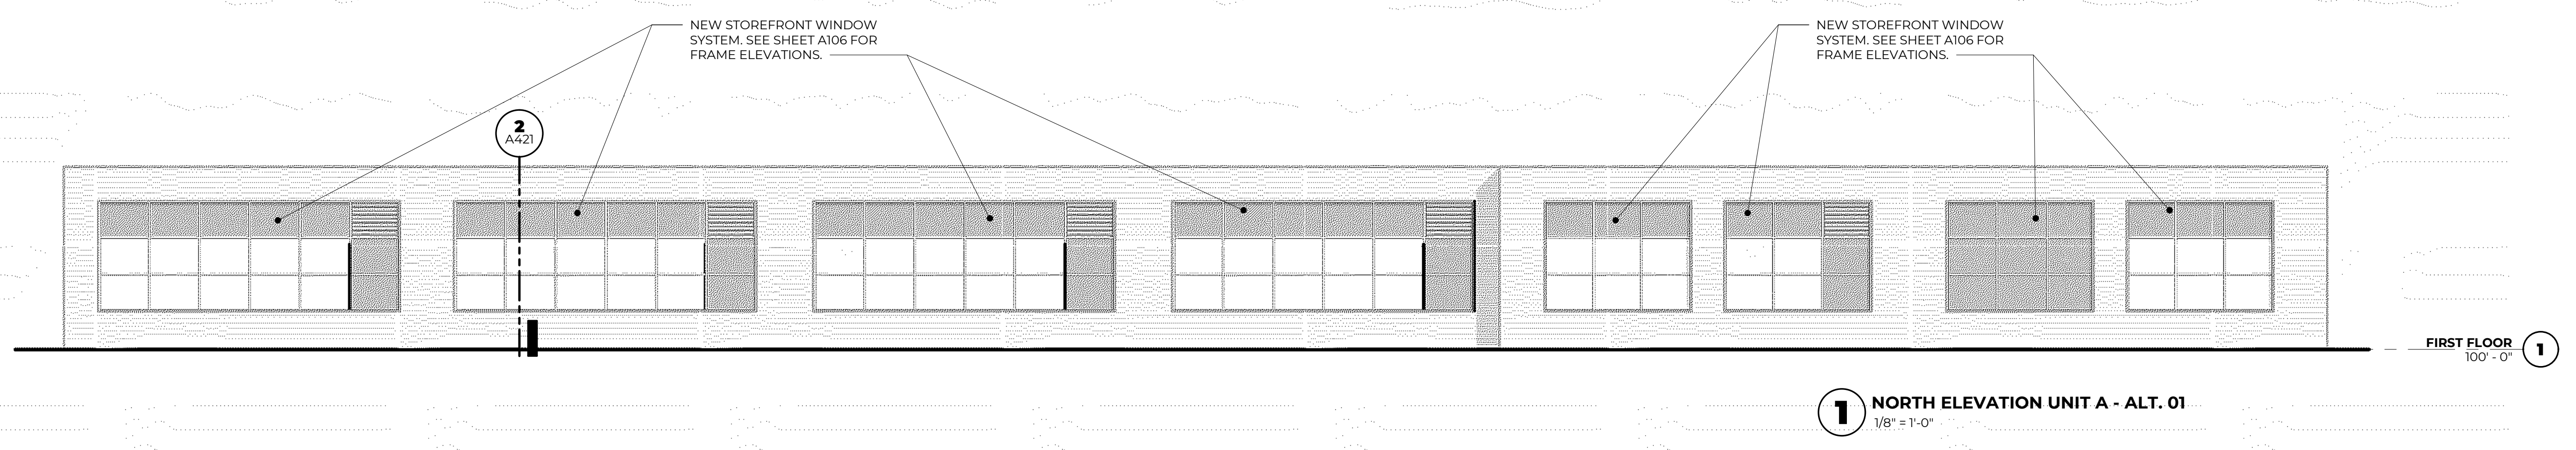
LEGEND EXTERIOR ELEVATION LEGEND

BRICK 1, COLOR:

CJ = CONTROL JOINT, COLOR:

EJ = BUILDING EXPANSION JOINT, COLOR:

SG = SPANDREL GLASS, COLOR:



MPS GLENSIDE
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1213 W Hackley Ave, Muskegon, MI 49441

REVISIONS


SYM DATE ISSUED FOR

ISSUE DATE 03.08.2024


SHEET NAME BUILDING ELEVATIONS - ALT. 01

SHEET NUMBER **A302**


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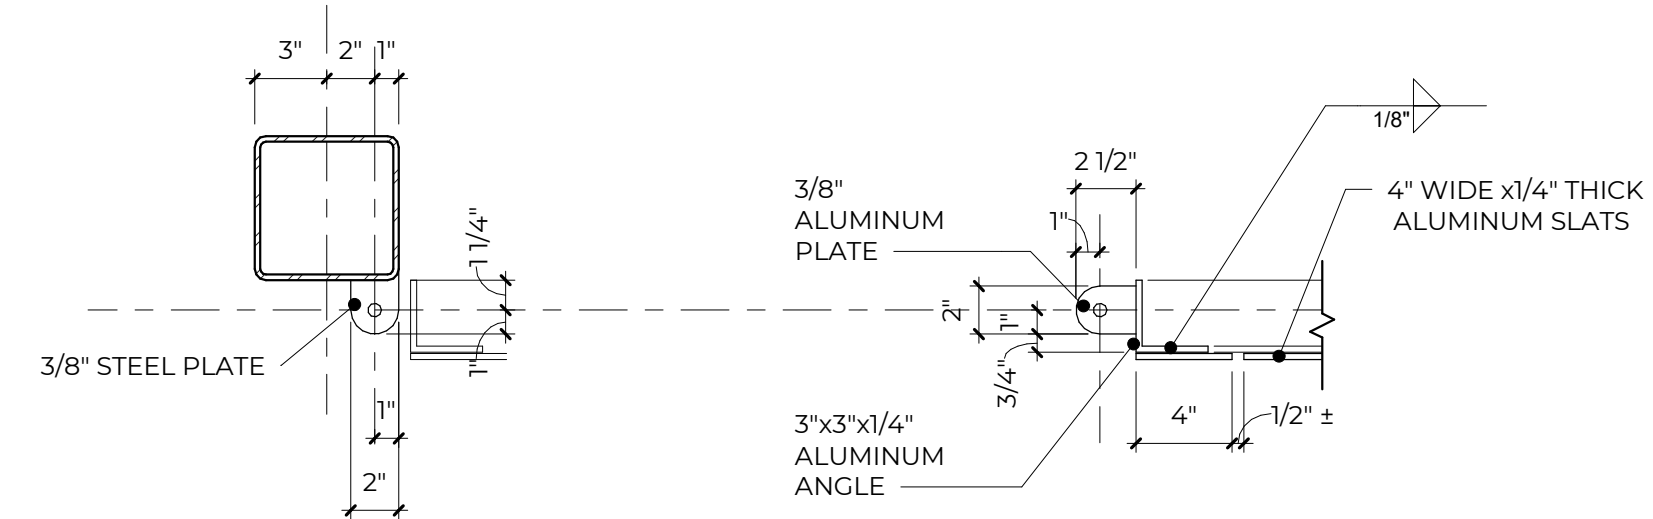
2A ENCLOSURE GATE POST ELEVATION
1/2" = 1'-0"

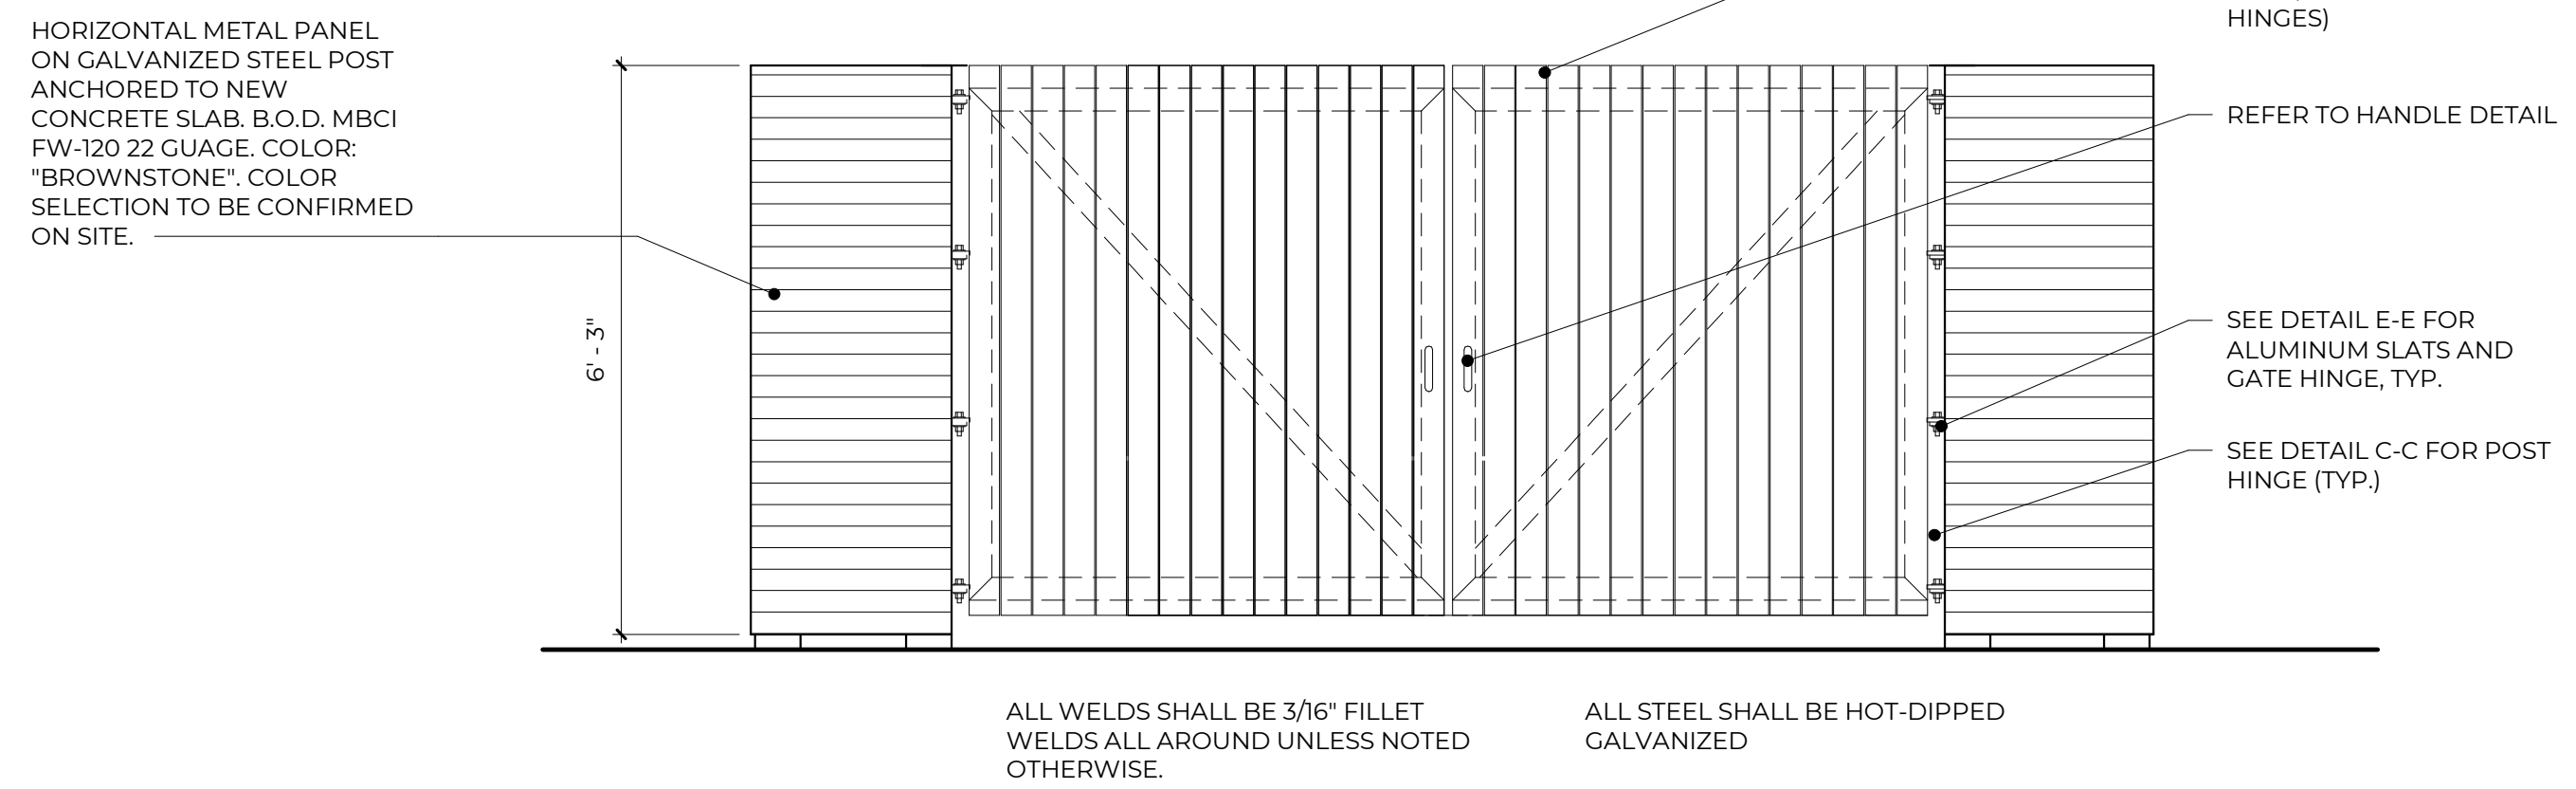

3 ENCLOSURE WALL SECTION
3/4" = 1'-0"

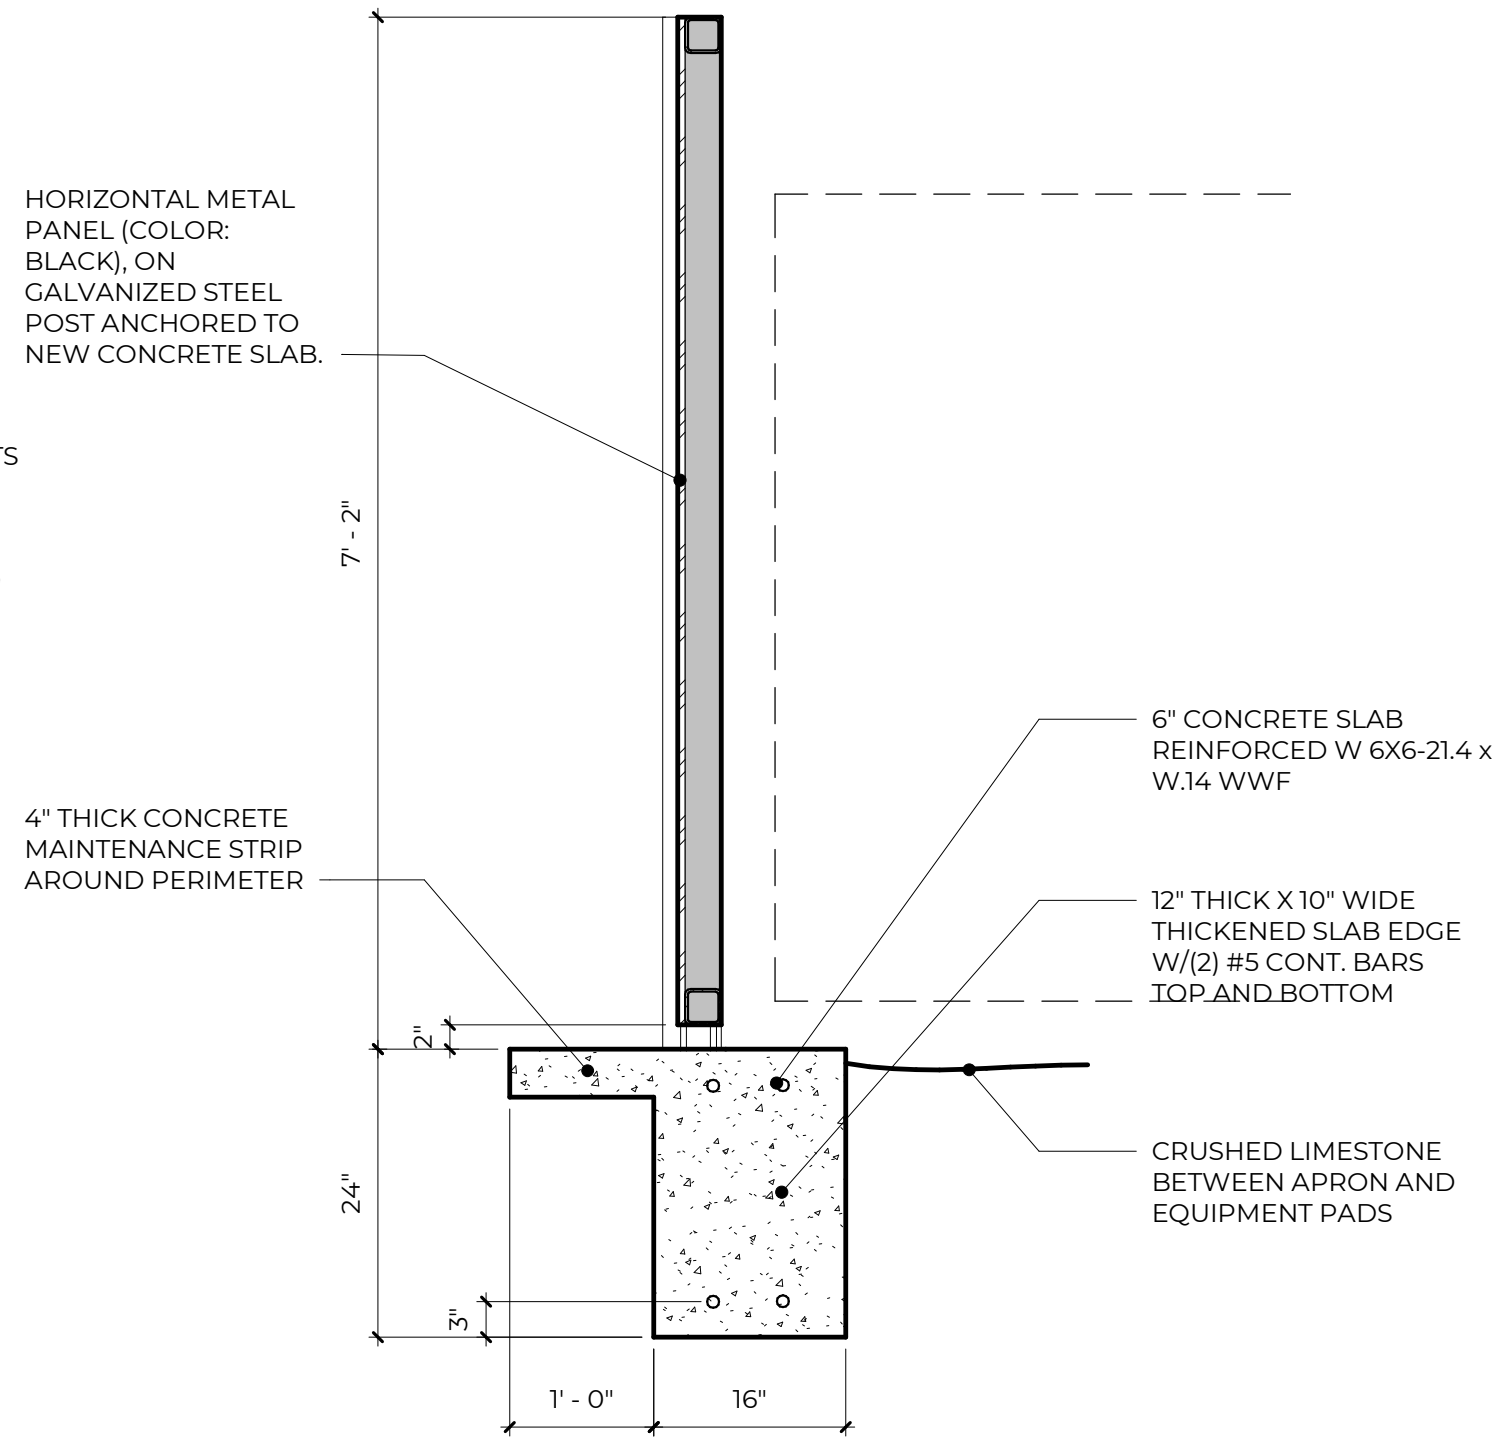


SECTION A-A **HANDLE DETAIL**

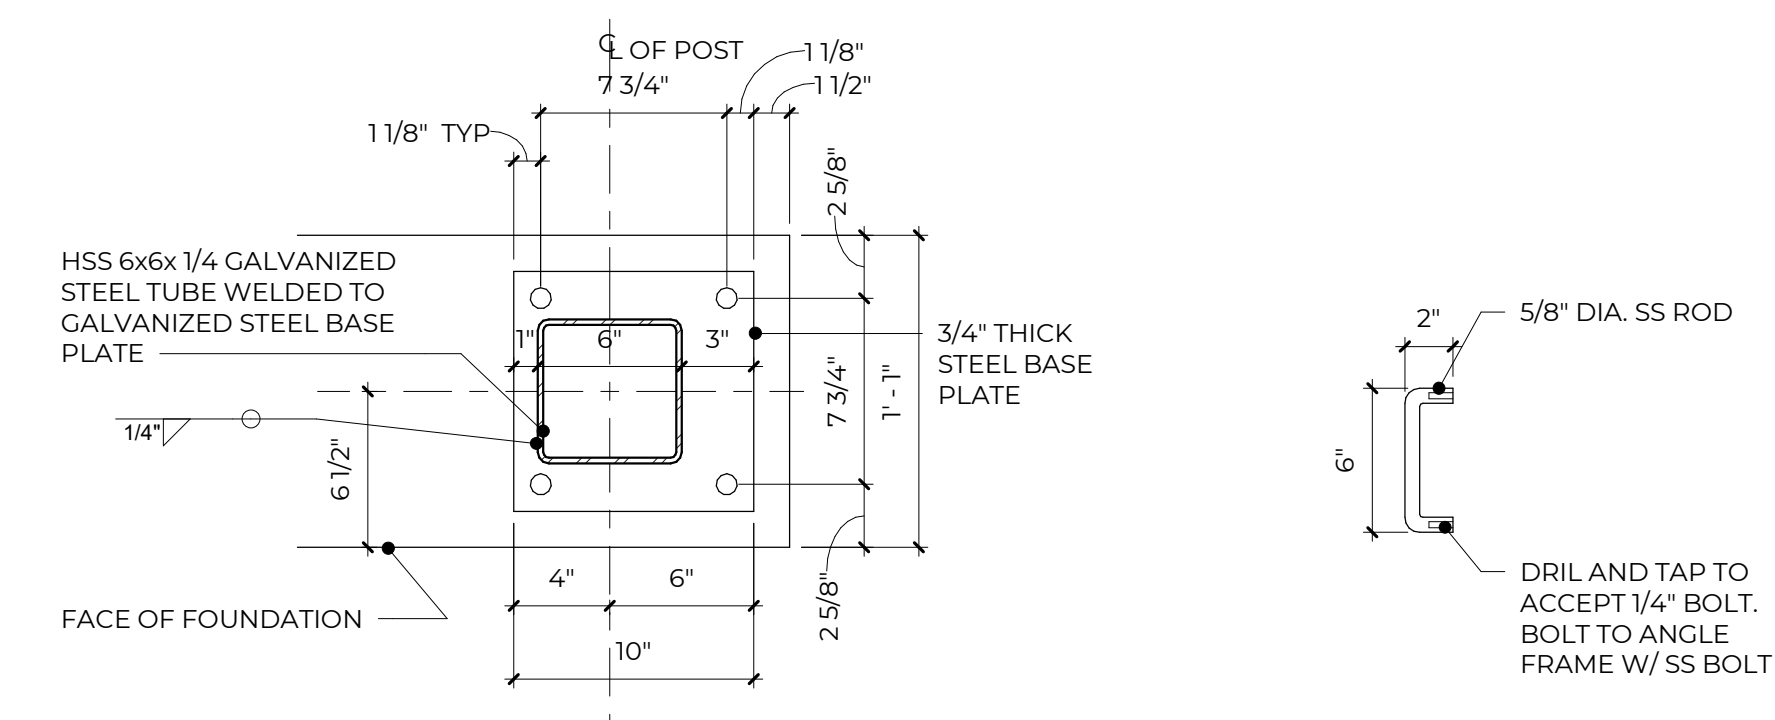


SECTION C-C **SECTION E-E**


2C ENCLOSURE GATE POST DETAILS
1/2" = 1'-0"

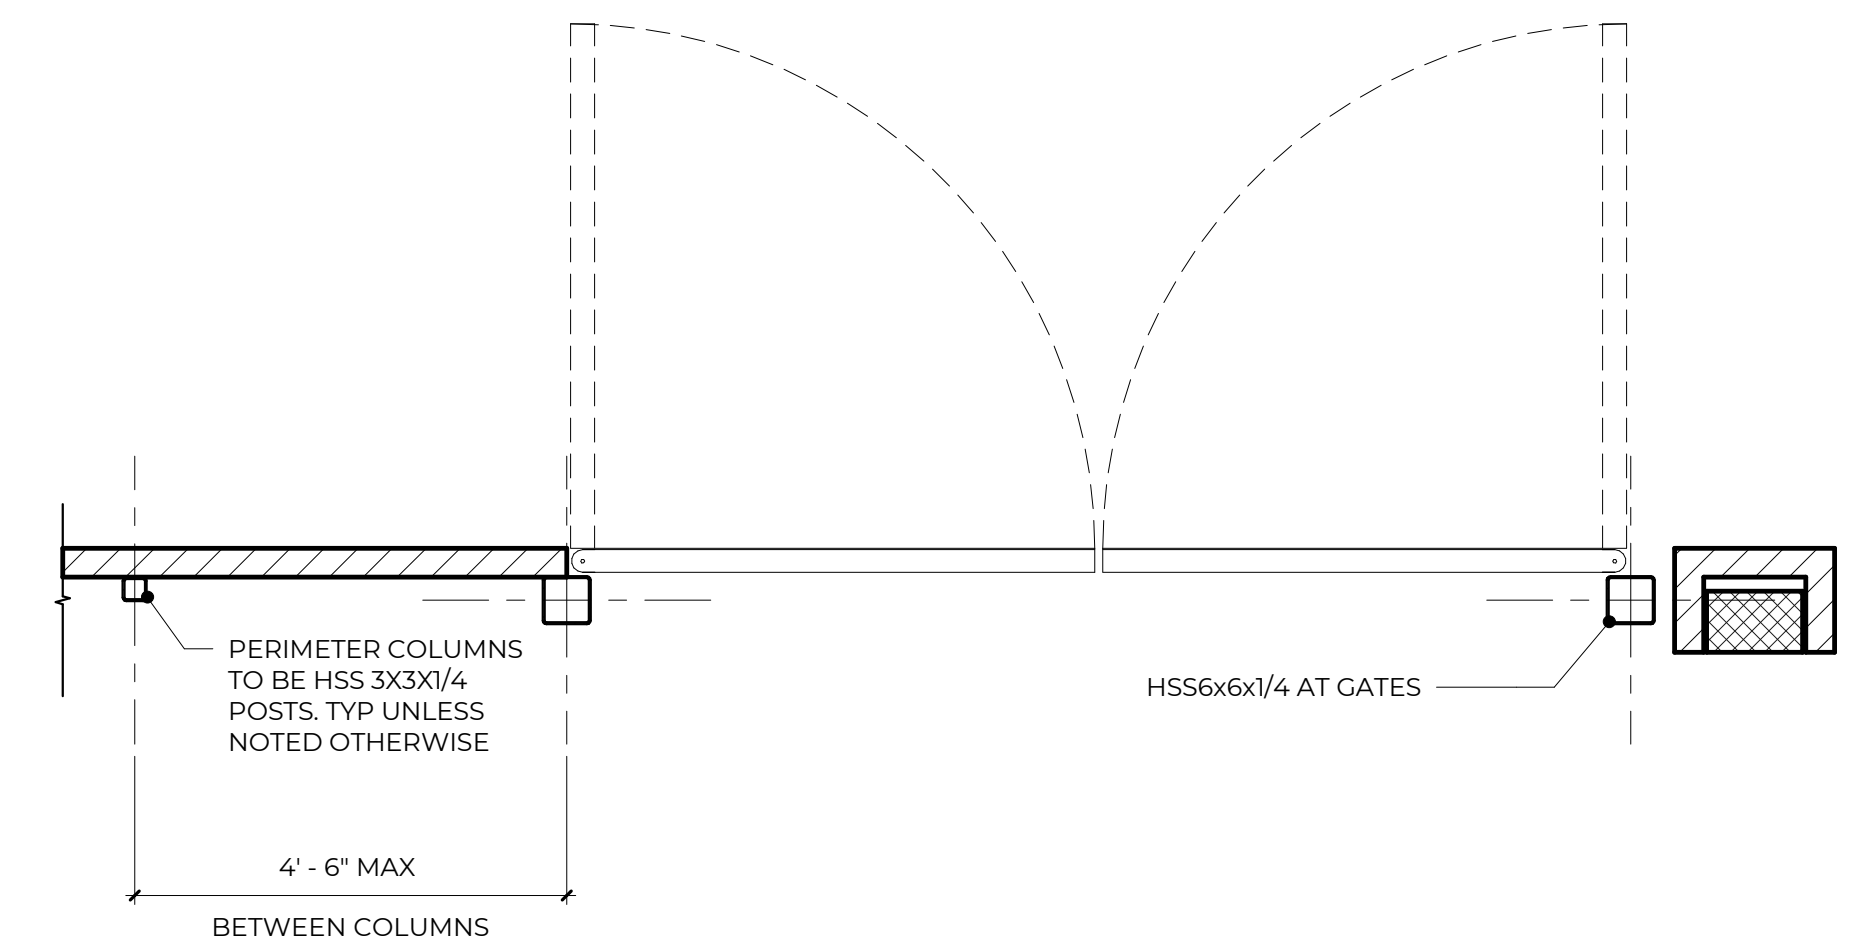


2B ENCLOSURE GATE PLAN
1/2" = 1'-0"

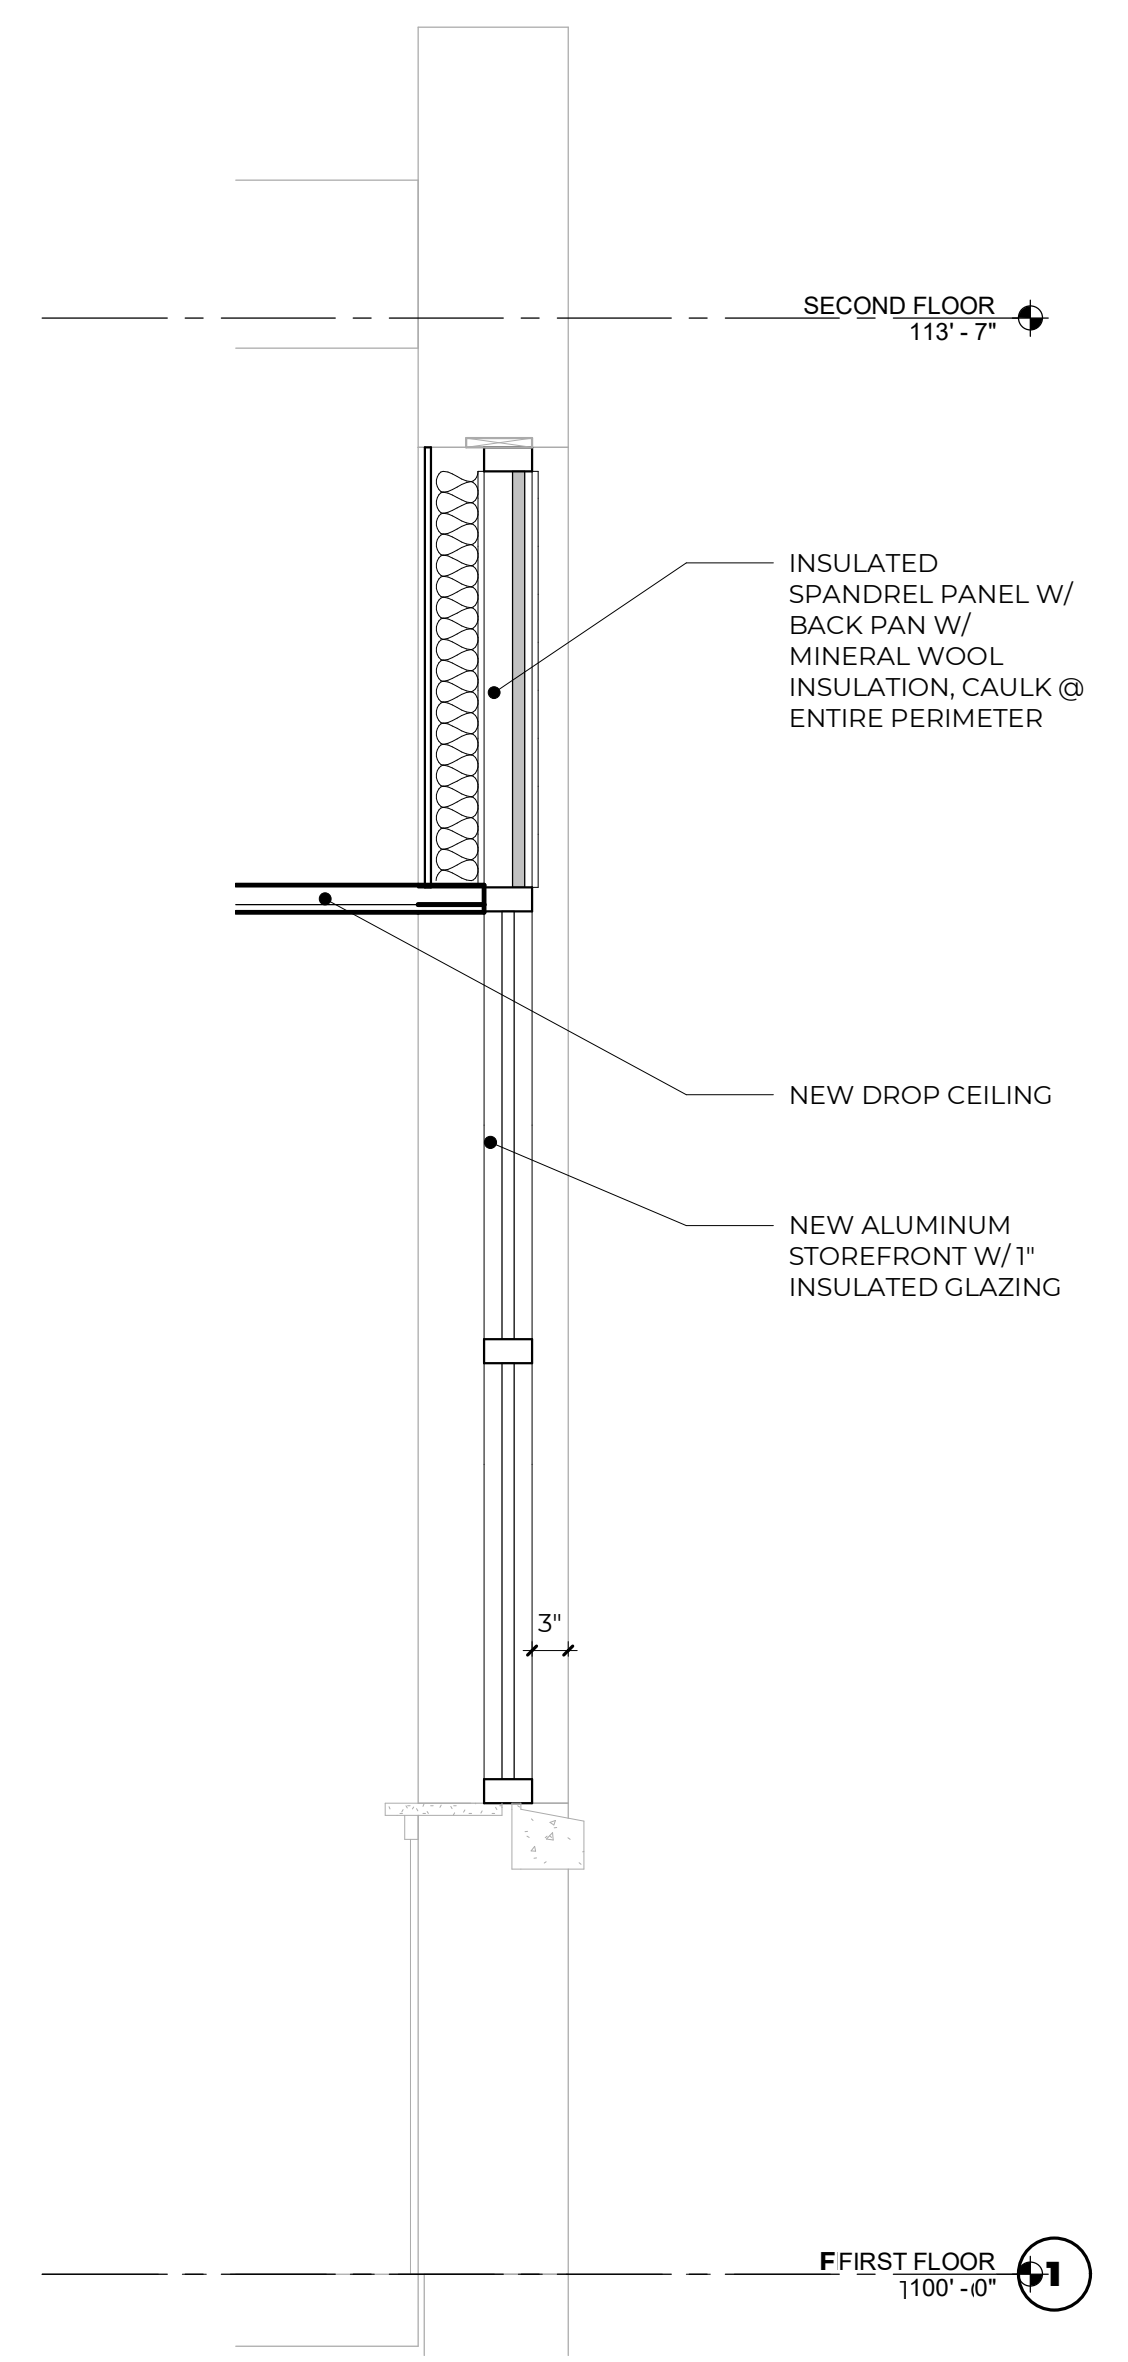

2 CLASSROOM STOREFRONT DETAIL - TYP.
3/4" = 1'-0"

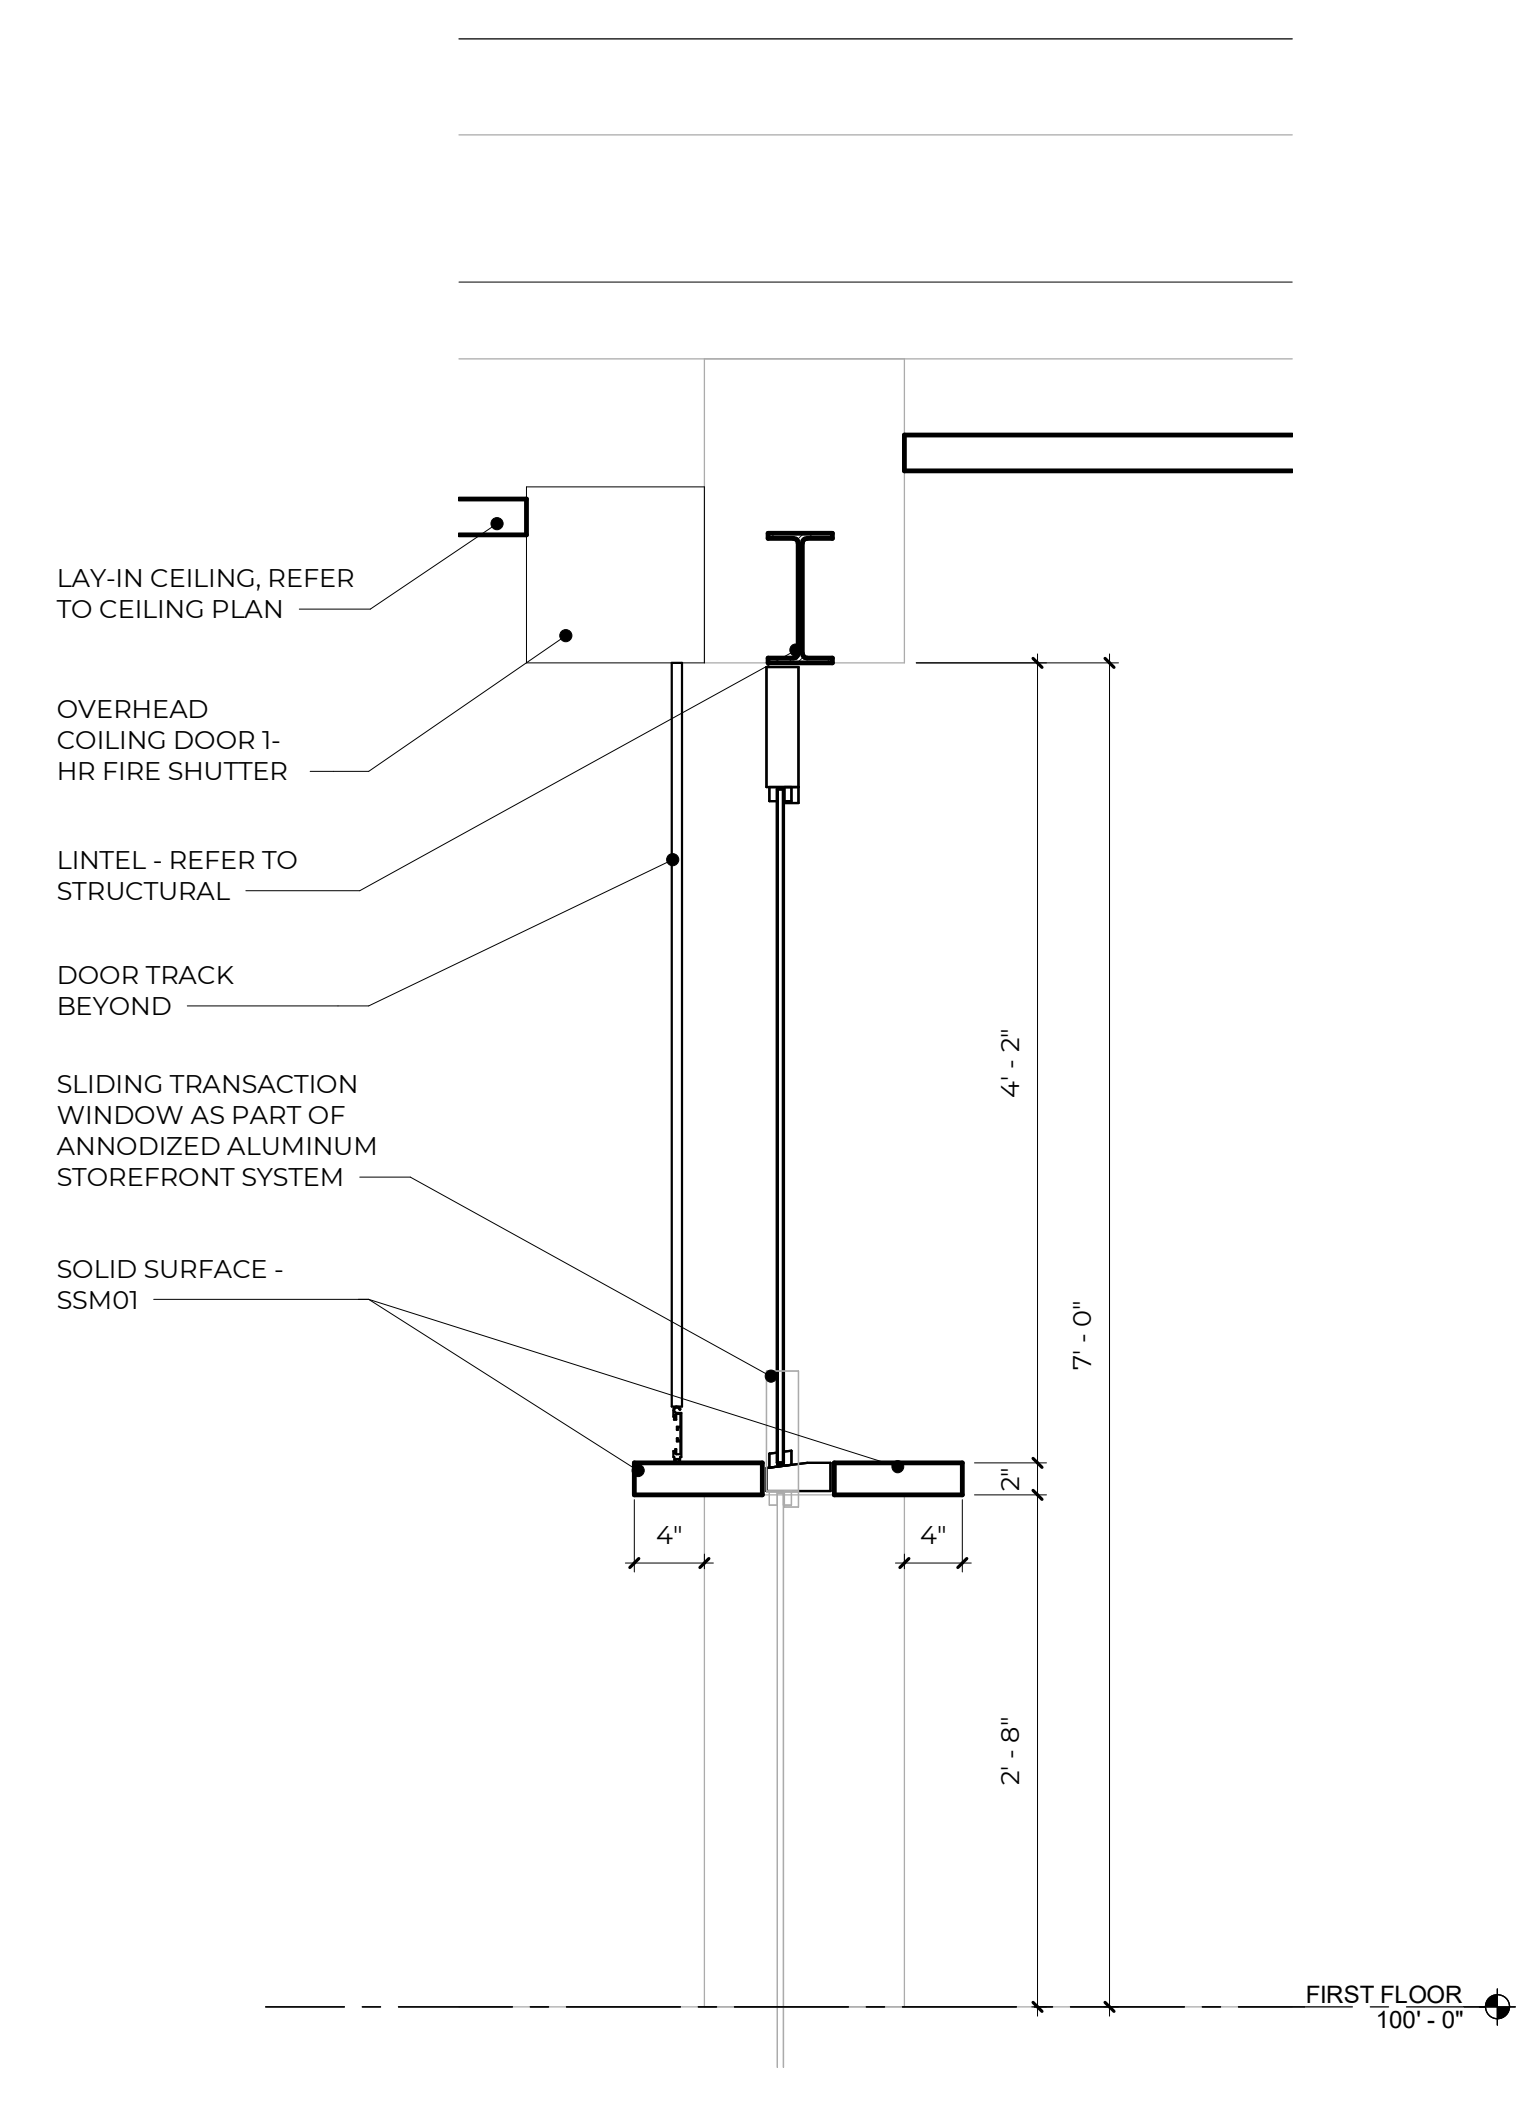

1 DETAIL AT COILING DOOR
1" = 1'-0"

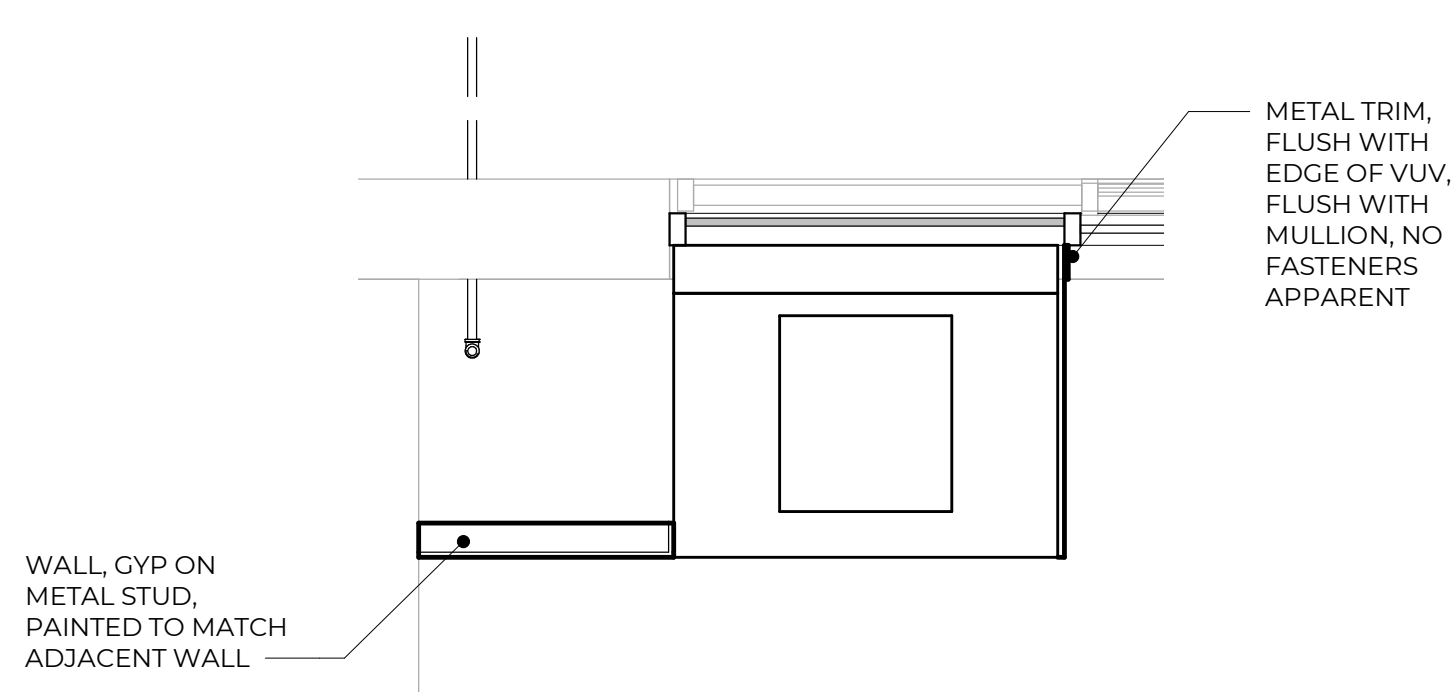

ENLARGED PLAN- AREA AROUND VUV
1/2" = 1'-0"

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REVISIONS

SYM DATE ISSUED FOR

ISSUE DATE
03.08.2024



SHEET NAME
DETAILS

SHEET NUMBER

A421


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GENERAL DOOR NOTES
 1. REFER TO MATERIAL SELECTION SCHEDULE FOR FINISH INFORMATION.
 2. FOR FRAMES INDICATED AS FCW, REFER TO EXTERIOR ELEVATIONS OR FRAME ELEVATIONS.
 3. BASIS OF DESIGN: TUBELITE STANDARD NARROW STILE ENTRANCE. SEE PFG2 BELOW.

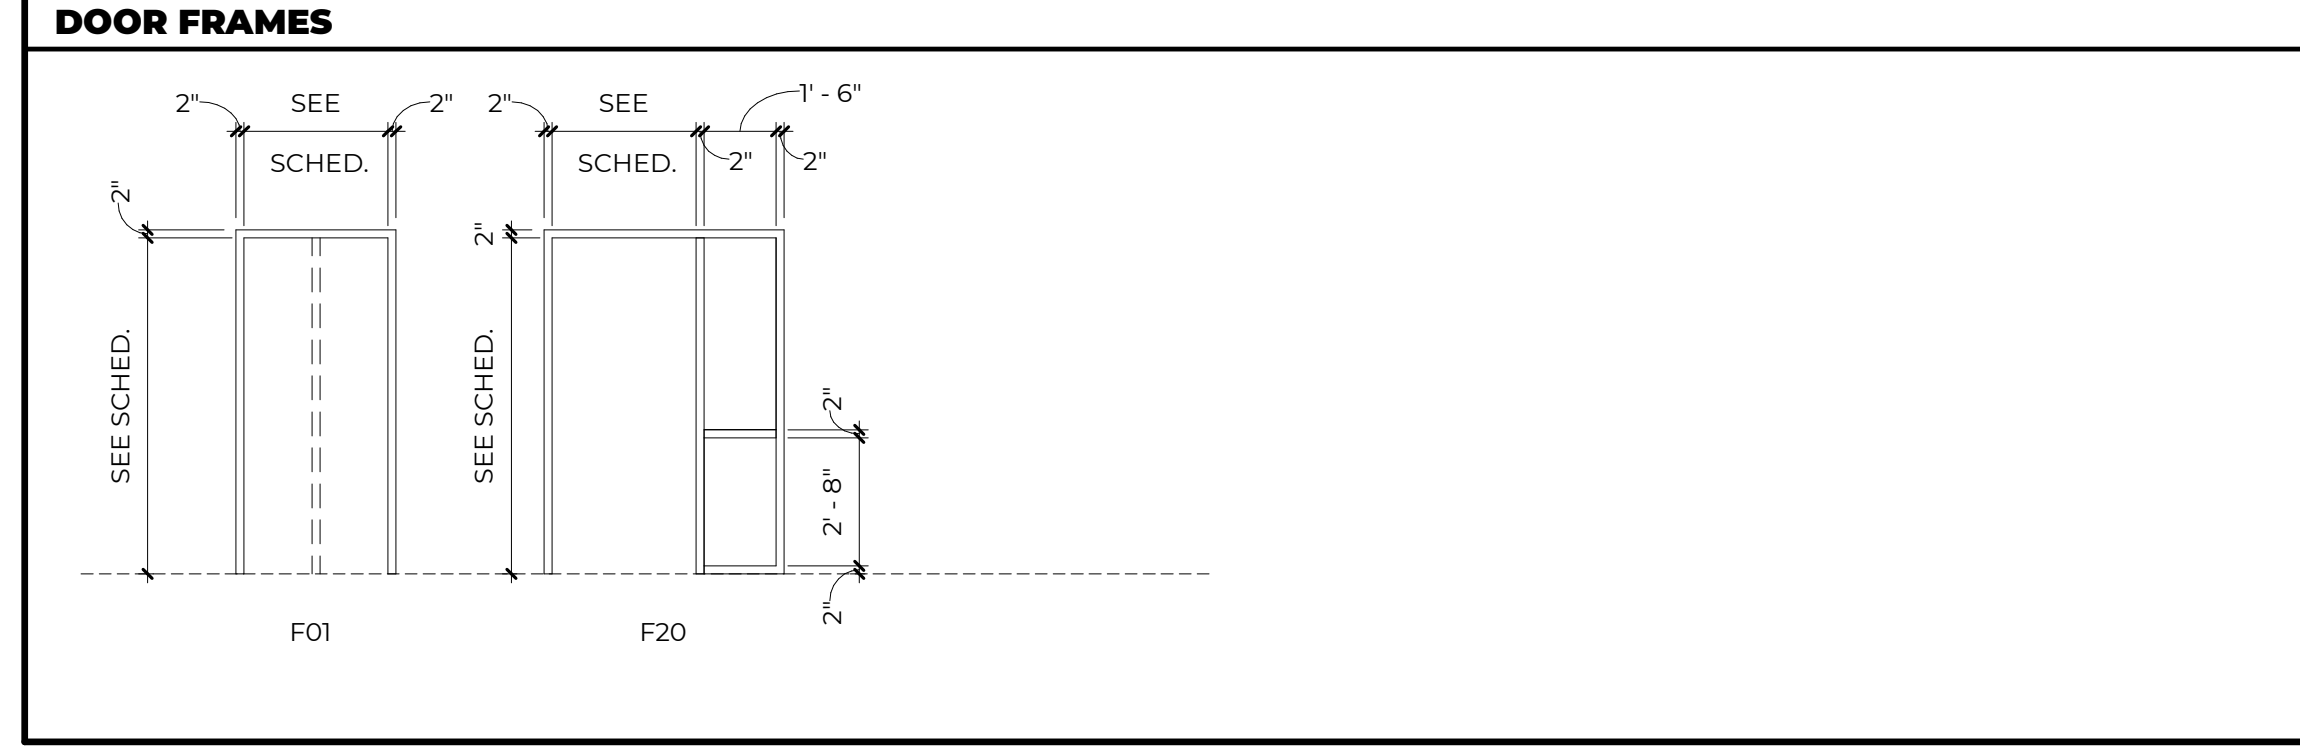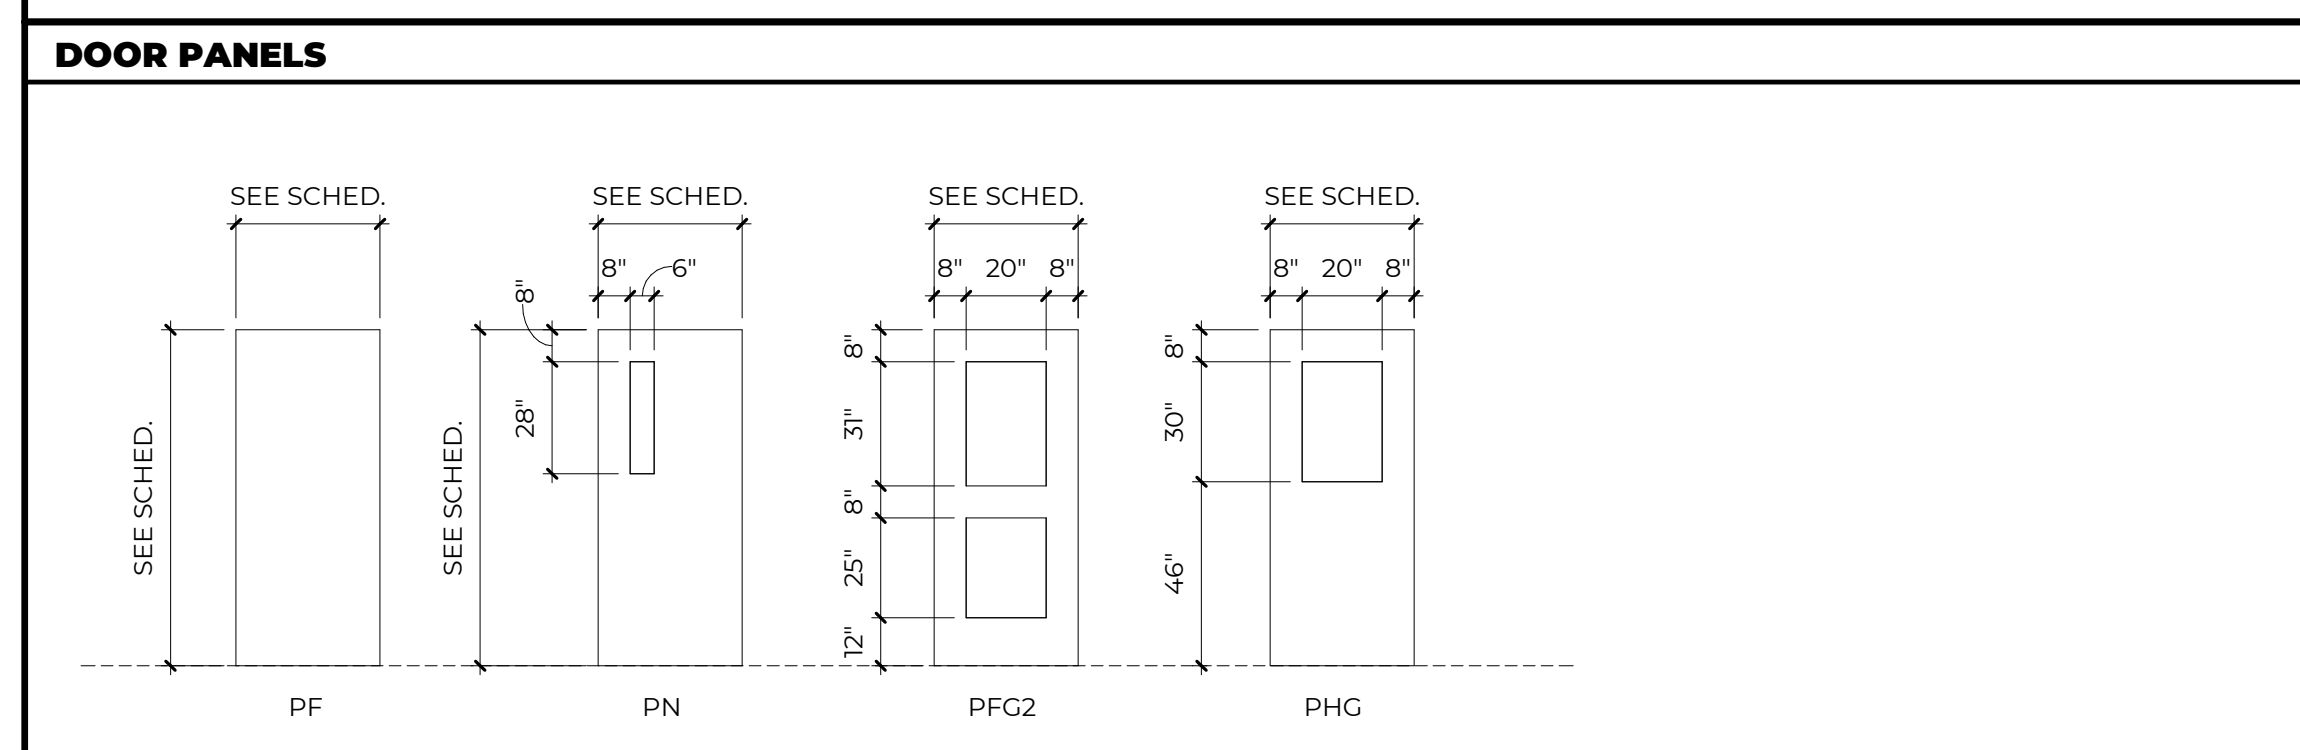


| MARK | ROOM NAME | FIRE RATINGS | | DOOR SCHEDULE | | | | | | FRAME | | | | DETAILS | | | HARDWARE SET No. | COMMENTS | |
|------|-------------------|--------------|-------|---------------|---------------|--------------|--------------|--------------|----------|--------|-------|-----------|----------|---------|-------|-------|------------------|----------|---|
| | | PANEL | FRAME | PANEL 1 WIDTH | PANEL 2 WIDTH | PANEL HEIGHT | PANEL 1 TYPE | PANEL 2 TYPE | MATERIAL | FINISH | GLASS | TYPE | MATERIAL | FINISH | JAMB | HEAD | | | SILL |
| 108 | BOILER | - | - | 3'-0" | | 7'-0" | PF | | AL | AL06 | --- | F01 | AL | AL06 | - | - | - | 15 | EGRESS ONLY WITH KEYPED ENTRY, STANDARD VANDAL PULL |
| 108A | BOILER | 20 | 20 | 3'-0" | | 7'-0" | PF | | HM | P01 | --- | F01 | EXIST | P01 | - | - | - | 03 | |
| 112A | STEAM | 20 | 20 | 3'-0" | | 7'-0" | PN | WD | ST01 | ST01 | FPC01 | F01 | EXIST | ST01 | EXIST | EXIST | - | 07 | |
| 112B | STEAM | 20 | 20 | 3'-0" | | 7'-0" | PN | WD | ST01 | ST01 | FPC01 | F01 | EXIST | ST01 | EXIST | EXIST | - | 08 | |
| 153 | VESTIBULE | - | - | 3'-0" | 3'-0" | 7'-0" | PHG | PHG | AL | AL06 | FPC01 | F: 2/A601 | AL | AL06 | - | - | - | 09 | CARD READER, NO AUTO OPERATOR |
| 154A | FRONT OFFICE | 20 | 20 | 3'-0" | | 7'-0" | PFG2 | AL | AL06 | AL06 | FPC01 | F01 | AL | AL06 | J1 | H1 | - | 04 | CARD READER, NO AUTO OPERATOR |
| 154B | FRONT OFFICE | 20 | 20 | 3'-0" | | 7'-0" | PF | WD | WD | ST01 | --- | F01 | HM | P01 | - | - | - | 05 | CARD READER |
| 156 | PRINCIPALS OFFICE | - | - | 3'-0" | | 7'-0" | PFG2 | WD | WD | ST01 | G01 | F20 | HM | P01 | - | - | - | 01 | |
| 158 | TOILET ROOM | - | - | 3'-0" | | 7'-0" | PF | WD | WD | ST01 | --- | F01 | HM | P01 | - | - | - | 02 | |
| 200 | CORR. | - | - | 3'-0" | | 7'-0" | PHG | AL | AL06 | IG01 | F01 | AL | AL06 | - | - | - | - | 10 | CARD READER |
| 211 | E/W STAIRWELL | - | - | 3'-0" | | 7'-0" | PHG | AL | AL06 | IG01 | F01 | AL | AL06 | - | - | - | - | 11 | CARD READER AT ONE LEAF, INTERCOM DOOR STATION PART OF ALTERNATE 02 |


| | | | | | | | | | | | | | | | | | | | | |
|-------|----------|--|---|---|---|---|---|---|---|---|---|---|---|---|---|---|---|----|-------------|-------------|
| X100 | CORRIDOR | - | - | - | - | - | - | - | - | - | - | - | - | - | - | - | - | 12 | CARD READER | |
| X105 | | ADD AUTO OPERATION, ADD ACTUATOR BUTTON INSIDE, NO ACTUATOR EXTERIOR SIDE. BALANCE OF EXISTING HARDWARE INCLUDING CARD READER AND INTERCOM TO REMAIN | | | | | | | | | | | | | | | | | | |
| X109A | | - | - | - | - | - | - | - | - | - | - | - | - | - | - | - | - | - | 14 | - |
| X119C | | - | - | - | - | - | - | - | - | - | - | - | - | - | - | - | - | - | 16 | - |
| X145B | CORRIDOR | - | - | - | - | - | - | - | - | - | - | - | - | - | - | - | - | - | 13 | CARD READER |
| | | - | - | - | - | - | - | - | - | - | - | - | - | - | - | - | - | - | 06 | CARD READER |

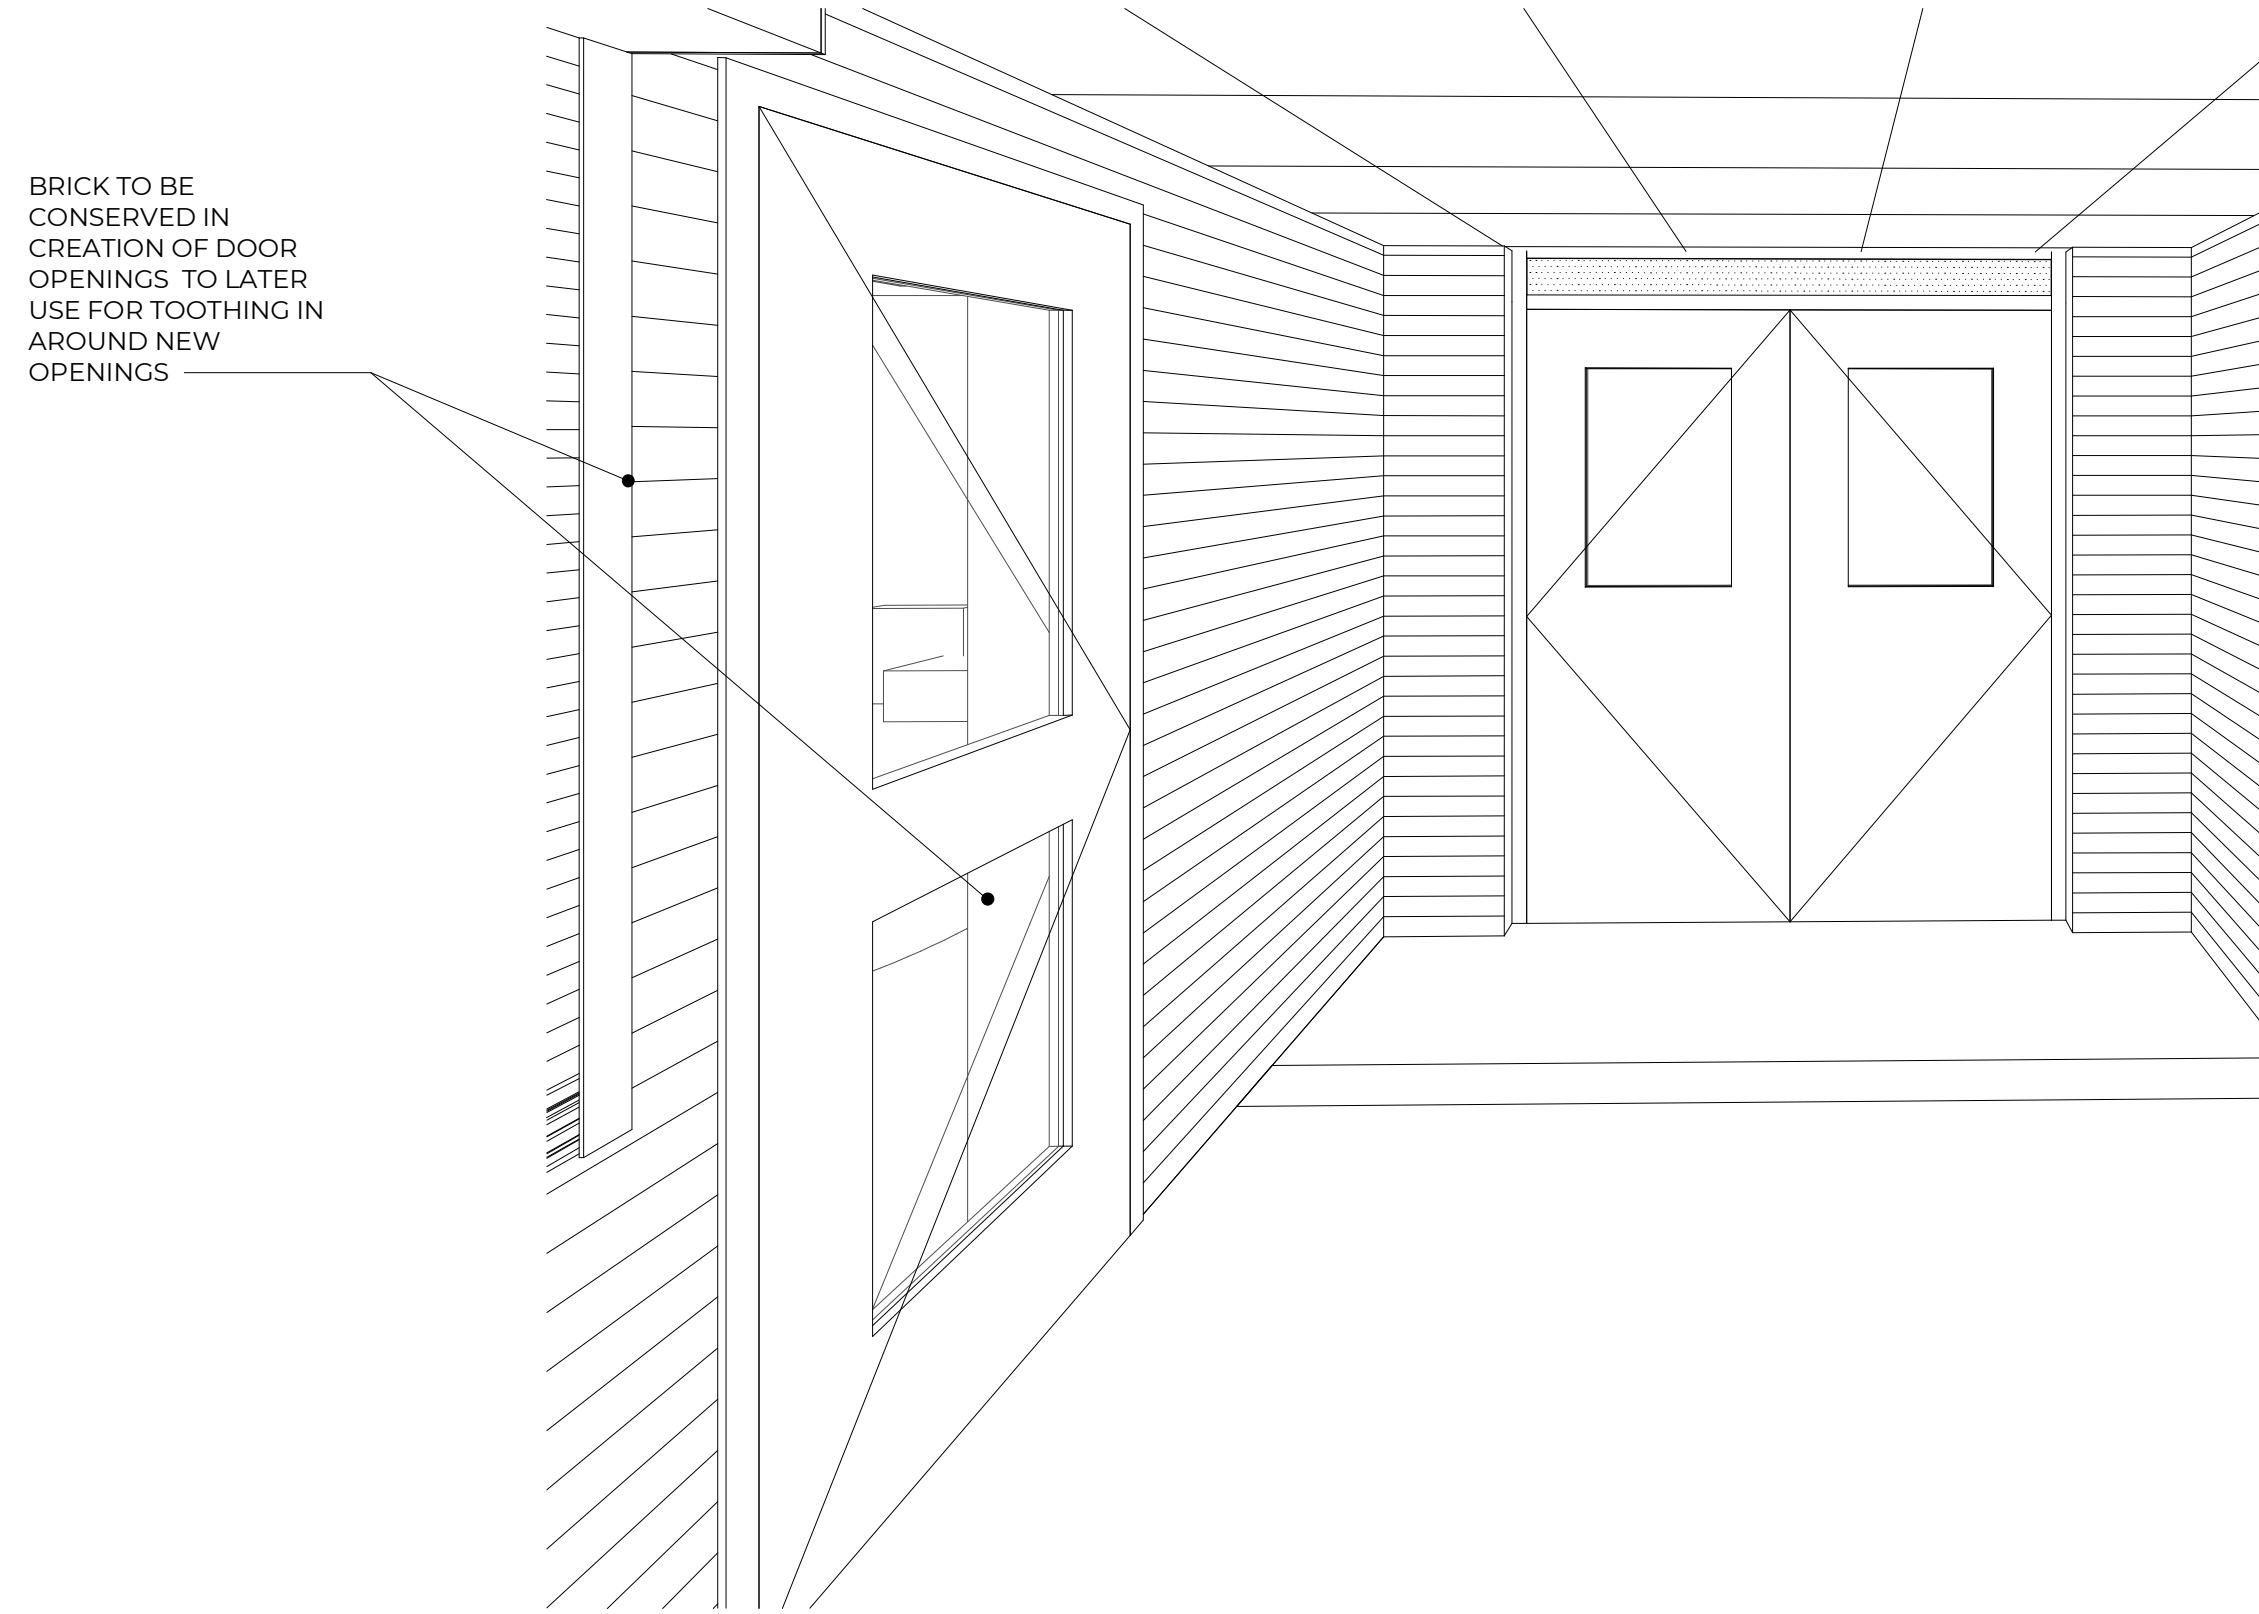

FRONT ENTRY VESTIBULE

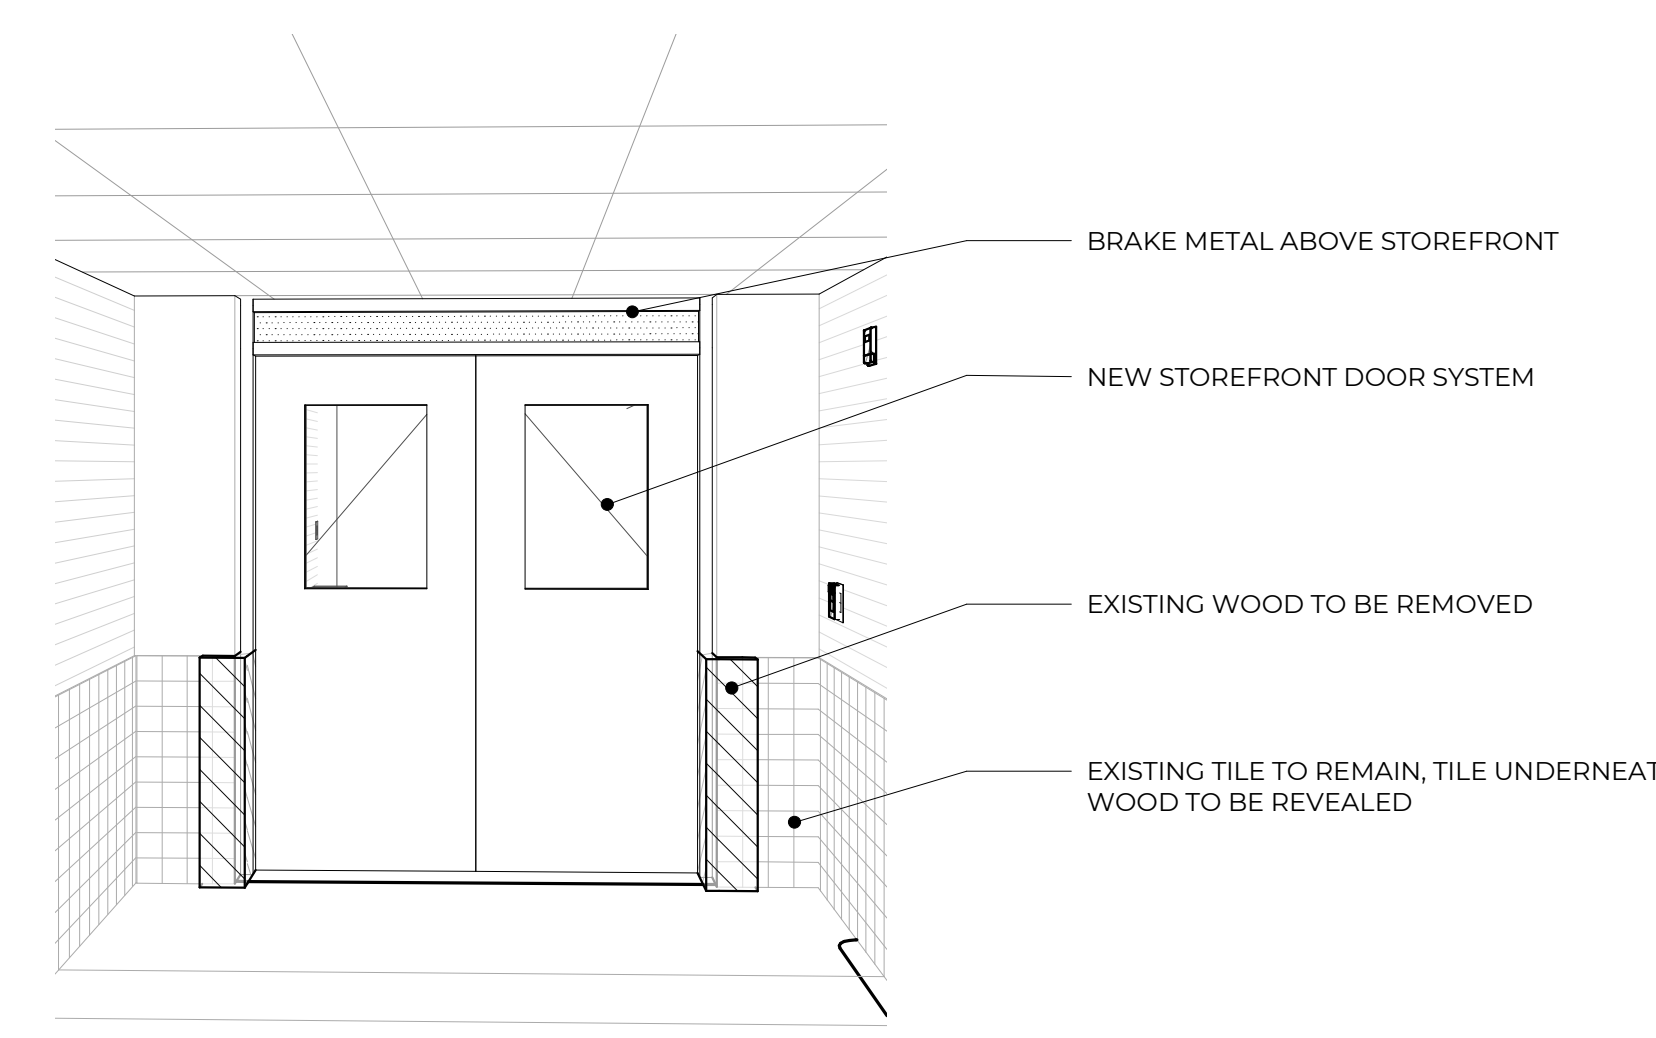

2 FRONT ENTRY VESTIBULE DOOR, FROM HALLWAY

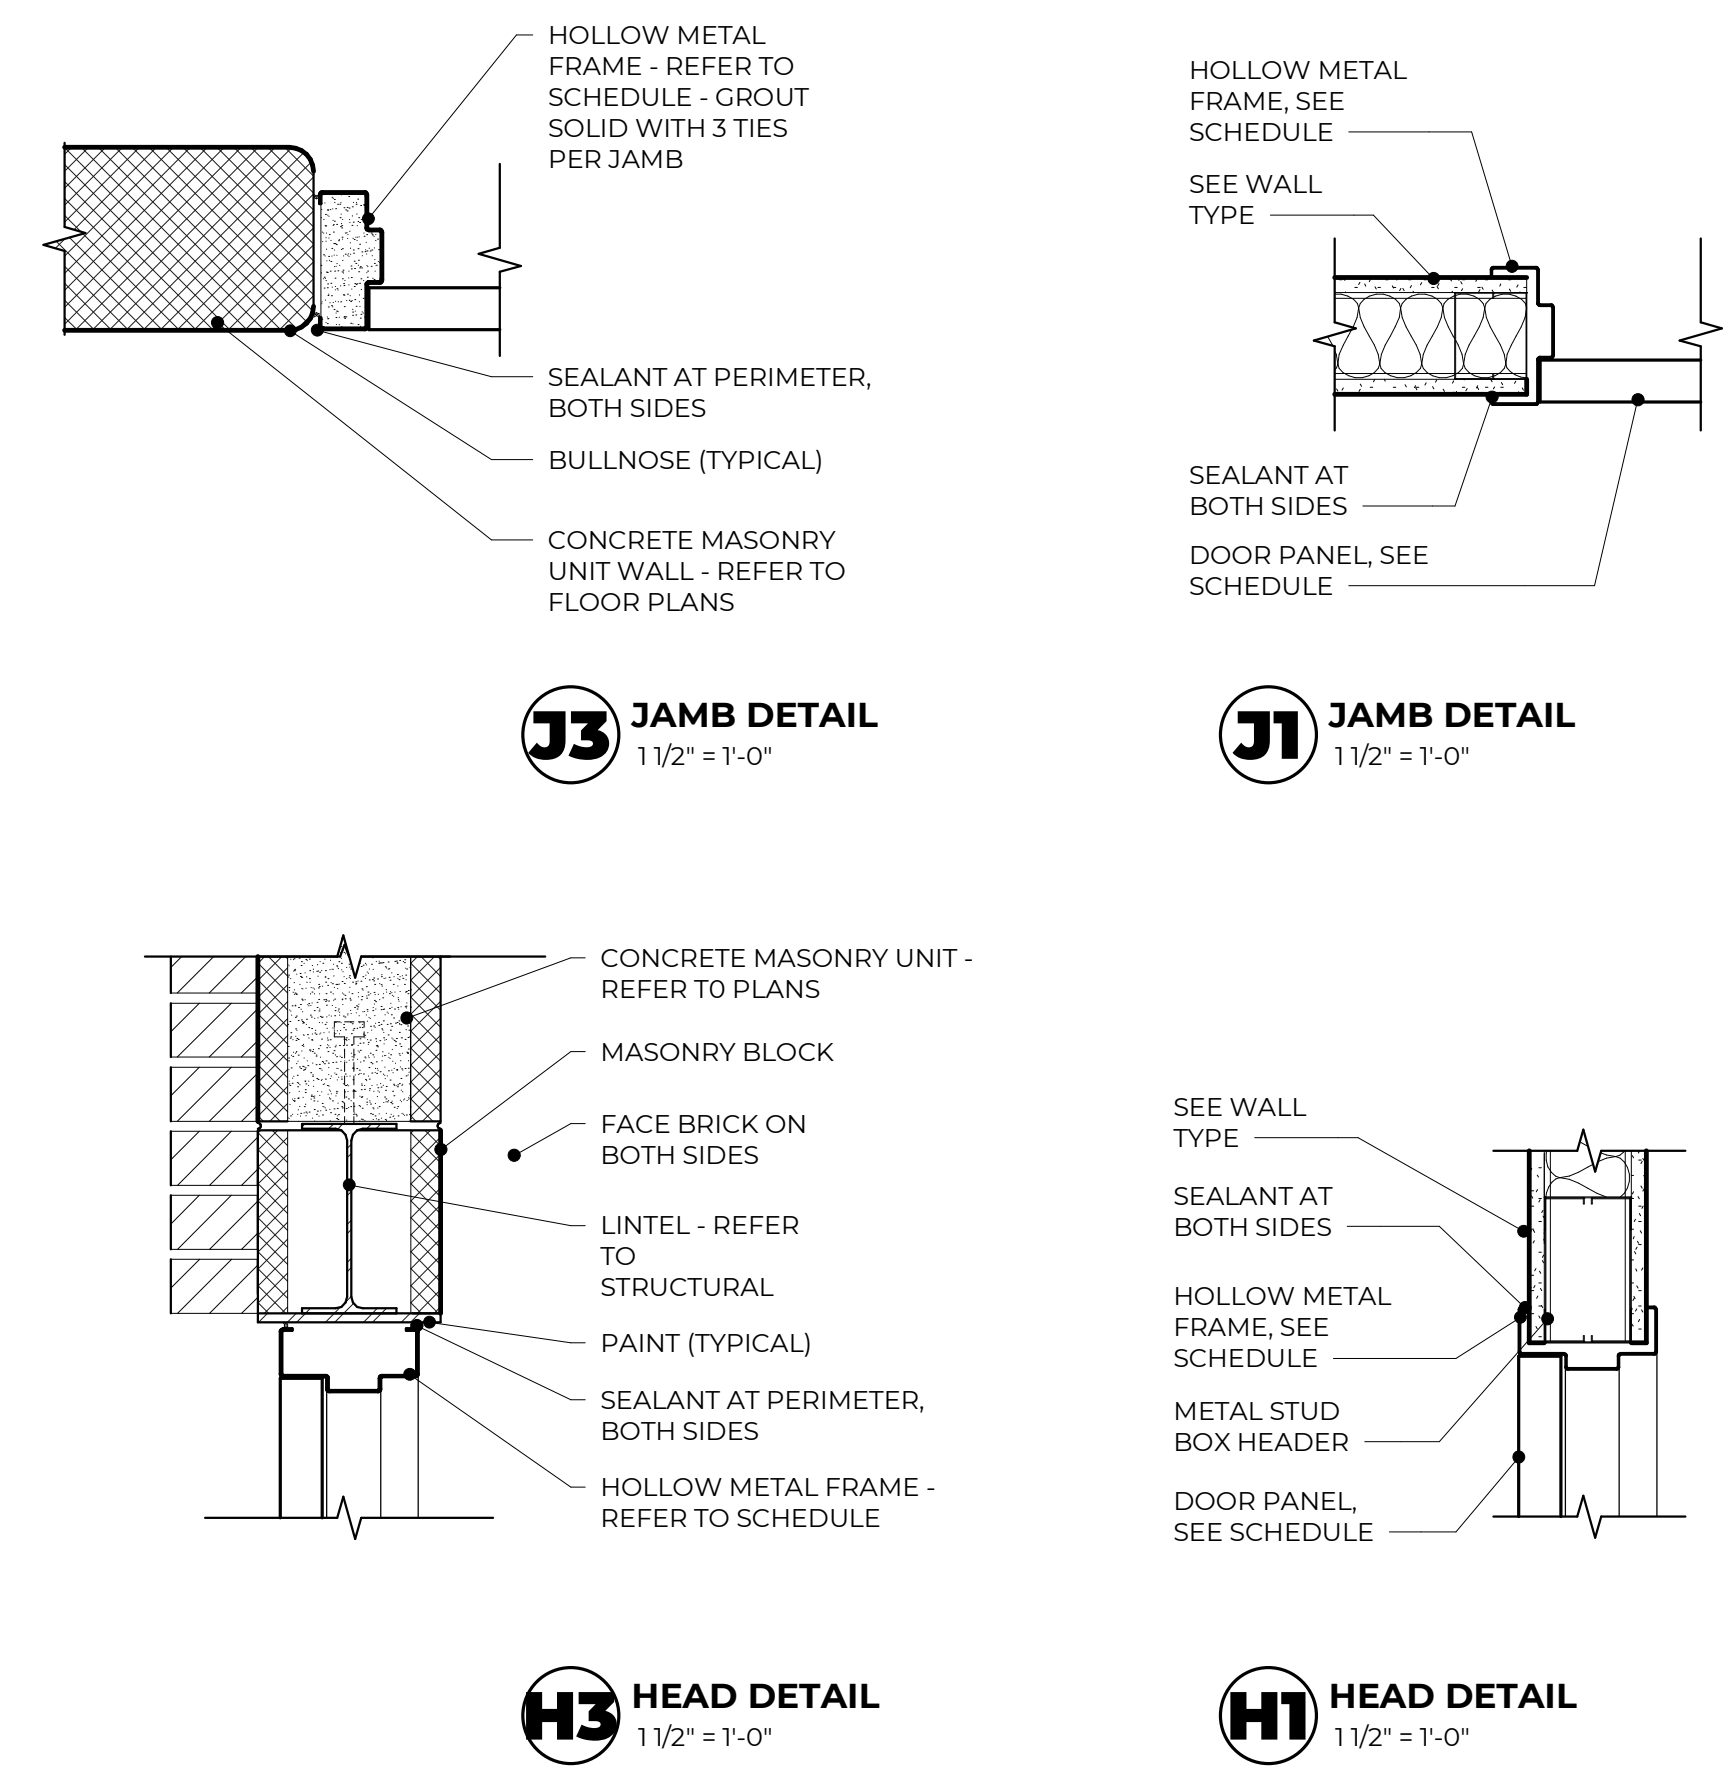

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 1213 W Hackley Ave, Muskegon, MI 49441

| ABBREV | ITEM | MANUFACTURER | PATTERN | COLOR | PRODUCT NO. | SIZE | REMARKS |
|--------|-------------------------------|------------------|----------------------------|---|--------------|-----------|--|
| ACP01 | ACOUSTIC CEILING PANEL | ROCKFON | KORAL | WHITE | -- | 24"X24" | SQUARE REGULAR |
| ACP02 | ACOUSTIC CEILING PANEL | ARMSTRONG | KITCHEN ZONE | WHITE | 673 | 24"X24" | SQUARE REGULAR |
| AL06 | ANODIZED ALUM. STOREFRONTS | | | BLACK | | | |
| CPTL01 | CARPET | TARKETT | COROLLARY 11577 | RED HANDED | 39401 | 24"X24" | ASHLAR INSTALLATION |
| CPTL02 | CARPET [WALKOFF] | SHAW | PORTAL TILE | LAVA | 34549 | 24"X24" | ASHLAR INSTALLATION |
| FRP01 | FIBERGLASS REINFORCED PLASTIC | MARLITE | SYMMETRIX SUBWAY | WHITE WITH BLACK GROUT LINES | C63 | | SANI COAT |
| LVTO1 | LUXURY VINYL TILE | TARKETT | COLORWEAVE | ASHBURN | 10868 | 12" X 36" | 1/3 BOND INSTALLATION, STAGGER END JOINTS 9" MINIMUM. |
| P01 | PAINT | SHERWIN WILLIAMS | -- | SNOWBOUND | SW 7004 | -- | -- |
| P05 | PAINT (DOOR FRAMES) | SHERWIN WILLIAMS | -- | TRICORN BLACK | SW 6258 | -- | -- |
| PCE01 | PRE-CATALYZED EPOXY PAINT | SHERWIN WILLIAMS | -- | SNOWBOUND | 7004 | -- | -- |
| PL01 | PLASTIC LAMINATE | WILSONART | -- | BLACKBIRD | 5024 | -- | PROVIDE AEON SCRATCH RESISTANCE |
| PL02 | PLASTIC LAMINATE | WILSONART | -- | UPTOWN WALNUT | 7971 | -- | -- |
| PT01 | PORCELAIN TILE | MARAZZI | MODERN FORMATION | CANYON TAUPE | MR2MFCA1224R | 12X24 | USE WITH G1 HORIZONTAL STACKED BOND, 1/8" GROUT JOINT |
| PT02 | PORCELAIN TILE | MATCH EXISTING | MATCH EXISTING | MATCH EXISTING (LIGHT PINK) | -- | 4"X4" | VERTICAL STACKED BOND, TO RECEIVE PAINT. REFER TO 100/DETAIL 2 FOR MORE INFORMATION. |
| PTB01 | PORCELAIN TILE | MARAZZI | MODERN FORMATION | CANYON TAUPE | MR2MFCA1224R | 12X24 | USE WITH G1 HORIZONTAL STACKED BOND, 1/8" GROUT JOINT |
| PTB02 | PORCELAIN TILE | MATCH EXISTING | COVED + BULLNOSE TILE BASE | MATCH EXISTING (LIGHT PINK) | -- | 4"X4" | MATCH EXISTING WALL BASE TILE AS CLOSE AS POSSIBLE. USE WITH G1/ |
| PTB03 | PORCELAIN TILE | MATCH EXISTING | COVED + BULLNOSE TILE BASE | MATCH EXISTING (LIGHT GREY) | -- | 4"X4" | MATCH EXISTING WALL BASE TILE AS CLOSE AS POSSIBLE |
| RB01 | RUBBER BASE | TARKETT | BASEWORKS THERMOSET | BLACK | 40 | 4" | -- |
| RB02 | RUBBER BASE | TARKETT | BASEWORKS THERMOSET | MATCH ADJACENT BASE IN CORRIDOR (BROWN_GLOSS) | -- | 6" | -- |
| SGM01 | SOLID SURFACE MATERIAL | FORMICA | WHITE SPEX | -- | 9931 | -- | PRICE GROUP 2 |

| LG ND | FINISH PLAN LEGEND |
|------------|--|
| P-0 | WALL FINISH |
| PTB-0 | FLOOR BASE |
| CPTL-0 | FLOOR FINISH |
| PLD | COUNTER FINISH |
| PLU | CABINET FINISH (BASE AND UPPER) |
| P-0 | INDICATES EXTENT OF ATYPICAL FINISH |
| VCT-L/CPTL | INDICATES FLOOR MATERIAL TRANSITION NOTE - REFER TO MATERIAL SELECTION SCHEDULE REMARKS FOR FLOOR TRANSITION TYPE |
| MULTI | INDICATES MULTIPLE MATERIAL TYPES ON A SURFACE. REFER TO DETAIL OR ELEVATIONS. |
| P | INDICATES MATERIAL PATTERN. REFER TO DETAILS |

- GENERAL NOTES - INTERIORS**
- REFER TO ARCHITECTURAL FLOOR PLANS AND SPECIFICATION FOR ADDITIONAL INFORMATION ON CONSTRUCTION MATERIALS.
 - REFER TO REFLECTED CEILING PLANS FOR CEILING FINISH AND HEIGHTS.
 - REFER TO ENLARGED STAIR PLANS AND SECTIONS FOR FINISH COLORS OF STRINGERS AND GUARDRAILS.
 - REFER TO DOOR SCHEDULE FOR FINISH ON DOORS AND FRAMES.
 - REFER TO ENLARGED FINISH PLANS FOR TOILET ROOM FINISHES.
 - FINISH TAGS APPLY TO LIKE MATERIALS IN ENTIRE ROOM. I.E. CASEWORK TAG MAY ONLY CALLOUT ONE RUN OF CASEWORK, BUT ALL CASEWORK IN ROOM RECEIVE THE SAME FINISHES, UNLESS TAGGED DIFFERENTLY.
 - CASEWORK FINISH TAGS DO NOT APPLY TO CUSTOM MILLWORK PIECES. REFER TO ENLARGED MILLWORK DETAILS FOR FINISH MATERIALS.
 - WALL MOUNTED DIFFUSERS, GRILLES, ACCESS PANELS, ELECTRICAL PANELS, ETC. ARE TO BE PAINTED WITH AN OIL-BASED PAINT TO MATCH THE ADJACENT WALL FINISH.
 - CEILING ACCESS PANELS ARE TO BE PAINTED TO MATCH ADJACENT CEILING FINISH.
 - ALL EXPOSED BRICK TO REMAIN EXPOSED (DO NOT PAINT).
 - INCLUDE SOFT JOINTS WHERE TILE MEETS CEILING, ADJACENT WALLS, AND DOOR TRIM.
 - INCLUDE DILEX COVE TRIM AT BASE OF TILED WALLS
 - PAINT EXPOSED COLUMNS PCE01

WINDOW TREATMENT LEGEND

| | |
|------|---|
| WT01 | MANUAL SINGLE ROLLER SHADE, BASIS OF DESIGN: MERMET E SCREEN, CHARCOAL/COCOA, 3% OPEN |
| WF01 | VINYL WINDOW FILM, SOLYX WHITE DUSTED MATTE SXJ-0550 |


- WINDOW TREATMENTS TO BE PRICED AS A PART OF ALTERNATE 01 AND 02.
- REFER TO SPECIFICATION FOR MORE INFORMATION.
- WINDOW TREATMENT TAGS SHOWN ON PLAN REPRESENTS A SINGLE SHADE.
- REFER TO FLOOR PLANS, EXTERIOR ELEVATIONS AND FRAME TYPES FOR HEIGHT AND WIDTH OF OPENINGS.
- WINDOW TREATMENTS ARE TO BE MOUNTED INSIDE OF THE WINDOW OPENING FROM HEAD TO SILL AND JAMB TO JAMB, UNLESS NOTED OTHERWISE.
- VERIFY ALL DIMENSIONS IN FIELD PRIOR TO FABRICATION.

- GENERAL NOTES - CASEWORK**
- VERIFY ALL DIMENSIONS IN THE FIELD PRIOR TO FABRICATION.
 - FILLER PANELS SHALL BE NO LESS THAN 2" WIDE, UNLESS NOTED OTHERWISE.
 - REFER TO FLOOR FINISH PLANS FOR CASEWORK AND COUNTERTOP FINISHES BY ROOM.
 - FINISH ANY EXPOSED END PANELS, UNDERSIDE OF CABINETS OR OPEN CABINETS, WITH PLASTIC LAMINATE SPECIFIED FOR FRONTS IN THAT ROOM.
 - ALL VERTICAL AND HORIZONTAL EXPOSED AND SEMI-EXPOSED SURFACES TO BE FINISHED WITH BODY PLASTIC LAMINATE.
 - SUPPORT BRACKETS ARE REQUIRED EVERY 36" O.C. AT AREAS WHERE COUNTERTOP IS OPEN UNDERNEATH. THE CONTRACTOR WILL BE RESPONSIBLE FOR PROVIDING BRACKETS APPROPRIATELY SIZED BASED ON DEPTH OF COUNTER.
 - PATTERN OR DRAIN DIRECTION TO BE VERTICAL ON DOORS AND ON DRAWERS - UNLESS NOTED OTHERWISE.
 - LOCKS ALL UNITS TO BE KEVED ALIKE PER ROOM. ALL ROOMS KEVED DIFFERENTLY. LOWER CASEWORK + WARDROBES TO BE LOCKING. UPPER CASEWORK TO BE NON-LOCKING.
 - GROMMET LOCATIONS SHALL BE VERIFIED IN THE FIELD WITH THE OWNER PRIOR TO INSTALLATION - COORDINATE WITH POWER & DATA LOCATIONS FOR ANY ADDITIONAL WIRE MANAGEMENT REQUIREMENTS
 - 'SLABSMITHING' WILL BE REQUIRED IN INSTANCES WHERE A PATTERNED QUARTZ, NATURAL STONE, OR SOLID SURFACE IS SPECIFIED.
 - PULL SELECTION: BASIS OF DESIGN: RICHELIEU PRODUCT #BP2288128900, CONTEMPORARY METAL PULL - 2288. 5-1/32" CENTER TO CENTER MATTE BLACK
 - COUNTERTOP EDGE: 3MM PVC EDGE, STANDARD SQUARE, TO MATCH LAMINATE SELECTION.
 - CABINET INTERIOR AND TOPS OF UPPER CABINETS TO BE STANDARD WHITE
 - HINGE: 5 KNUCKLE HINGE, MATTE BLACK, CONCEALED


STANDARD ABBREVIATIONS

| | | | |
|-----|-----------------|-----|--------------------|
| ADJ | ADJUSTABLE | BF | BARRIER FREE |
| FP | FILLER PANEL | LFE | LEFT FINISHED END |
| RP | REMOVABLE PANEL | RFE | RIGHT FINISHED END |


PURE ARCHITECTS

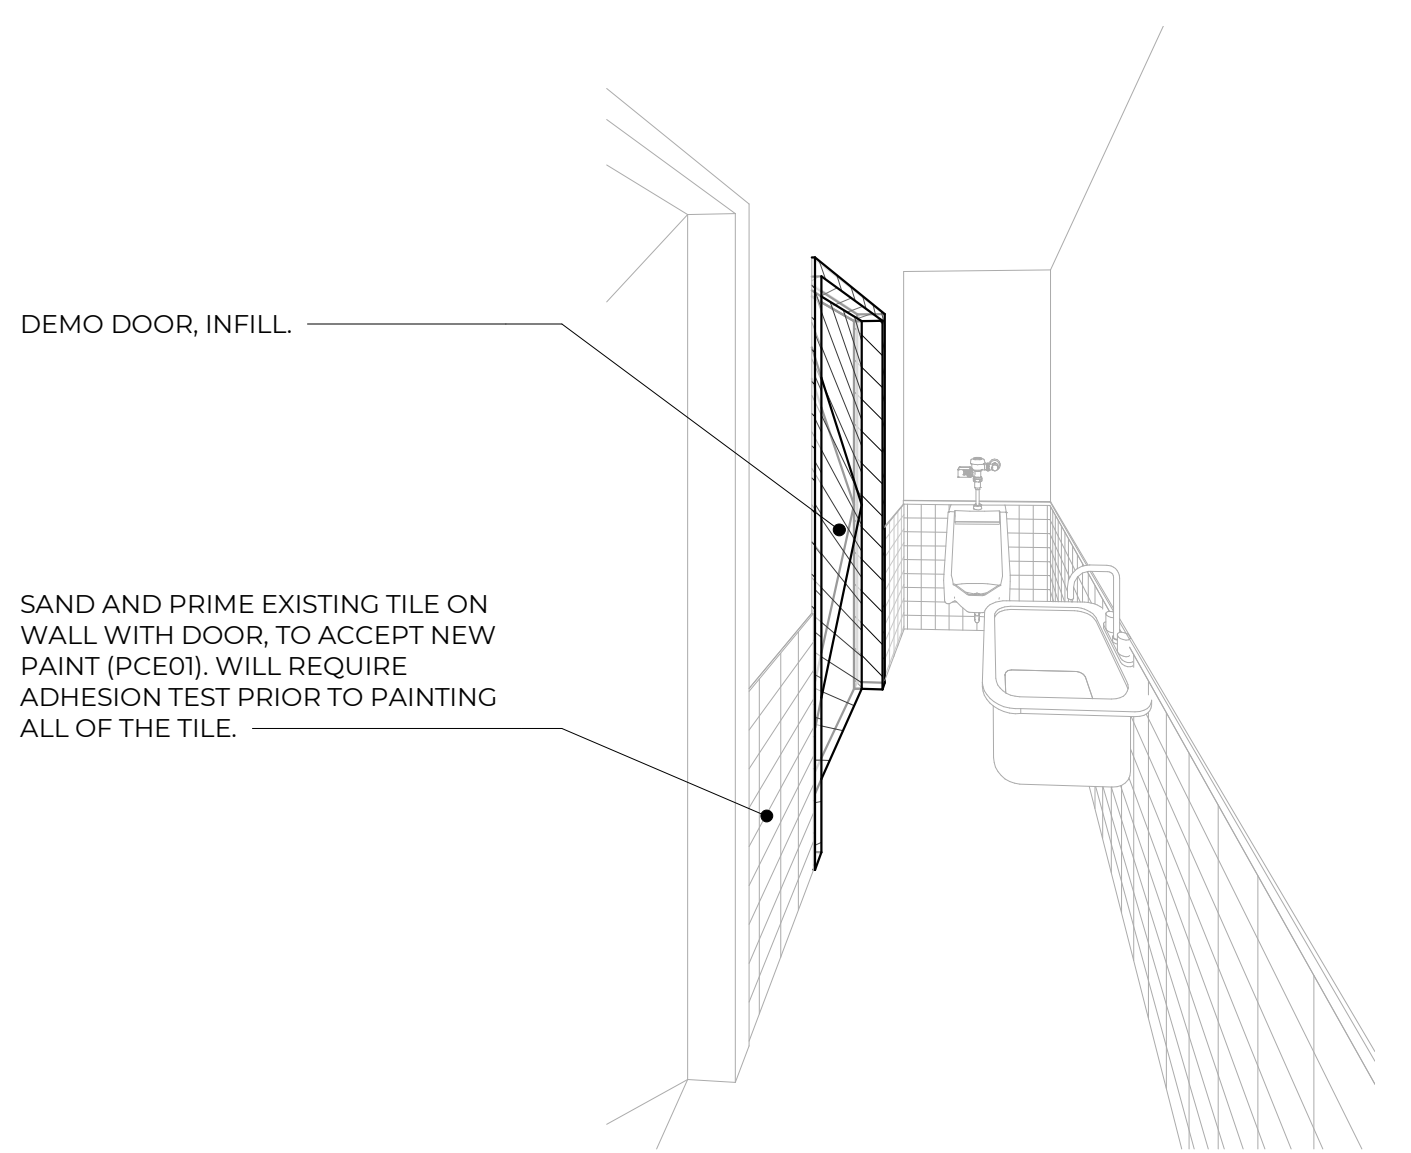


6 115A/ 117A/ 119A TOILET ROOMS - DEMO

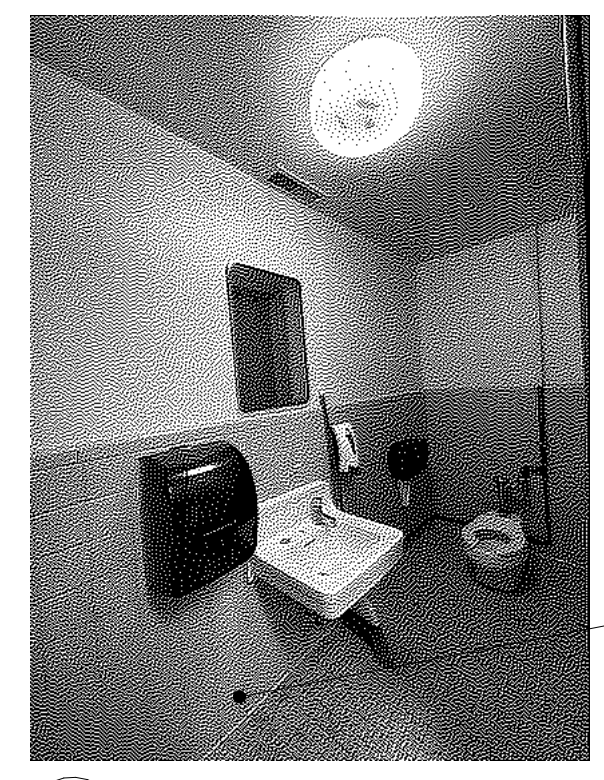


B 115A/ 117A/ 119A TOILET ROOMS - EXISTING CONDITIONS

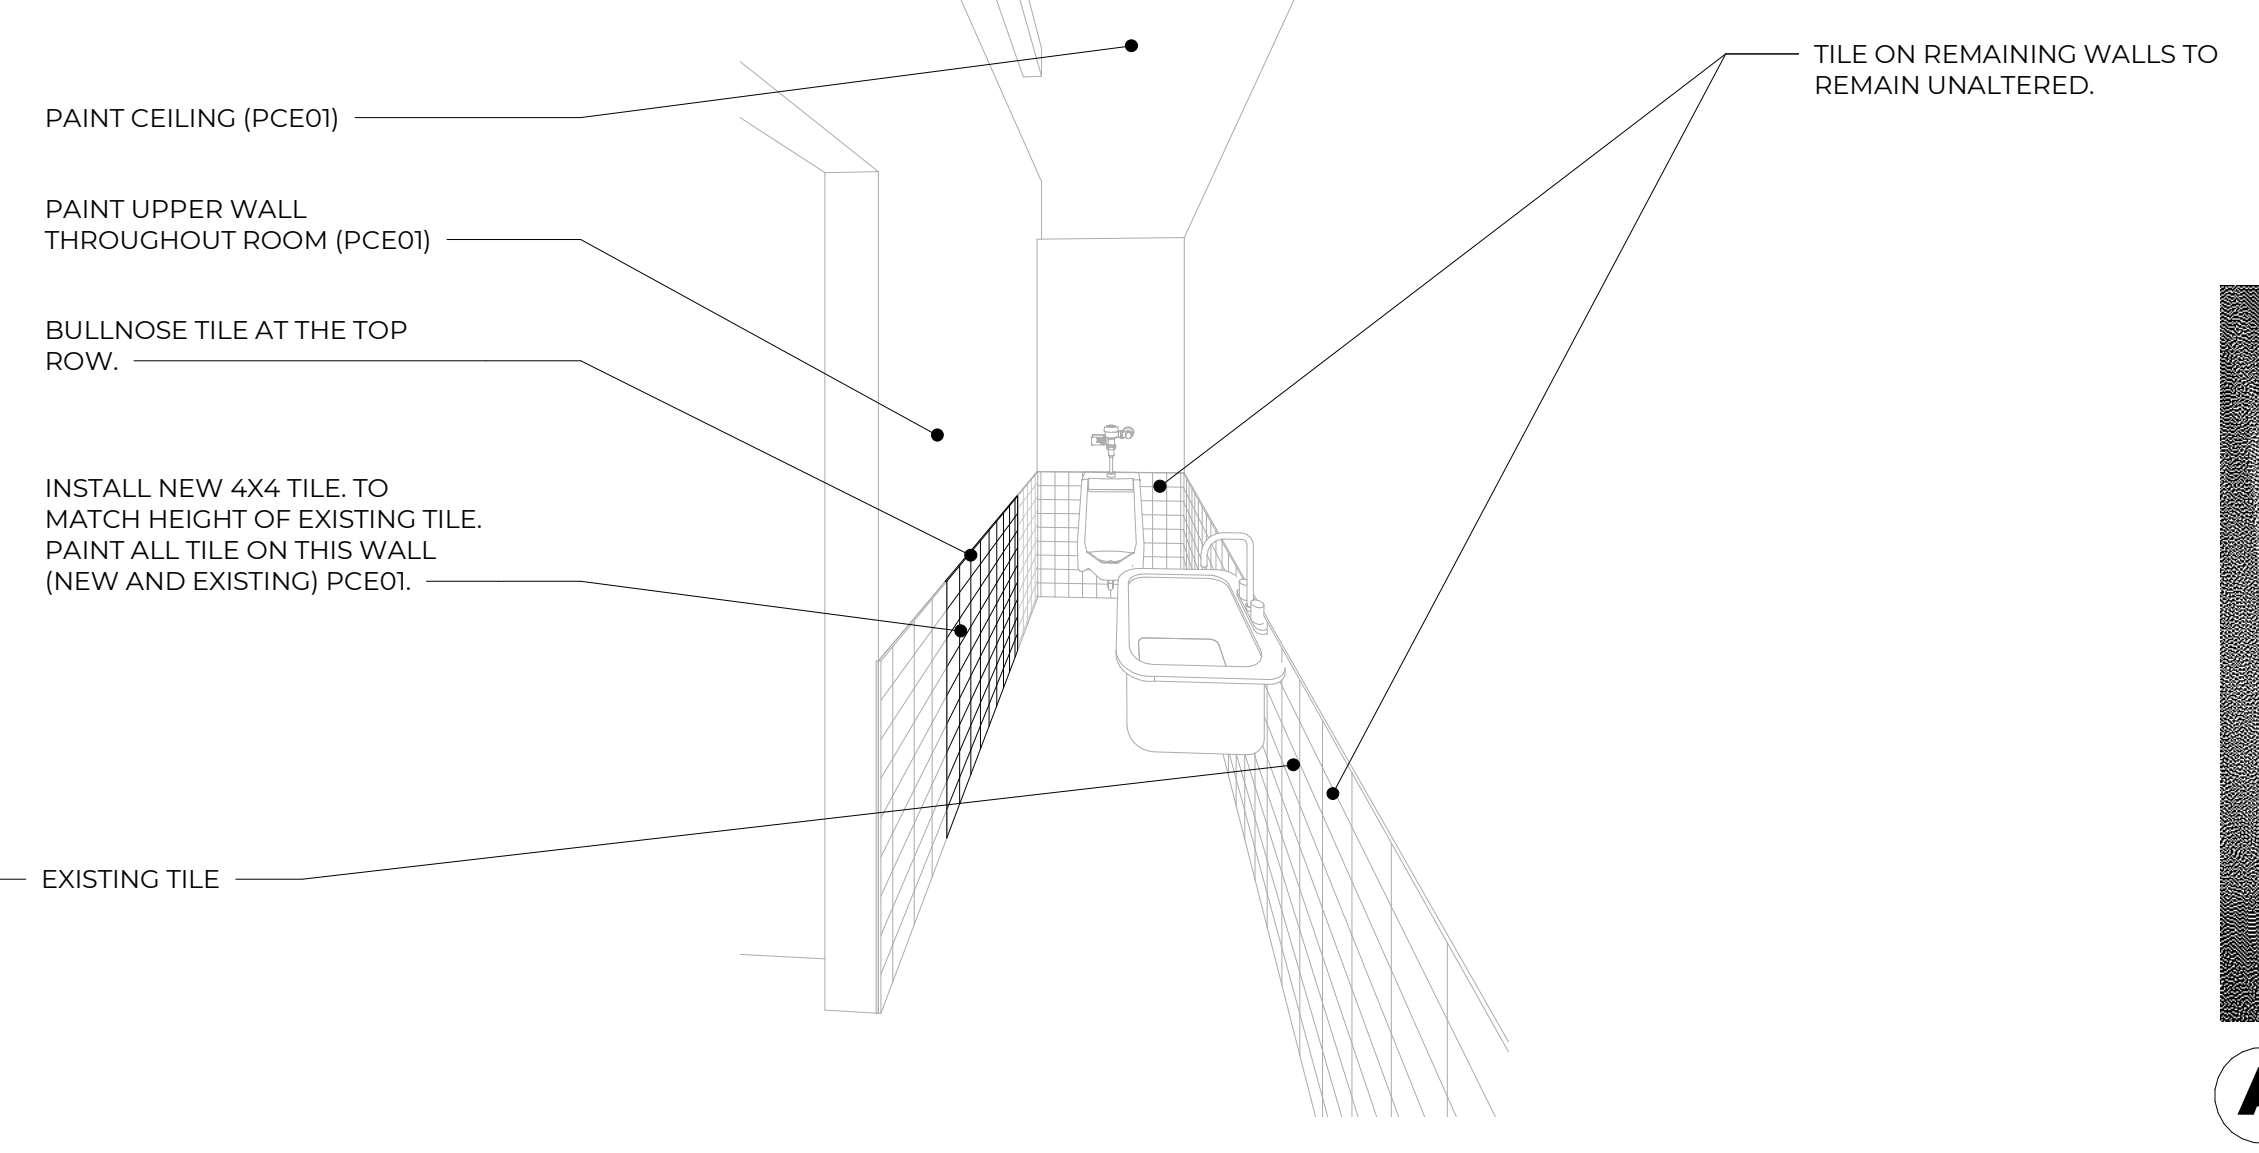


5 115A/ 117A/ 119A TOILET ROOMS - NEW

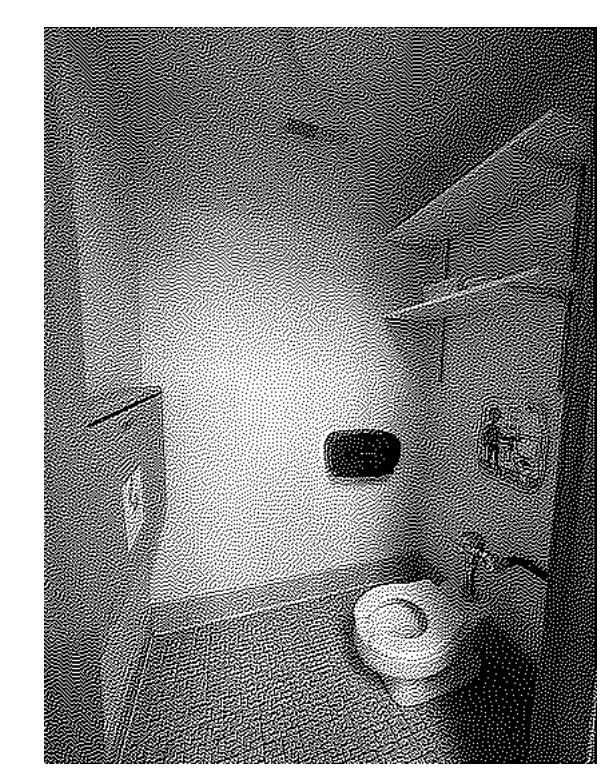


A 103A/ 105A/ 107B TOILET ROOMS - EXISTING CONDITIONS

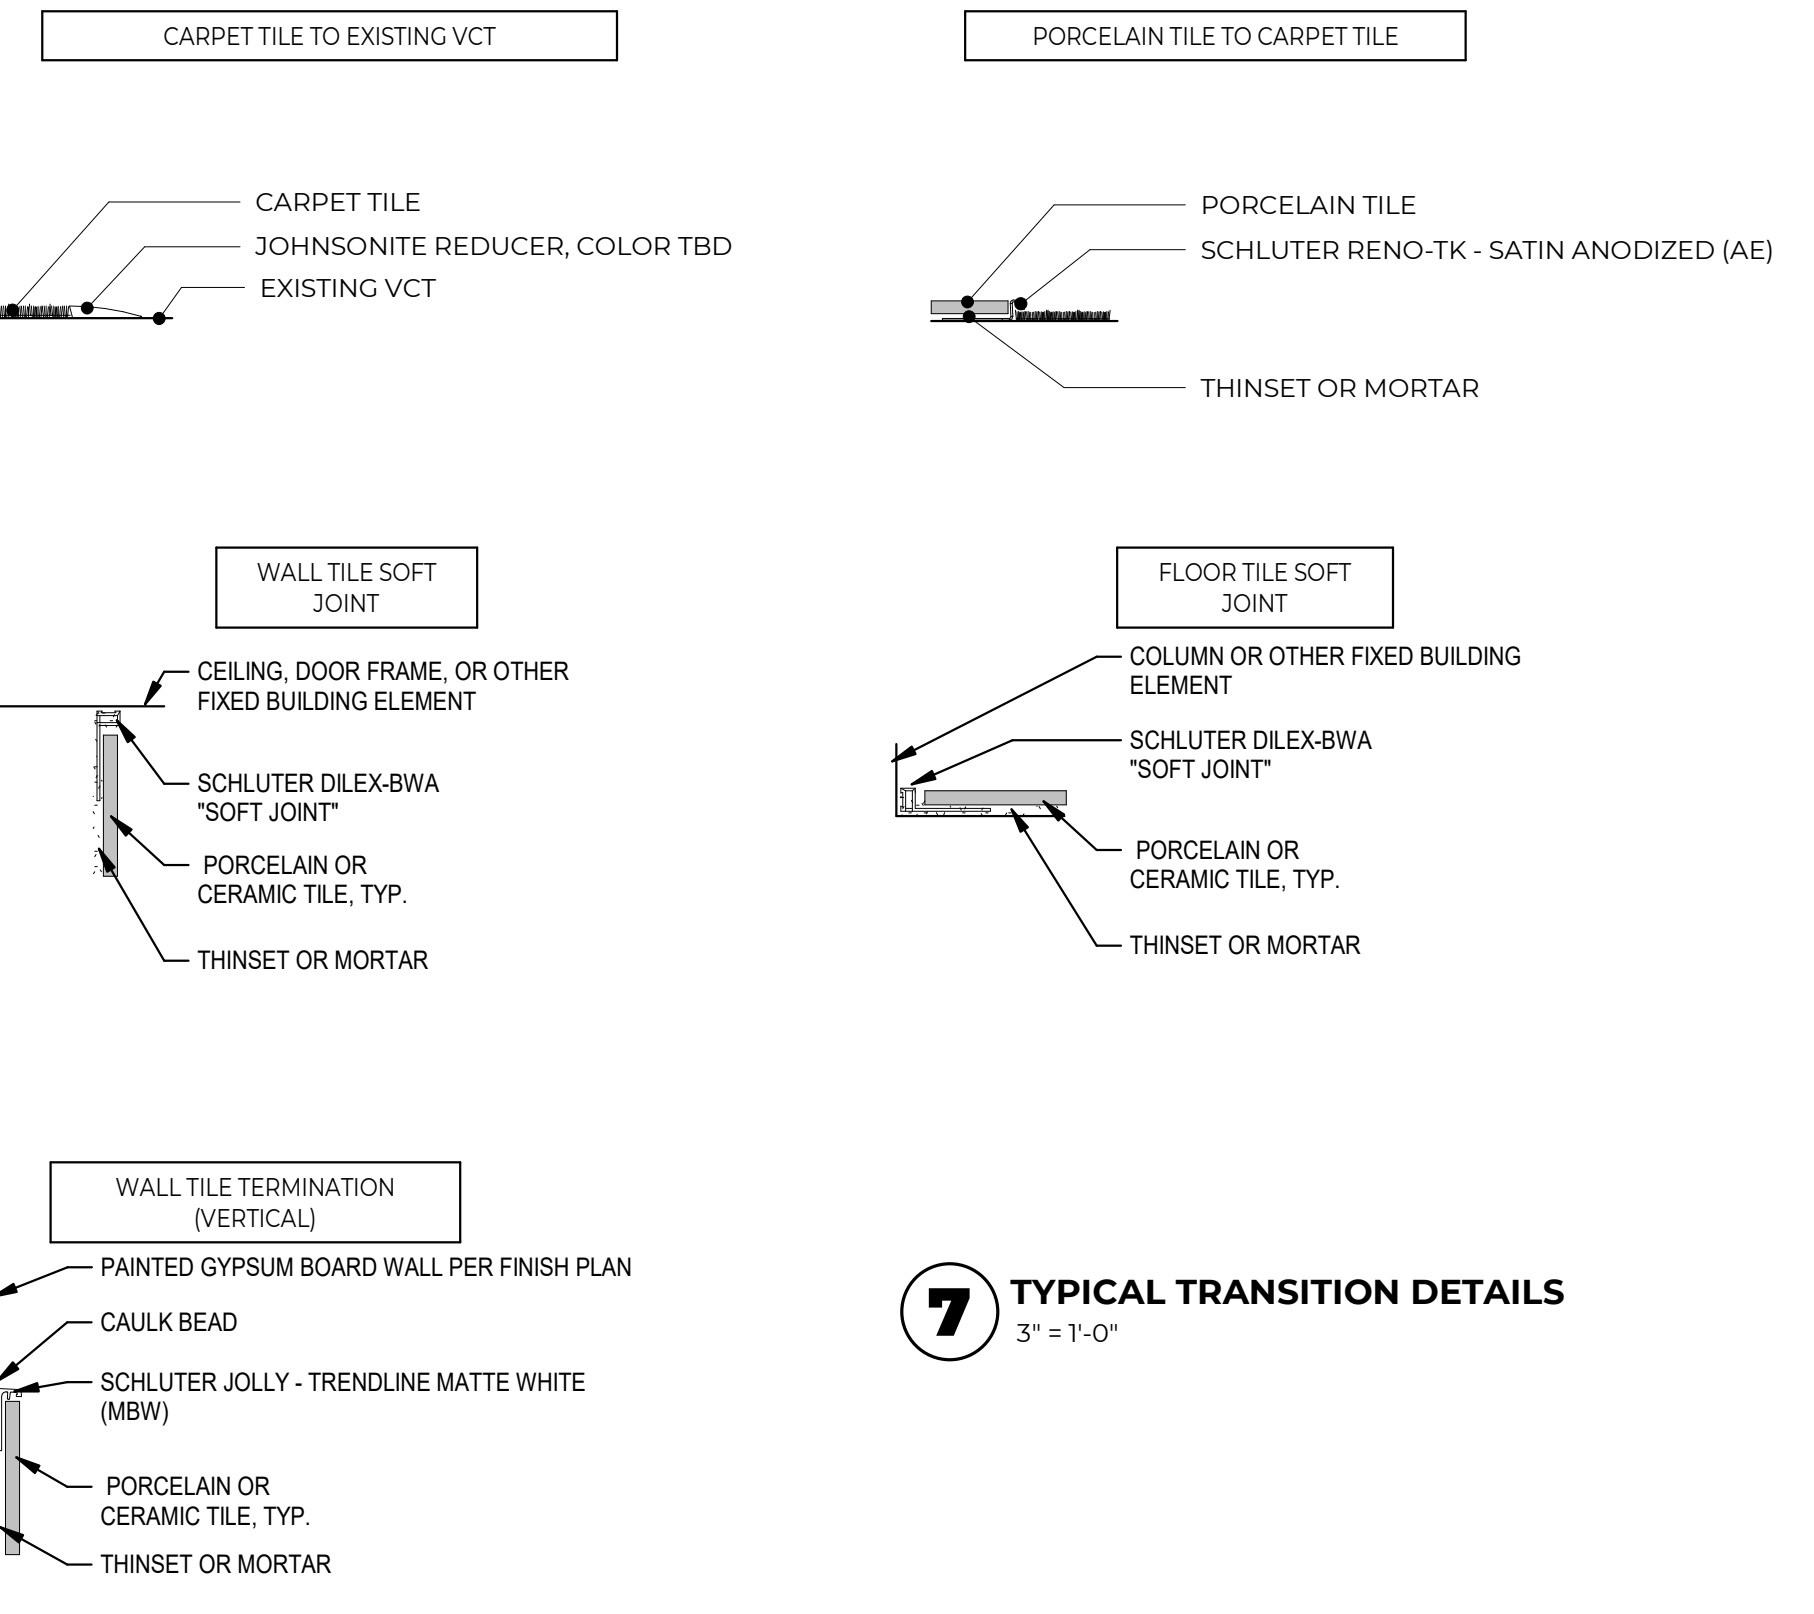


7 TYPICAL TRANSITION DETAILS
3" = 1'-0"

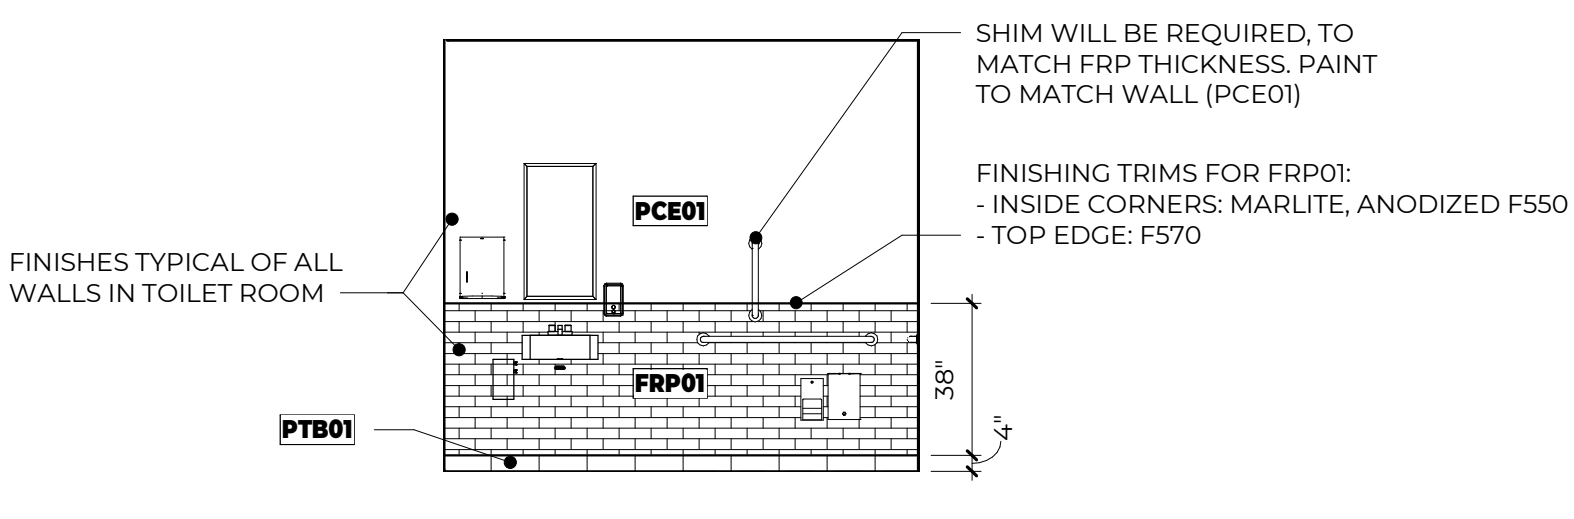


4 158 TOILET ROOM - NORTH
1/4" = 1'-0"

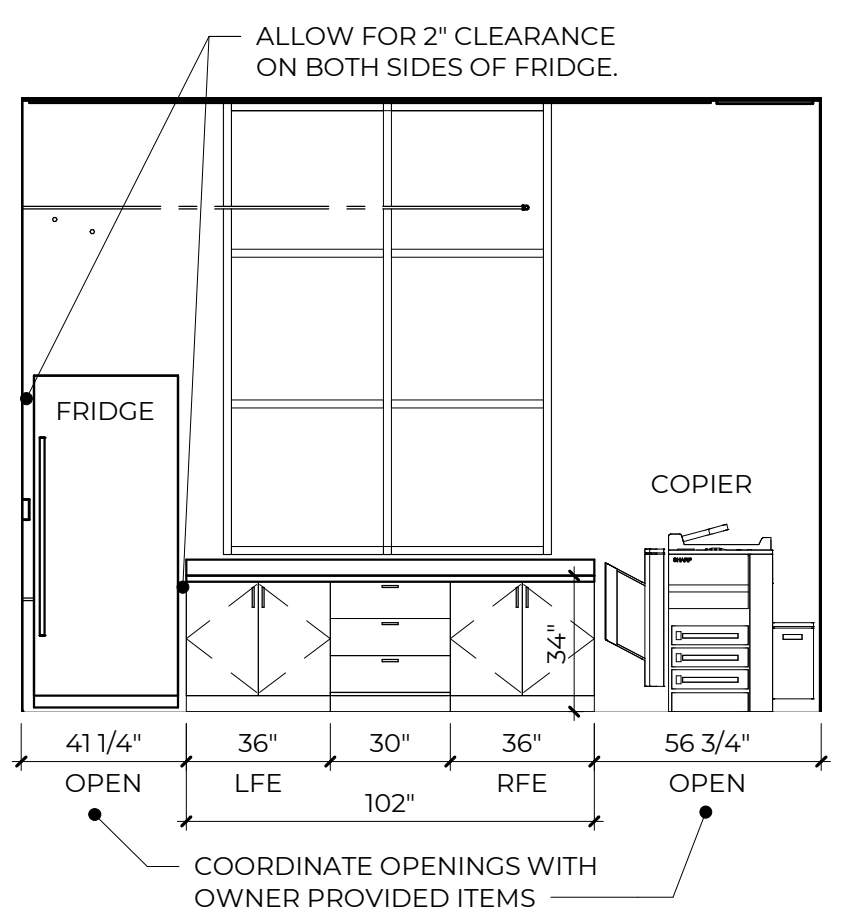

3 157 HEALTH OFFICE - EAST
1/4" = 1'-0"

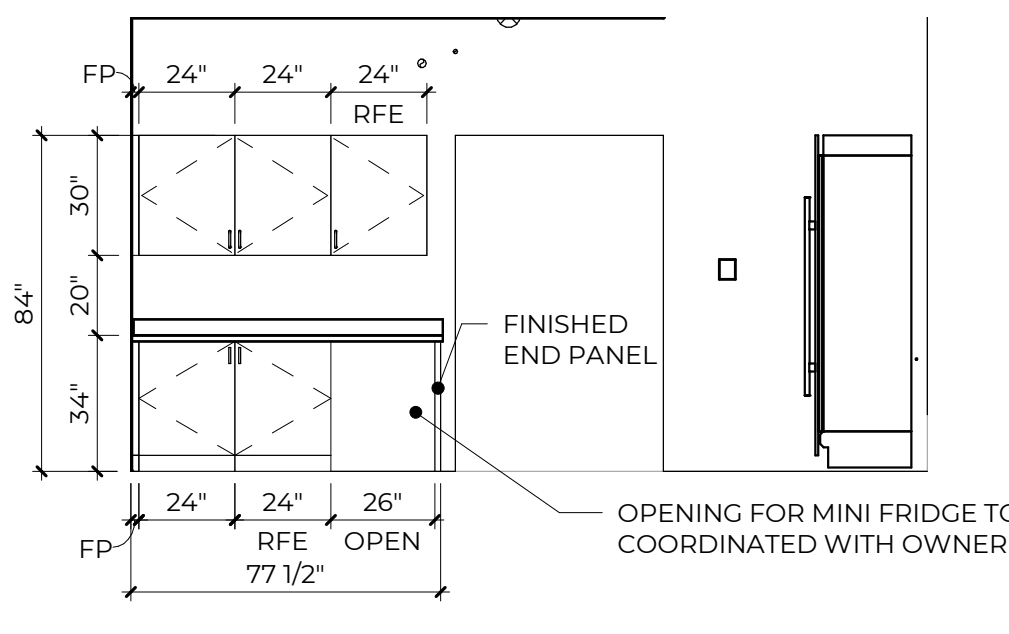

2 157 HEALTH OFFICE - SOUTH
1/4" = 1'-0"

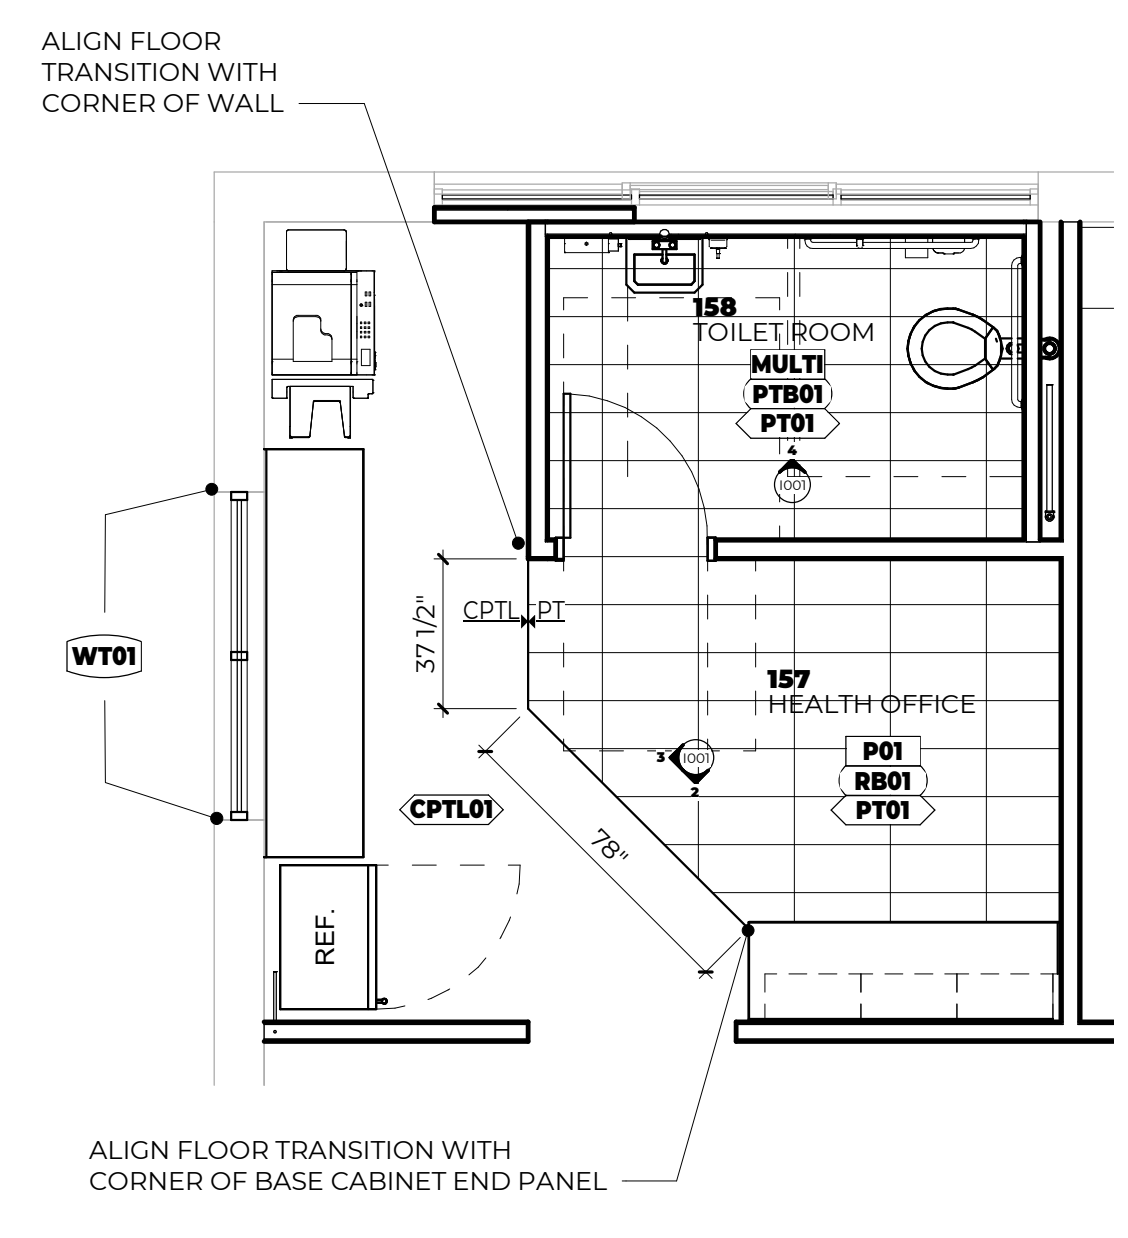

1 158 TOILET ROOM + 157 HEALTH OFFICE - ENLARGED PLAN
1/4" = 1'-0"

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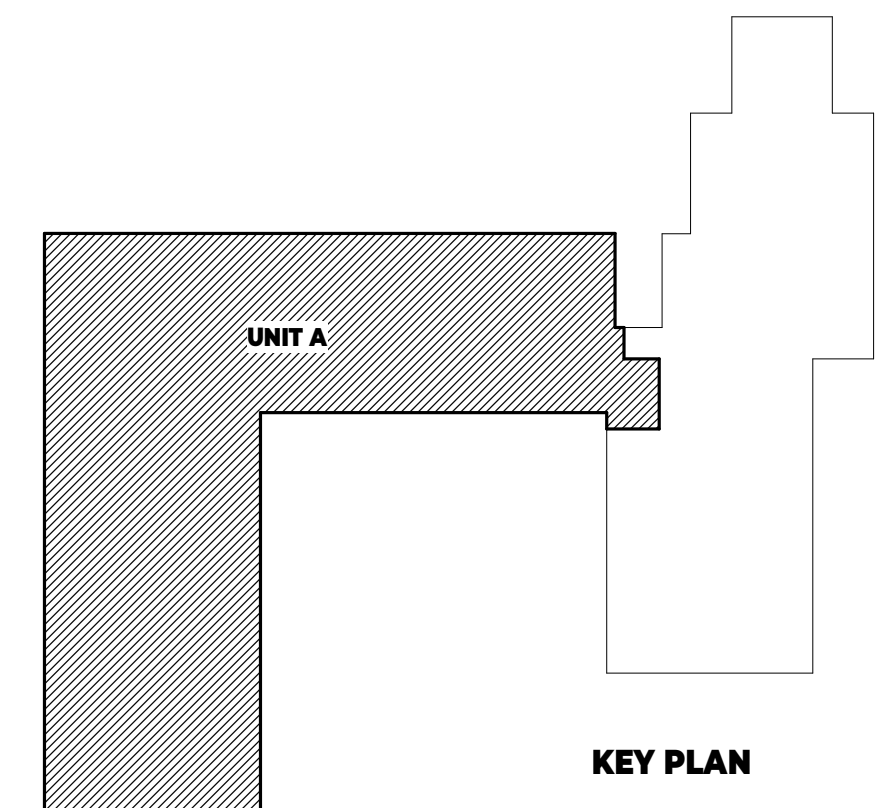
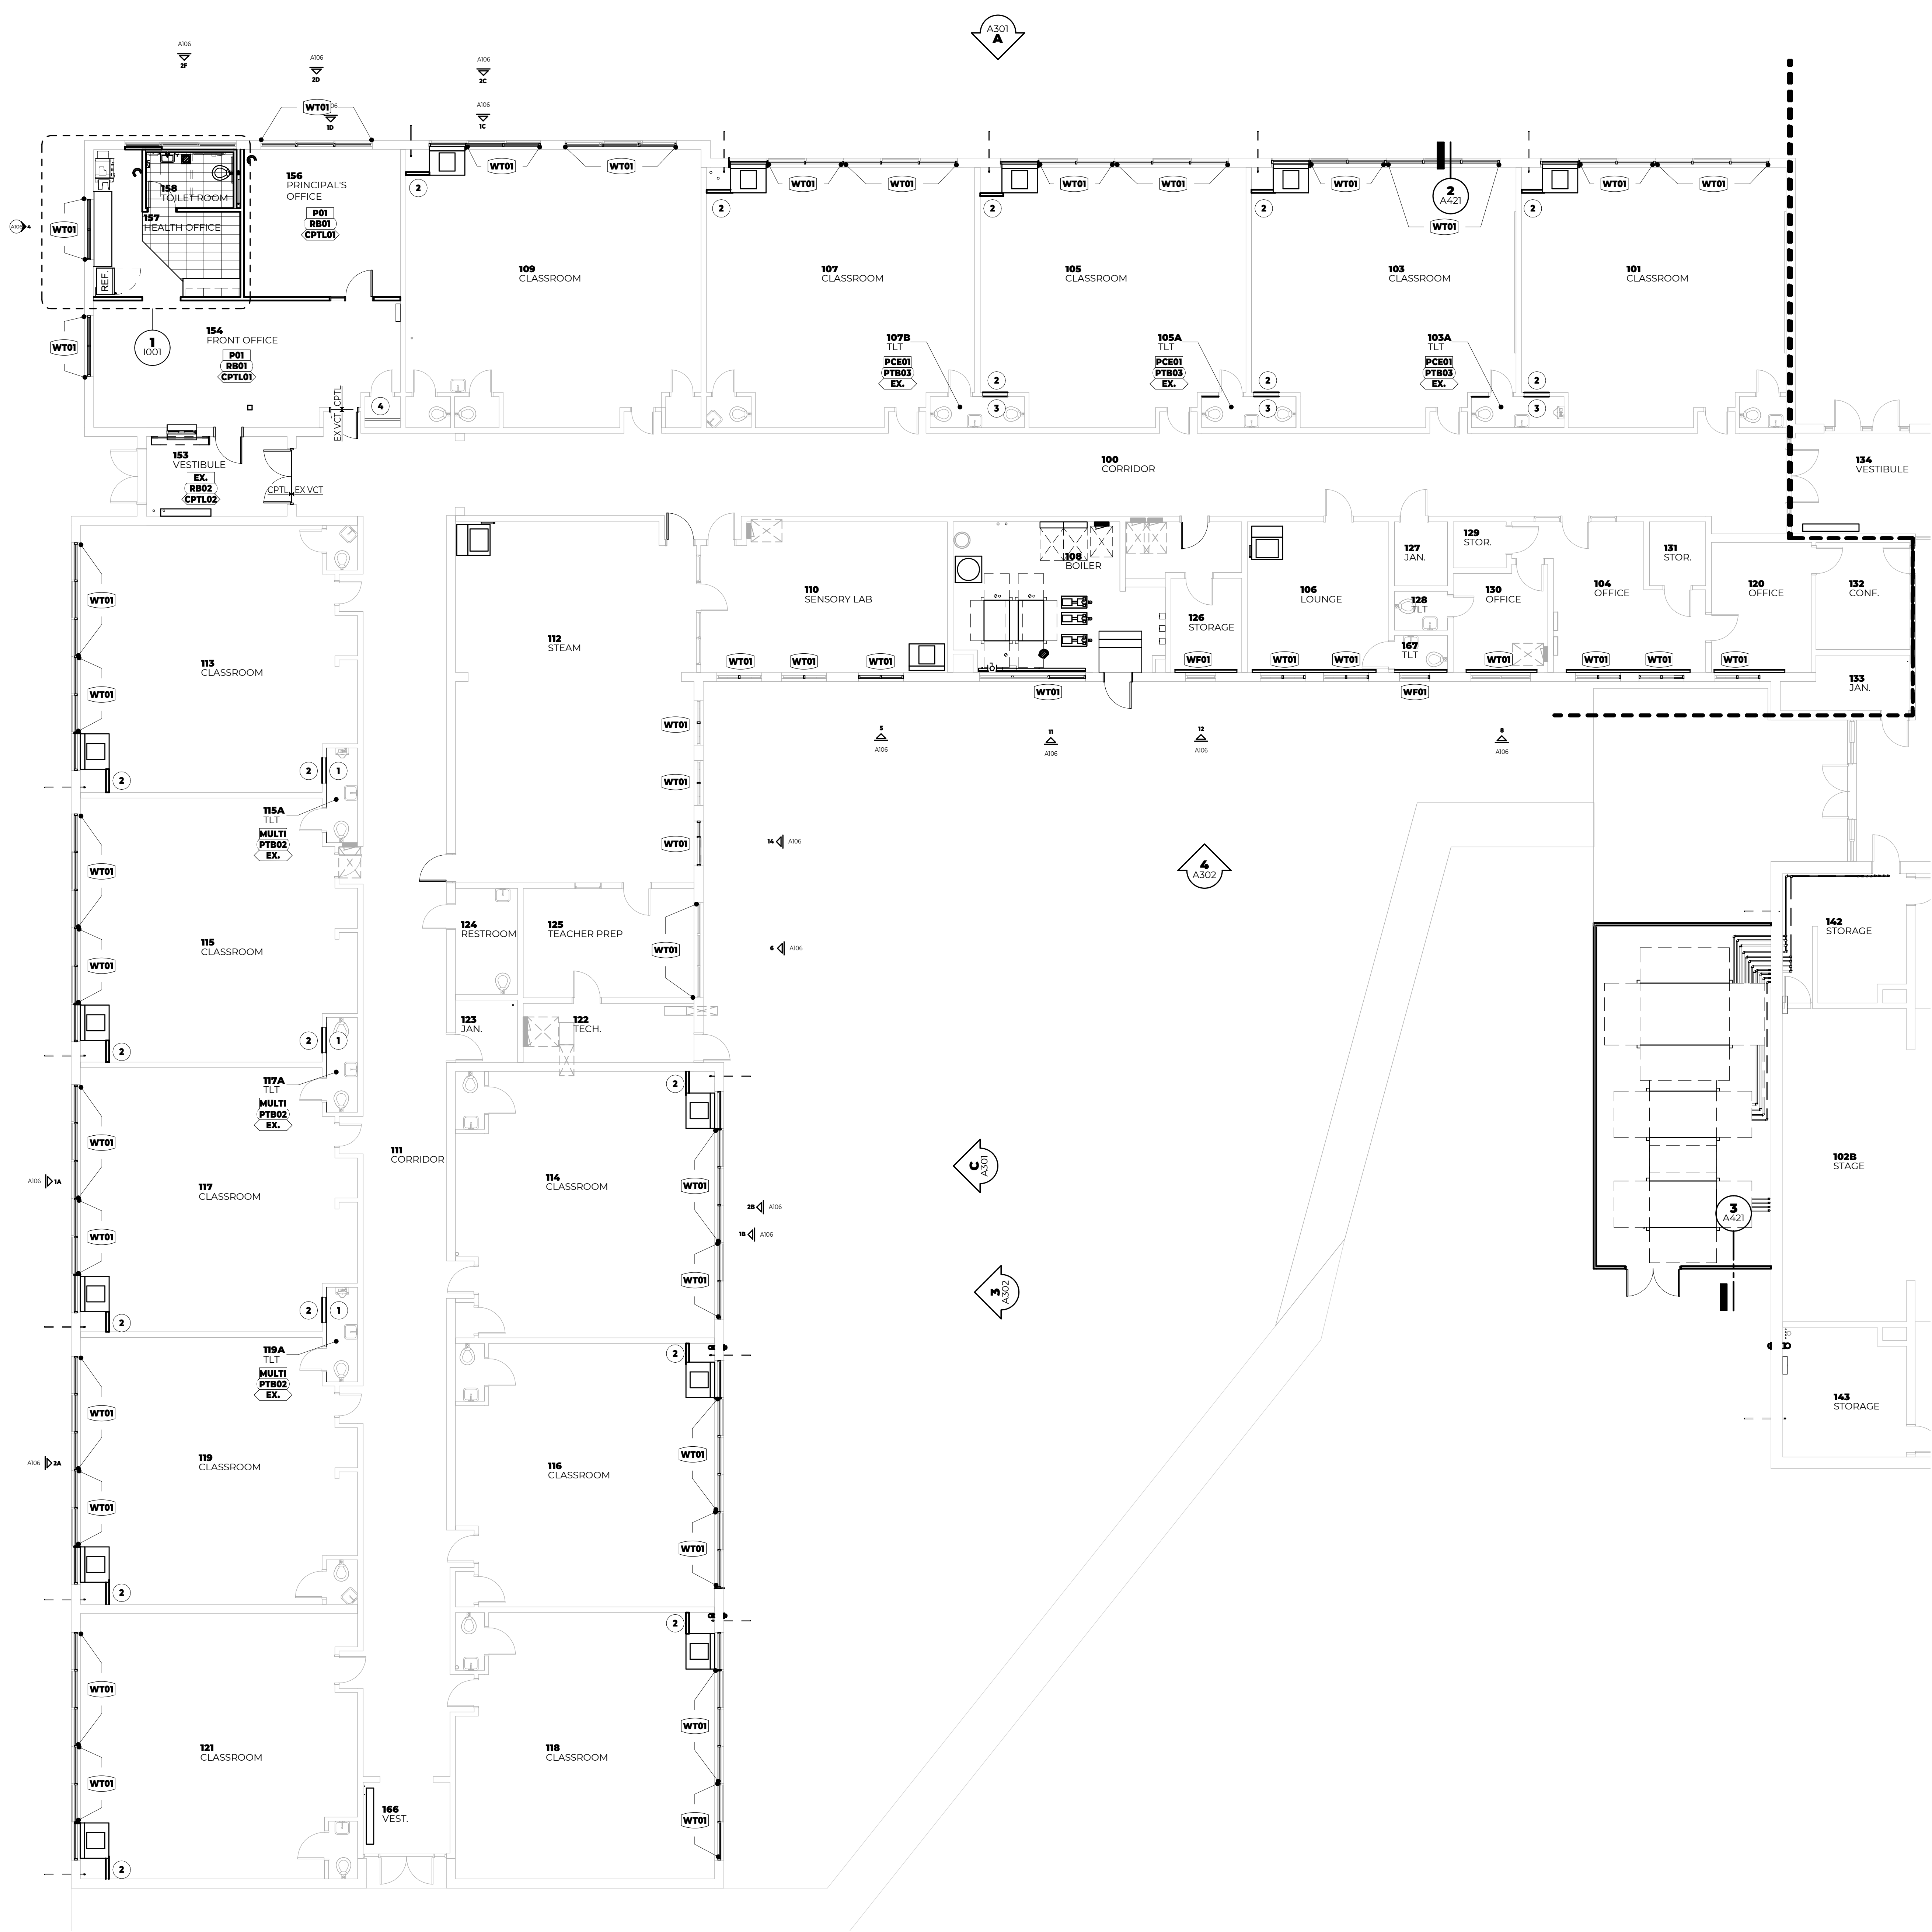
| SYM | DATE | ISSUED FOR |
|---|------------|------------|
| | 03.08.2024 | |
| SHEET NAME MATERIAL SELECTION SCHEDULE | | |
| SHEET NUMBER 1001 | | |
| PROJECT NO. 22.114 | | |

| FINISH PLAN LEGEND | |
|----------------------------|---|
| P-0 | WALL FINISH |
| PTB-0 | FLOOR BASE |
| CPTL-0 | FLOOR FINISH |
| PL0 | COUNTER FINISH |
| PLU | CABINET FINISH (BASE AND UPPER) |
| P-0 | INDICATES EXTENT OF ATYPICAL FINISH |
| WCT0 , CPTL0 | INDICATES FLOOR MATERIAL TRANSITION NOTE - REFER TO MATERIAL SELECTION SCHEDULE REMARKS FOR FLOOR TRANSITION TYPE |
| MULTI | INDICATES MULTIPLE MATERIAL TYPES ON A SURFACE. REFER TO DETAIL OR ELEVATIONS. |
| P | INDICATES MATERIAL PATTERN. REFER TO DETAILS. |

- GENERAL NOTES - INTERIORS**
- REFER TO ARCHITECTURAL FLOOR PLANS AND SPECIFICATION FOR ADDITIONAL INFORMATION ON CONSTRUCTION MATERIALS.
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 - INCLUDE SOFT JOINTS WHERE TILE MEETS CEILING, ADJACENT WALLS, AND DOOR TRIM.
 - INCLUDE DILEX COVE TRIM AT BASE OF TILED WALLS
 - PAINT EXPOSED COLUMNS PCE01

- WINDOW TREATMENT LEGEND**
- | | |
|-------------|---|
| WT01 | MANUAL SINGLE ROLLER SHADE, BASIS OF DESIGN: MERMET E SCREEN, CHARCOAL/COCOA, 3% OPEN |
| WF01 | VINYL WINDOW FILM, SOLYX: WHITE DUSTED MATTE SX0-0550 |
- WINDOW TREATMENTS TO BE PRICED AS A PART OF ALTERNATE 01 AND 02.
 - REFER TO SPECIFICATION FOR MORE INFORMATION.
 - WINDOW TREATMENT TAGS SHOWN ON PLAN REPRESENTS A SINGLE SHADE.
 - REFER TO FLOOR PLANS, EXTERIOR ELEVATIONS AND FRAME TYPES FOR HEIGHT AND WIDTH OF OPENINGS.
 - WINDOW TREATMENTS ARE TO BE MOUNTED INSIDE OF THE WINDOW OPENING FROM HEAD TO SILL AND JAMB TO JAMB, UNLESS NOTED OTHERWISE.
 - VERIFY ALL DIMENSIONS IN FIELD PRIOR TO FABRICATION.


- FLOOR PLAN KEYED NOTES**
- REFER TO SHEET 100, DETAILS 5 AND 6 FOR ADDITIONAL FINISH DIRECTION. SEE PHOTO 'B' FOR EXISTING CONDITIONS.
 - PAINT TO MATCH ADJACENT WALL.
 - WALL INFILL TO RECEIVE NEW TILE BASE AND WALL PAINT ABOVE. SEE PHOTO 'A' ON SHEET 100 FOR EXISTING CONDITIONS.
 - ADD CLOSET ROD.




FIRST FLOOR FINISH PLAN - UNIT A
1/8" = 1'-0"

**MPS GLENSIDE
MUSKEGON PUBLIC SCHOOLS**
1213 W Hackley Ave, Muskegon, MI 49441

| REVISIONS | | |
|--------------------------|------------|------------|
| SYM | DATE | ISSUED FOR |
| | 03.08.2024 | |
| ISSUE DATE | | |
| SHEET NAME | | |
| FIRST FLOOR FINISH PLAN | | |
| SHEET NUMBER | | |
| 1101A | | |
| ©2022 PROJECT NO. 22.114 | | |

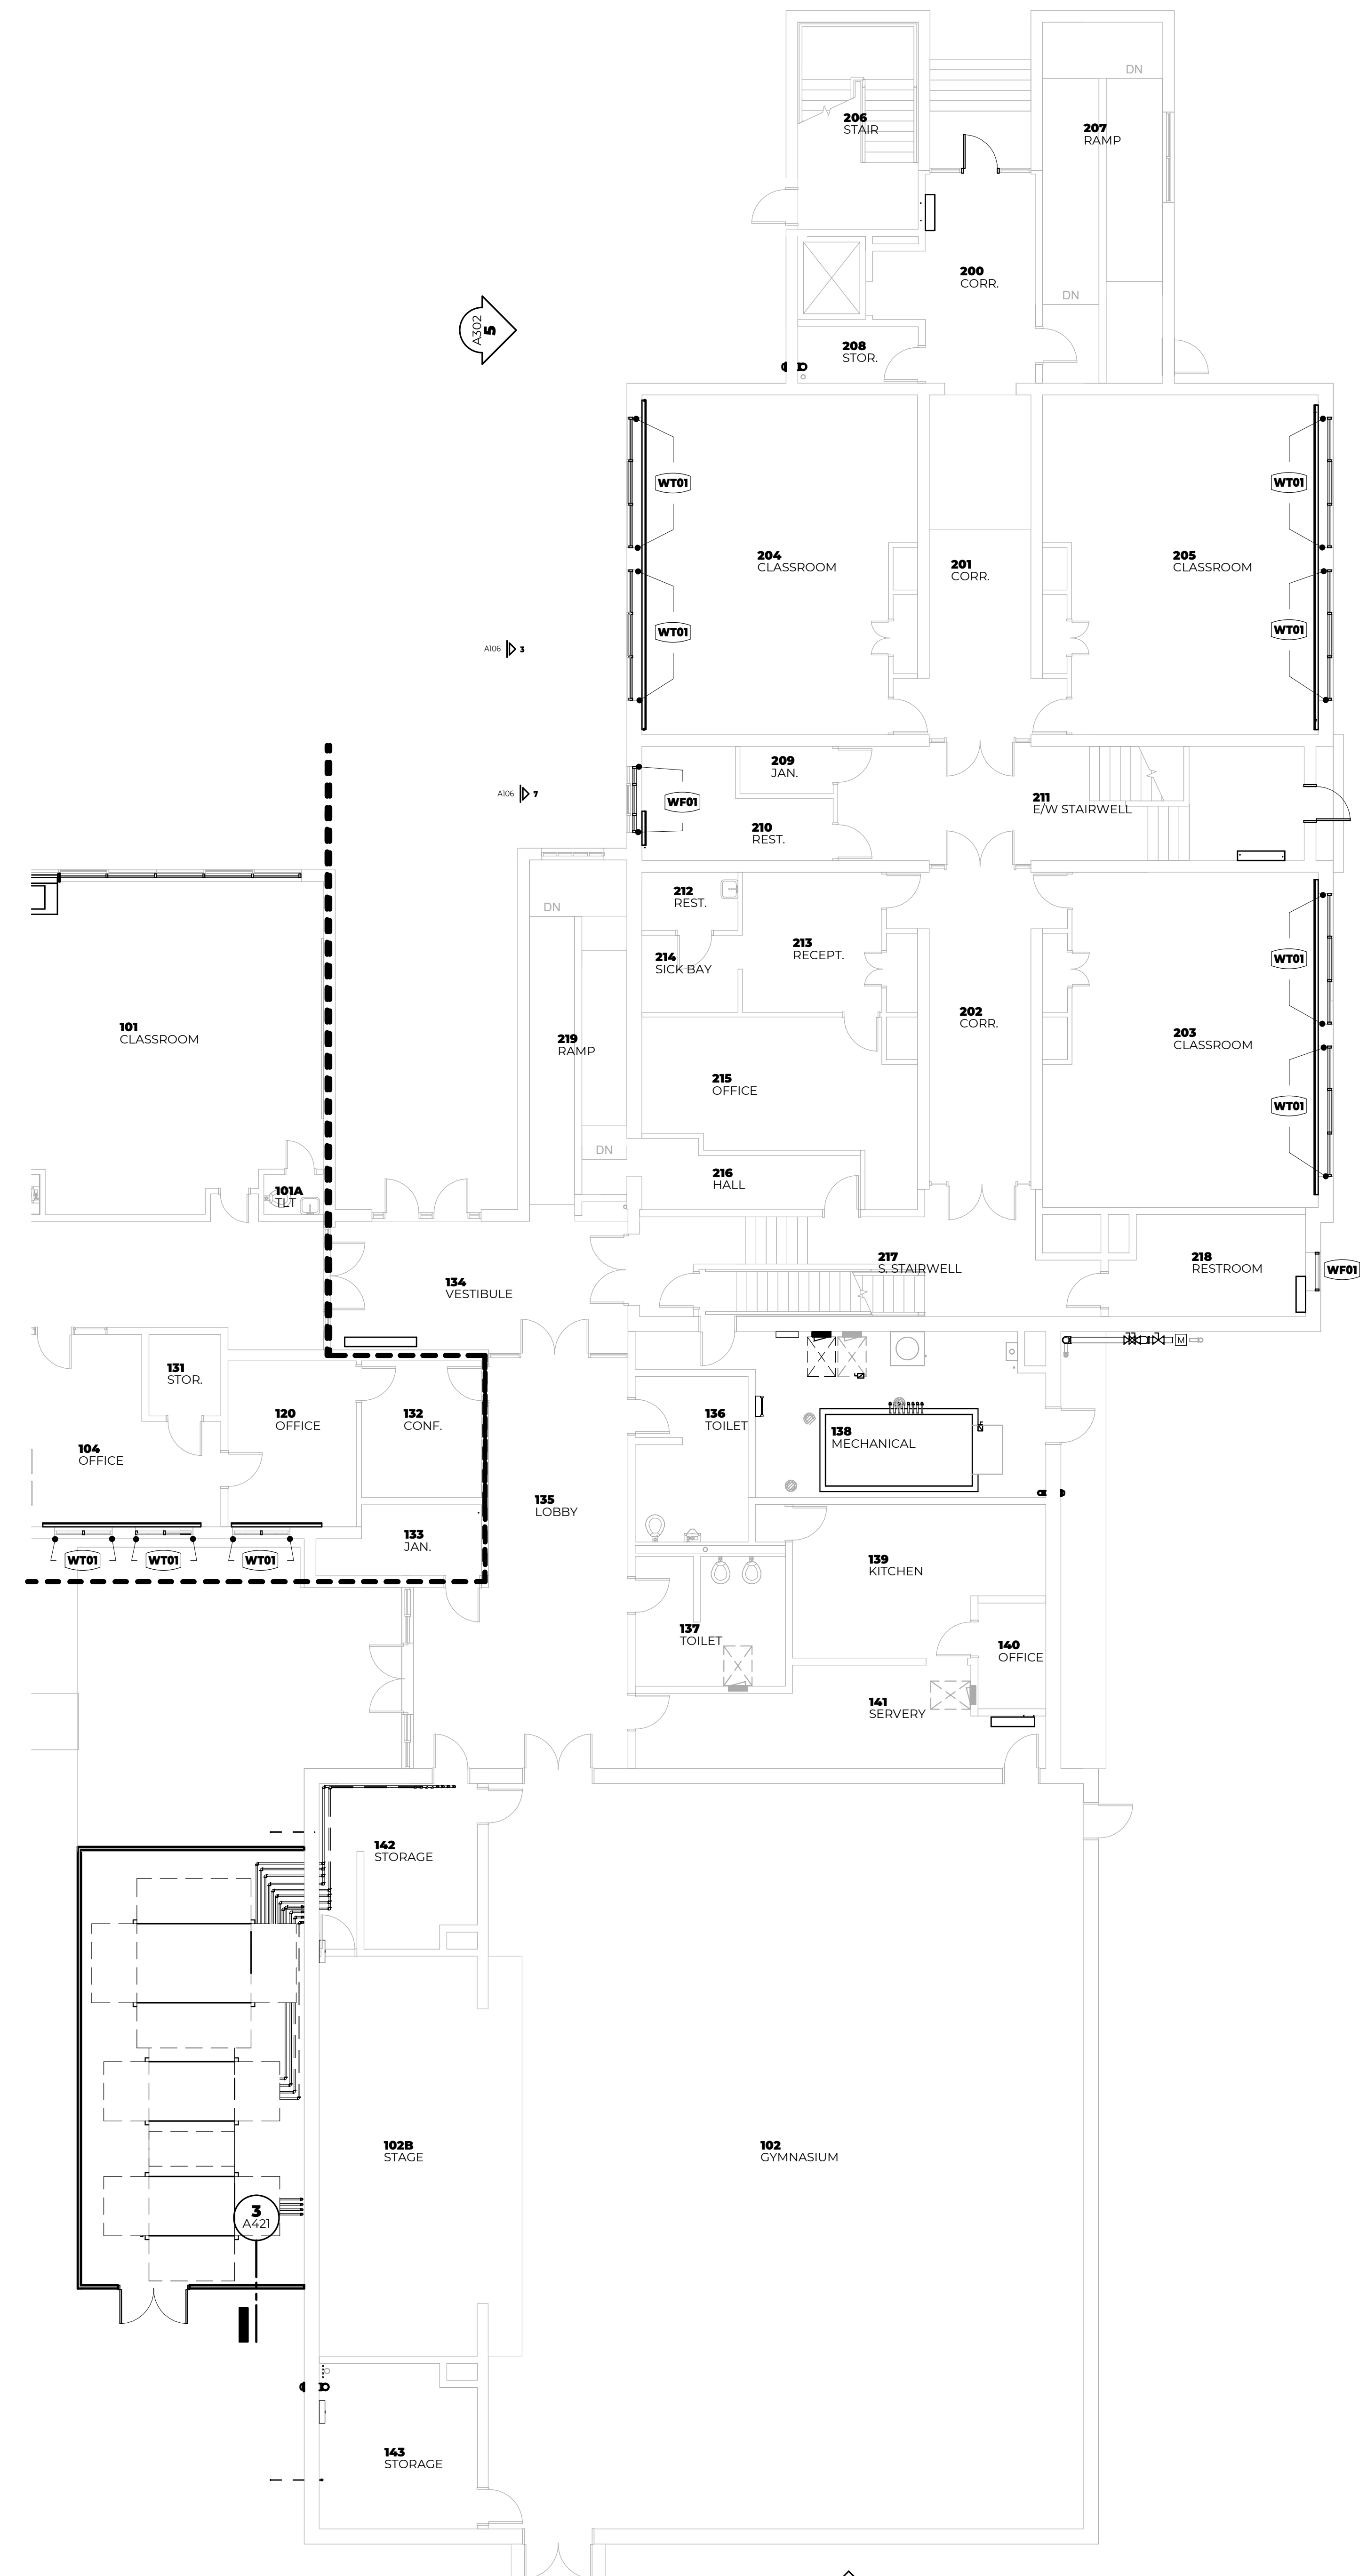

NR TH FIRST FLOOR FINISH PLAN - UNIT B
1/8" = 1'-0"

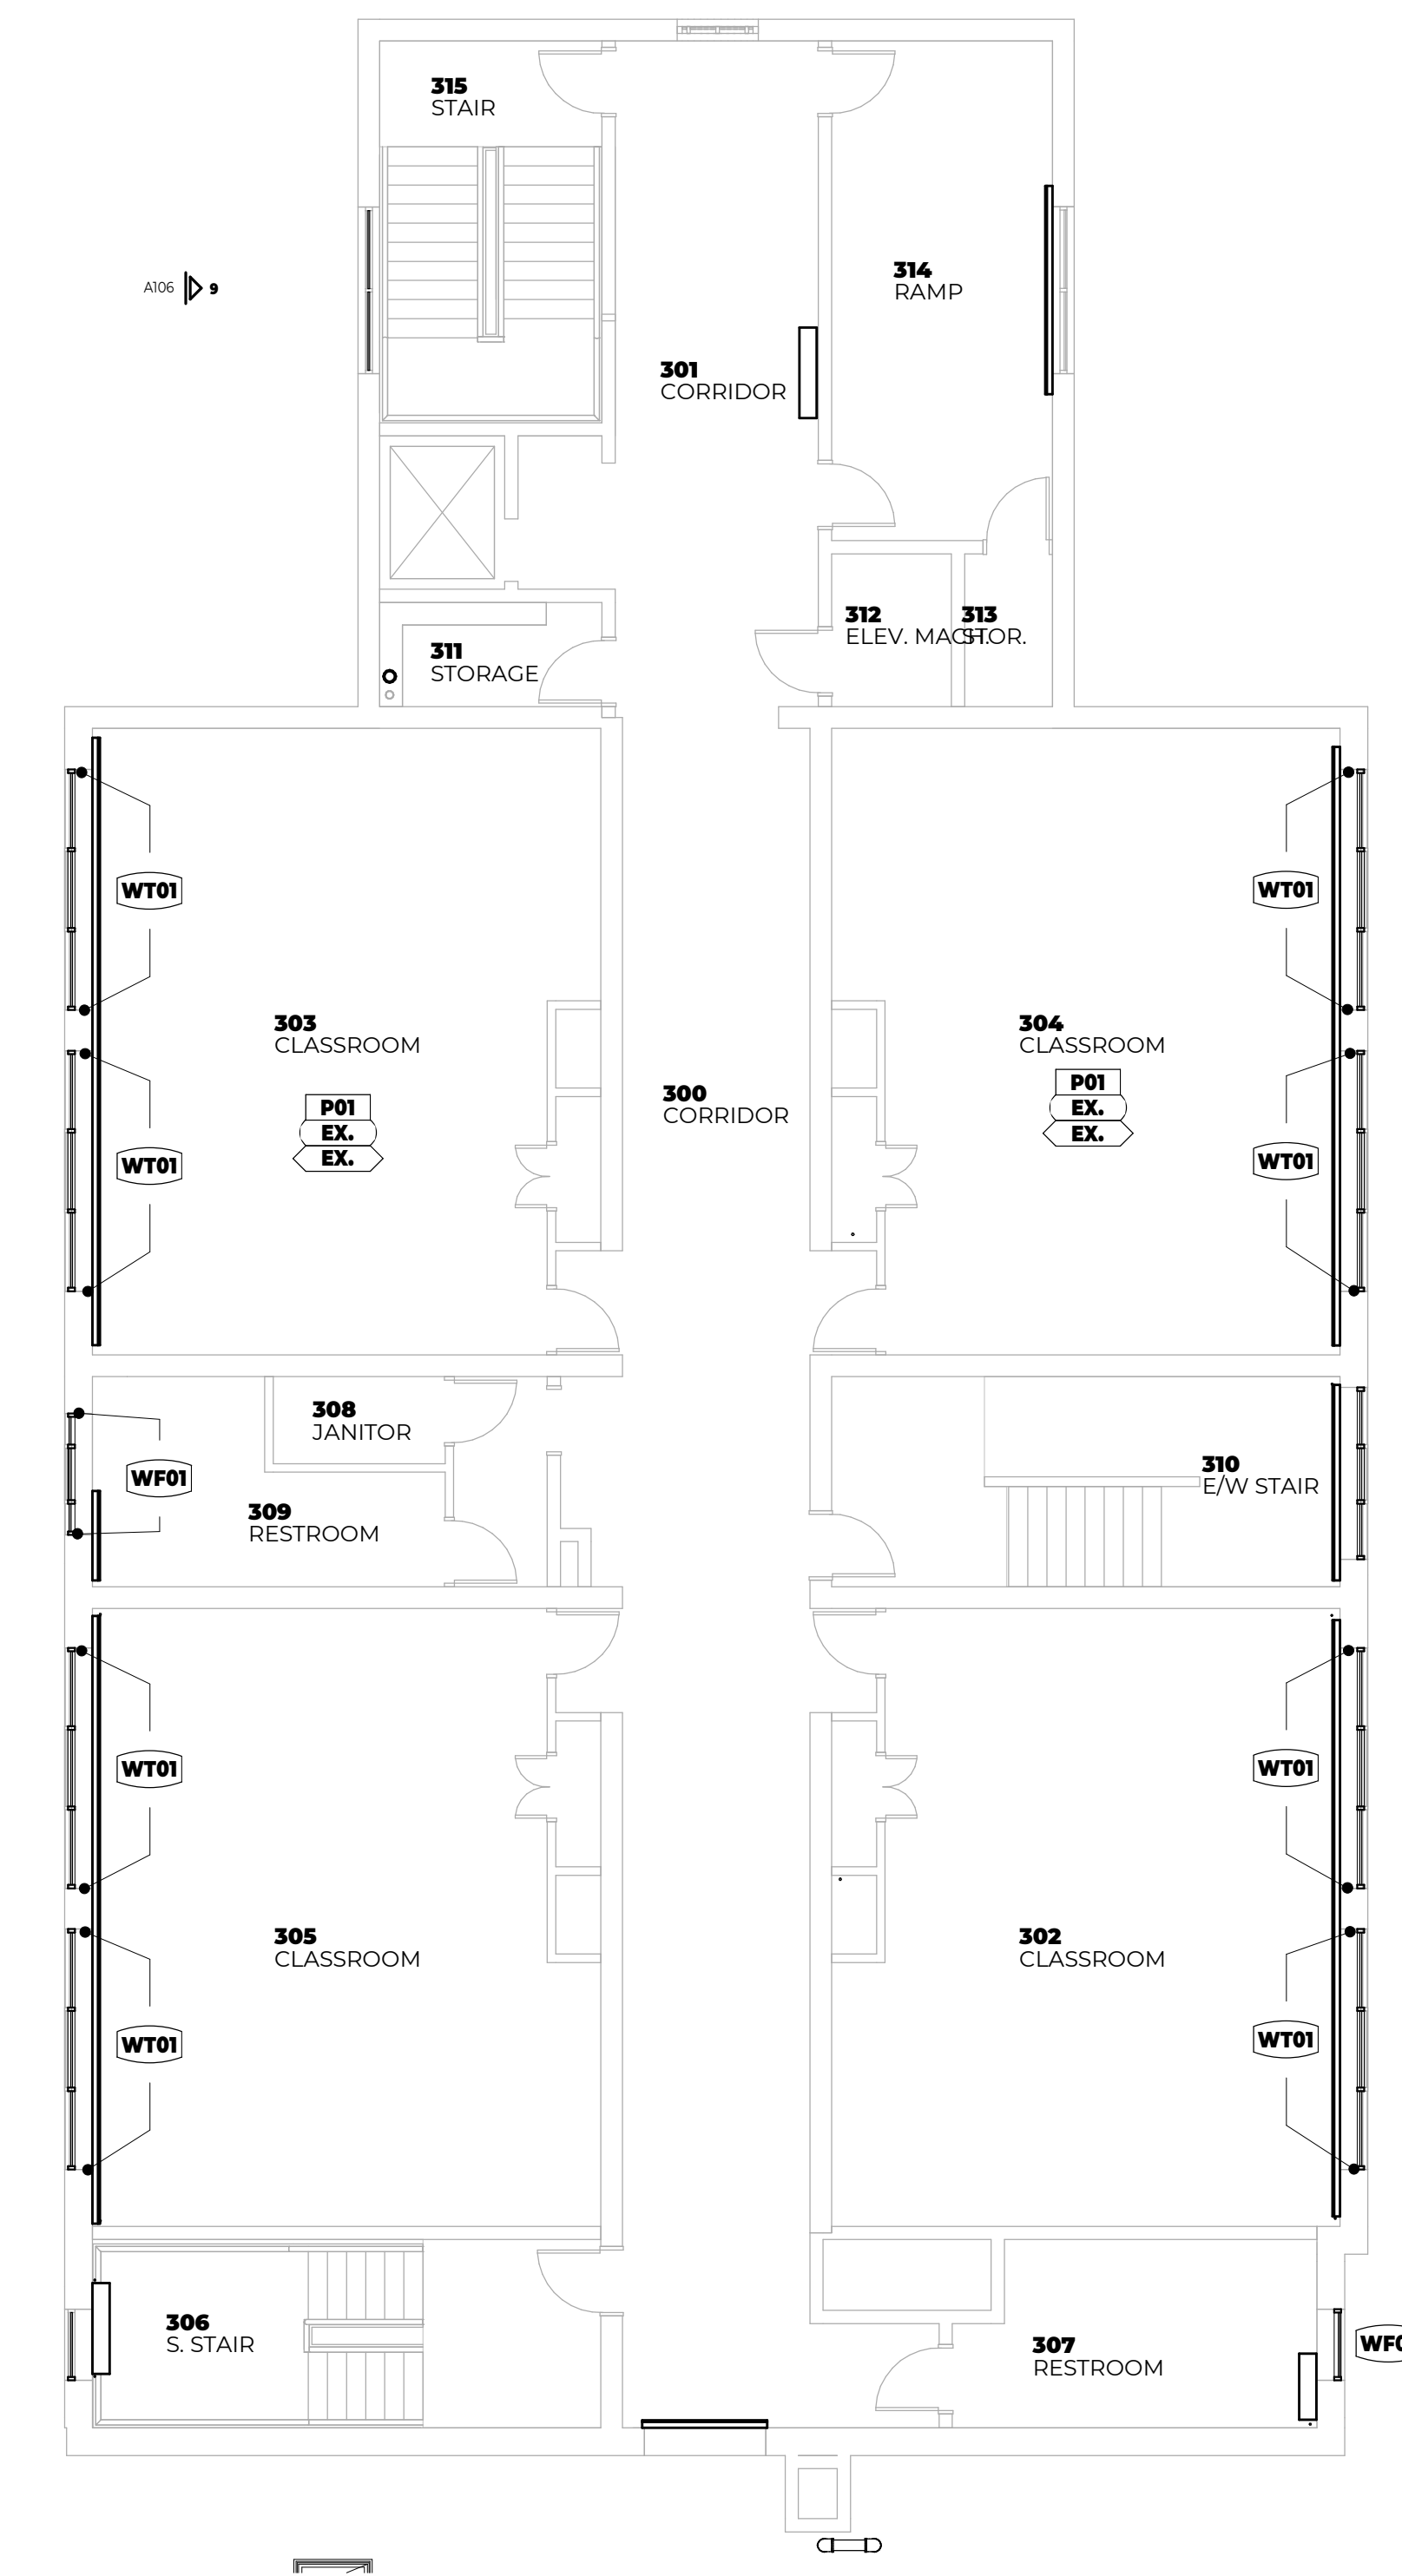


NR TH SECOND FLOOR FINISH PLAN - UNIT B
1/8" = 1'-0"

| FINISH PLAN LEGEND | |
|---------------------|---|
| LC ND | REFER TO MATERIAL SELECTION SCHEDULE FOR FINISH INFORMATION |
| P-0 | WALL FINISH |
| PTB-0 | FLOOR BASE |
| CPTL-0 | FLOOR FINISH |
| PL0 | COUNTER FINISH |
| PL0 | CABINET FINISH (BASE AND UPPER) |
| P-0 | INDICATES EXTENT OF ATYPICAL FINISH |
| YCT, CPT, EX | INDICATES FLOOR MATERIAL TRANSITION NOTE - REFER TO MATERIAL SELECTION SCHEDULE REMARKS FOR FLOOR TRANSITION TYPE |
| MULTI | INDICATES MULTIPLE MATERIAL TYPES ON A SURFACE. REFER TO DETAIL OR ELEVATIONS. |
| P | INDICATES MATERIAL PATTERN. REFER TO DETAILS |

- NOTE GENERAL NOTES - INTERIORS**
- REFER TO ARCHITECTURAL FLOOR PLANS AND SPECIFICATION FOR ADDITIONAL INFORMATION ON CONSTRUCTION MATERIALS.
 - REFER TO REFLECTED CEILING PLANS FOR CEILING FINISH AND HEIGHTS.
 - REFER TO ENLARGED STAIR PLANS AND SECTIONS FOR FINISH COLORS OF STRINGERS AND GUARDRAILS.
 - REFER TO DOOR SCHEDULE FOR FINISH ON DOORS AND FRAMES.
 - REFER TO ENLARGED FINISH PLANS FOR TOILET ROOM FINISHES.
 - FINISH TAGS APPLY TO LIKE MATERIALS IN ENTIRE ROOM. I.E. CASEWORK TAG MAY ONLY CALLOUT ONE RUN OF CASEWORK, BUT ALL CASEWORK IN ROOM RECEIVE THE SAME FINISHES, UNLESS TAGGED DIFFERENTLY.
 - CASEWORK FINISH TAGS DO NOT APPLY TO CUSTOM MILLWORK PIECES. REFER TO ENLARGED MILLWORK DETAILS FOR FINISH MATERIALS.
 - WALL MOUNTED DIFFUSERS, GRILLES, ACCESS PANELS, ELECTRICAL PANELS, ETC. ARE TO BE PAINTED WITH AN OIL-BASED PAINT TO MATCH THE ADJACENT WALL FINISH.
 - CEILING ACCESS PANELS ARE TO BE PAINTED TO MATCH ADJACENT CEILING FINISH.
 - ALL EXPOSED BRICK TO REMAIN EXPOSED (DO NOT PAINT).
 - INCLUDE SOFT JOINTS WHERE TILE MEETS CEILING, ADJACENT WALLS, AND DOOR TRIM.
 - INCLUDE DILEX COVE TRIM AT BASE OF TILED WALLS
 - PAINT EXPOSED COLUMNS PCE01

- LG ND WINDOW TREATMENT LEGEND**
- | | |
|-------------|---|
| WT01 | MANUAL SINGLE ROLLER SHADE, BASIS OF DESIGN: MERMET E SCREEN, CHARCOAL/COCOA, 3% OPEN |
| WF01 | VINYL WINDOW FILM, SOLYX: WHITE DUSTED MATTE SX0-0550 |
- WINDOW TREATMENTS TO BE PRICED AS A PART OF ALTERNATE 01 AND 02.
 - REFER TO SPECIFICATION FOR MORE INFORMATION.
 - WINDOW TREATMENT TAGS SHOWN ON PLAN REPRESENTS A SINGLE SHADE.
 - REFER TO FLOOR PLANS, EXTERIOR ELEVATIONS AND FRAME TYPES FOR HEIGHT AND WIDTH OF OPENINGS.
 - WINDOW TREATMENTS ARE TO BE MOUNTED INSIDE OF THE WINDOW OPENING FROM HEAD TO SILL AND JAMB TO JAMB, UNLESS NOTED OTHERWISE.
 - VERIFY ALL DIMENSIONS IN FIELD PRIOR TO FABRICATION.

- NOTE FLOOR PLAN KEYED NOTES**
- REFER TO SHEET 1001, DETAILS 5 AND 6 FOR ADDITIONAL FINISH DIRECTION. SEE PHOTO 'B' FOR EXISTING CONDITIONS.
 - PAINT TO MATCH ADJACENT WALL.
 - WALL INFILL TO RECEIVE NEW TILE BASE AND WALL. PAINT ABOVE. SEE PHOTO 'A' ON SHEET 1001 FOR EXISTING CONDITIONS.
 - ADD CLOSET ROD.

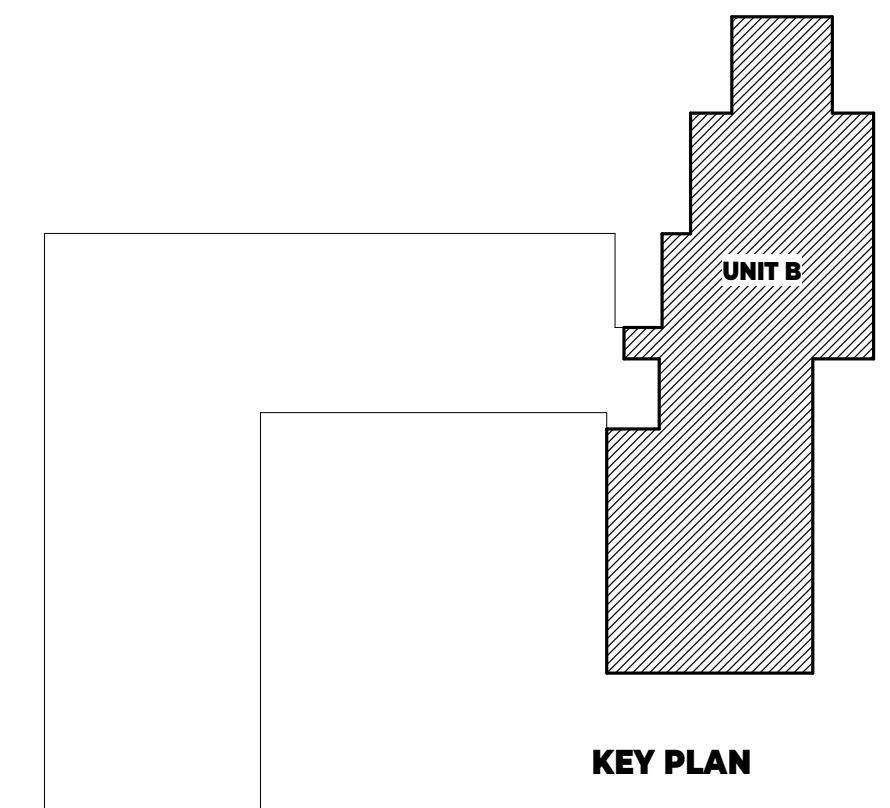

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| REVISIONS | | |
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| SYM | DATE | ISSUED FOR |
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ISSUE DATE: 03.08.2024

SHEET NAME: SECOND FLOOR FINISH PLAN

SHEET NUMBER: **1101B**

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